Design Review & Historic Preservation Board Agenda July 23, 2020

HISTORIC PRESERVATION DISCUSSION

RESIDENTIAL APPLICATION FOR REVIEW

• 323 East Street

The Applicant is requesting design review for a kitchen and bath addition. The addition will be approximately 340 sq. ft. and will be located to the rear of the existing home.

• 355 East Street

The Applicant is requesting design review for the garage extension. The extension will be approximately 72 sq. ft. and will be located behind the 3rd bay of the garage.

RESIDENTIAL APPLICATION FOR REVIEW – NEW

• 16 Ravenna Crescent

The Applicant is requesting design review for the construction of a two story single family home. The home will be approximately 2800 sq. ft. and will be located in the Coventry Ridge Subdivision.

• 4 San Rafael Drive

The Applicant is requesting design review for the construction of a new single family home. The home will be approximately 6440 sq. ft. of livable space and will be located on a vacant lot in the San Rafael Drive neighborhood.

• 23 & 25 Skylight Trail

The Applicant is returning to request design review for the proposed construction of a new town home dwelling. The proposed building will consist of 2 attached single family dwellings sharing a common wall. Lot 40 (23 Skylight Trail) will be approximately 2013 sq. ft. and Lot 39 (25 Skylight Trail) will be 2000 sq. ft. The town homes will be located in the new Alpine Ridge development.

• 40 Skylight Trail

The Applicant is requesting design review for the construction of a community building. The building will be approximately 820 sq. ft. and will be located in the Alpine Ridge Subdivision.

• 25 Parker Drive

The applicant is requesting Design Review for the proposed construction of an addition and an oversized accessory structure. The proposed construction is a 2 story 1,007 Sq. Ft. addition and a 468 Sq. Ft. workshop/Storage structure. The addition will create living space and a new garage. The Zoning Board of Appeals has heard these applications on July 20, 2020.

COMMERCIAL APPLICATION

• 3001 Monroe Avenue

The Applicant is requesting design review for the addition of a business identification sign. The sign will be approximately 10.5 sq. ft. and will identify "Blonsky Family Chiropractic".

OTHER – REVIEW OF 7/9/2020 MINUTES

DRHPB Meeting Agenda July 23, 2020 Page 2 of 2

How to view the meeting:

- 1. Zoom
 - In your web browser, go to https://townofpittsford.zoom.us/j/81368200858?pwd=QmNRMFIYOGczSjlxUmZsc2lzRVZMZz09
 - You will be connected to the meeting.
- 2. Telephone
 - You can access the meeting by phone. Use any of the phone numbers below, then enter the meeting ID when prompted. The Meeting ID is **813 6820 0858**. No password is necessary.

(929) 205-6099	(312) 626-6799
(253) 215-8782	(301) 715-8592
(346) 248-7799	(669) 900-6833

Draft Design Review and Historic Preservation Board Minutes July 9, 2020

PRESENT

Dirk Schneider, Chairman; Paul Whitbeck, Bonnie Salem, Kathleen Cristman, John Mitchell

ALSO PRESENT

Mark Lenzi, Building Inspector; Susan Donnelly, Secretary to the Board; Robert Koegel, Town Attorney

Proceedings of a regular meeting of the Pittsford Design Review and Historic Preservation Board were held on Thursday, June 25 at 6:00 P.M. local time. The meeting took place with Board members and applicants participating remotely using Zoom.

ABSENT

Leticia Fornataro, David Wigg

Dirk Schneider opened the meeting at 6:00 pm.

HISTORIC PRESERVATION DISCUSSION

The Board discussed the reception for inventoried homeowners. A tentative date of November 5 is now preferred. This is a good date for the speaker Wayne Goodman to attend. Letters should be sent out a month in advance in October.

Bonnie Salem discussed the banners for the historic district. Although Mr. Beckford was not in attendance at this meeting, it was reported by Dirk Schneider that he sent communication to the Town finance director regarding approval for the funds to purchase them. Dirk indicated that he will forward this communication from Kevin Beckford to Allen Reitz and Mark Lenzi.

RESIDENTIAL APPLICATION FOR REVIEW

• 60 Falcon Trail

The Applicant is requesting design and review for a kitchen addition. The addition will be approximately 95 sq. ft. and will be located to the rear of the home.

The homeowner, Kristin Dawe was present to discuss the application with the Board.

The proposed project will be to add an addition to expand the kitchen to include a 10' $x 9 \frac{1}{2}$ ' kitchen nook. The roof will be a hip roof.

The Board felt this was a fitting addition to the home.

Kathleen Cristman moved to accept the application as submitted.

Paul Whitbeck seconded.

Dirk Schneider called for a roll call vote.

Schneider voted aye. Salem voted aye. Mitchell voted aye. Cristman voted aye. Whitbeck voted aye.

RESIDENTIAL APPLICATION FOR REVIEW – NEW

• 23 & 25 Skylight Drive

The Applicant is requesting design review for the proposed construction of a new town home dwelling. The proposed building will consist of 2 attached single family dwellings sharing a common wall. Lot 40 (23 Skylight Trail) will be approximately 2013 sq. ft. and Lot 39 (25 Skylight Trail) will be 2000 sq. ft. The town homes will be located in the new Alpine Ridge development.

Jeff Brokaw of Morrell Builders was present to discuss this application.

The submission from the applicant provided provided much confusion with the Board.

In general it was determined that it was difficult for the Board to discern given the submission of many different colors of X's and no key to those X's which unit was proposed to be built.

Once this was determined which unit would be built and after lengthy discussion, it was determined that the color rendering provided did not reflect the windows, garage doors or orientation of the garage that are proposed to be built and was only intended as a color representation of one of the units. Mr. Brokaw indicated that the blueprint drawing with front facing garages is the unit proposed to be built. However, the "color rendering" provided showed only the Booth Bay Blue coloration and not the Light Mist coloration of the second unit as Mr. Brokaw indicated that this townhouse unit would be two toned as indicated in the key plan. There was additional confusion from the key as to what the building step color meant. Mr. Brokaw explained the assigned color indicates which unit is to be stepped.

Several Board members indicated again that the use of three materials is overkill and "too busy". When the Board inquired what type of stone is going to be used Mr. Brokaw indicated he did not know that it is drawn on the blueprint to represent that stone is present. Mr. Brokaw stated three materials are what customers want and the Board has approved this at other locations. The Board indicated that it is time to put

something in place as multiple materials are counter to the recommendations of the Design Guidelines. The Board feels this is a concern and it is not too late to correct the situation at this subdivision.

Bonnie Salem noted her concerns about the lack of front door diversity. She quoted from the meeting minutes of October 19, 2019 where Jeff Morrell indicated that the design of the front doors could be "tweaked" to provide greater diversity. Bonnie asked if this is going to happen. Jeff Brokaw indicated he had no knowledge of this conversation with Mr. Morrell. Bonnie also inquired whether the same garage door would be used for all garages and Mr. Brokaw indicated yes. Bonnie Salem indicated that this lends to excessive similarity which is also discouraged in the guidelines. It was also noted that an overwhelming majority of the homes (34) have front loaded garages also discouraged in the guidelines. Mark Lenzi indicated that this parcel is approved as a subdivision and the number of units limits the amount of side load garages which can be used. The Board noted that the approval goes against what is outlined in the guidelines.

The Board further asked for further clarification of exactly what they being asked to approve by the Applicant. It was determined that the building with the red X with submitted blueprint drawing A-1 and A-2 and the two toned colors Booth Bay Blue and Light Mist are the colors submitted.

Finally, it was noted that corbels should be added under the right and left side fireboxes.

Dirk Schneider moved to approve the application for 23 & 25 Skylight Trail as submitted with the following conditions:

- 1. Corbels or brackets to be added under the right and left side fireboxes.
- 2. The colors of the units are two toned: Booth Bay Blue and Light Mist.

John Mitchell seconded.

Dirk Schneider moved for a roll call vote.

Mitchell voted aye Schneider voted aye Whitbeck voted nay Cristman voted nay Salem voted nay

The motion did not carry.

Jeff Brokaw asked what the problem is with the submission.

Dirk Schneider noted the following concerns:

The Board requires clearer documentation and clarification in the renderings they are asked to approve – the submission is not cohesive. He feels the renderings need to be clearly labeled and a better presentation of what is meaningful needs to be given.

Kathleen Cristman referenced the monotony of the design and the expection that the Design Guidelines would be taken into account into the drawings and plans. This expectation has not been met. She also expressed difficulty understanding the renderings.

Robert Koegel stated that the rendering needs to reflect what the Board is being asked to approve.

Mark Lenzi expressed to Mr. Brokaw that one of the largest concerns of this development was that of excessive similarity of design. He indicated that this was made clear to Jeff Morrell. He indicated to Mr. Brokaw is that the burden of proof of what was going to be built in on the builder and the Board needs to be able to visualize in no uncertain terms what they are being asked to approve.

INFORMAL REVIEW – DEMOLITION OF STORAGE BUILDING

Mark Lenzi shared with the Board a request from Oak Hill Country Club for the demolition of a storage shed building in 1986. The building is not over 50 years old but Oak Hill Country Club clubhouse is an inventoried structure.

Bonnie Salem indicated that it is a dilemma because the materials of the storage shed matches the clubhouse and is one of the outbuildings of a historic building but the age does not justify keeping it.

Kathleen Cristman stated that the shed can be seen from the clubhouse. She felt that Oak Hill is removing trees and sinking down garage cans for a better view of the course and that the removal of this building which is not in use may be part of that.

Dirk Schneider added that this structure was not part of the original design of the Club and the removal of this shed may be part of an effort to return the course back to its original luster.

Mark Lenzi stated that this building was added for storage and bathroom facilities for tennis courts which are no longer in use. In addition, a tree has fallen on the porch of the structure.

Bonnie Salem supported the removal as a way of preserving the original look of the course. Paul Whitbeck indicated that Oak Hill Country Club is an important historic structure and it is important to pay attention to any changes. It was requested that a picture be taken before demolition to document what was there.

OTHER – REVIEW OF 6/25/2020 MINUTES

Bonnie Salem moved to accept the application as submitted.

John Mitchell seconded.

All Ayes.

The meeting adjourned at 7:15 pm.

Respectfully submitted,

Susan Donnelly Secretary to the Board



Town of Pittsford

Department of Public Works 11 South Main Street Pittsford, New York 14534

Permit # B20-000091

Phone: 585-248-6250 FAX: 585-248-6262

DESIGN REVIEW AND HISTORIC PRESERVATION BOARD REFERRAL OF APPLICATION

Property Address: 323 East Street PITTSFORD, NY 14534 Tax ID Number: 178.16-1-12 Zoning District: RN Residential Neighborhood Owner: Hamann, Karl W Applicant: The Unlimited Enterprise

Application Type:

- Residential Design Review §185-205 (B)
- Commercial Design Review §185-205 (B)
- Signage
- §185-205 (C)
- Certificate of Áppropriateness §185-197
- Landmark Designation
- §185-195 (2)
- Informal Review

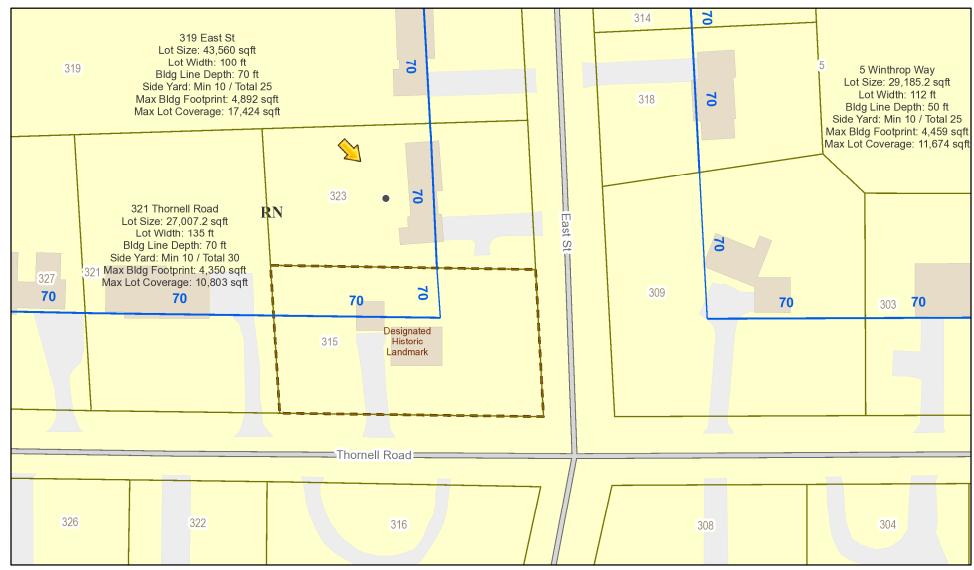
- Build to Line Adjustment §185-17 (B) (2)
- Building Height Above 30 Feet §185-17 (M)
- Corner Lot Orientation
- §185-17 (K) (3)
- Flag Lot Building Line Location §185-17 (L) (1) (c)
- Undeveloped Flag Lot Requirements §185-17 (L) (2)

Project Description: Applicant is requesting design review for a kitchen and bath addition. The addition will be approximately 340 sq. ft. and will be located to the rear of the existing home.


Meeting Date: July 23, 2020



RN Residential Neighborhood Zoning



Printed July 16, 2020

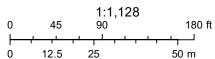

Town of Pittsford GIS

The information depicted on this map is representational and should be used for general reference purposes only. No warranties, expressed or implied, are provided for the data or its use or interpretation.







HAMANN RESIDENCE **JULY 20, 2020**

ARCHITECT:

WOLFE ARCHITECTURE

3 NORTH MAIN ST. SUITE 2 HONEOYE FALLS, NEW YORK 14472 (585)-582-6277

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PERMIT DRAWINGS

SHAWN MCHUGH

CONTRACTOR:

52 NORTH MAIN ST. HONEOYE FALLS, NEW YORK 14472 (585)-905-1819

OWNER:

HAMANN FAMILY

323 EAST ST. PITTSFORD, NY 14534

COVER SHEET

GENERAL

STRUCTURA

CS

S001

S002

S003

S004

D100

D200

A100

A101

A102

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A200

A300

A301

A303

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A401

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ABBREVIATIONS

H.M

HORIZ.

H.W.

HR.

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I.M

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NOTE: ALL ABBREVIATIONS NOT NECESSARILY USED

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HEATING CONTRACTOR HEATING, VENTILATION & AIR CONDITIONING

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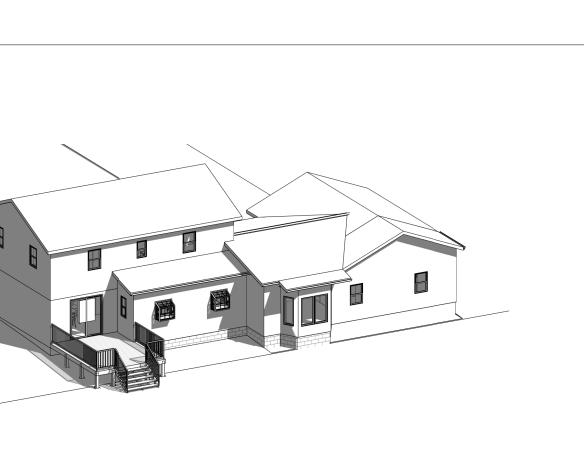
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DRAWING INDEX

STRUCTURAL / ARCHITECTURAL

ENLARGED PLANS AND ELEVATIONS DOOR & WINDOW SCHEDULES

15



GENERAL CONTRACTOR NOTES

GENERAL CONTRACTOR (G.C.) IS RESPONSIBLE FOR ALL REQUIREMENTS FOR LOCAL CODES & ORDINANCES. ALL GENERAL CONSTRUCTION WORK SHALL COMPLY WITH GOVERNING CODES AS ADMINISTERED BY THE LOCAL BUILDING OFFICIALS AND SHALL BE CONSIDERED AS A PART OF THESE CONSTRUCTION DOCUMENTS.

G.C. SHALL INVESTIGATE SITE AND VERIFY ALL DIMENSIONS AND CONDITIONS AND NOTIFY ARCHITECT OF ANY DISCREPANCIES PRIOR TO PROCEEDING WITH WORK.

G.C. SHALL INVESIGATE SITE AND NOTIFY ARCHITECT & OWNER OF ANY FIELD CONDITIONS NOT NOTED ON THE DRAWINGS.

LANDLORD, G.C. AND EACH SUBCONTRACTOR SHALL NOT COMMENCE WORK UNDER THIS CONTRACT UNTIL THEY HAVE PROVIDED PROOF OF INSURANCE IN SUCH AMOUNTS AS WILL PROVIDE ADEQUATE PROTECTION FOR THE OWNER, THE ARCHITECT, THE MEMBERS THEREOF AND THEIR SUCCESSORS, ALL AGENTS, OFFICERS AND SERVANTS OF THE OWNER AND THE G.C. AND SUBCONTRACTOR AGAINST ALL CLAIMS, LIABILITIES, DAMAGES AND ACCIDENTS. SUCH INSURANCE SHALL REMAIN IN FORCE THROUGHOUT THE LIFETIME OF THIS CONTRACT. SEE PROJECT MANUAL FOR MORE INFORMATION.

5. ALL WORK PERFORMED AS A PART OF THIS CONTRACT IS TO BE GUARANTEED BY THE G.C. AND SUBCONTRACTORS TO BE FREE FROM DEFECTS ON MATERIAL AND WORKSMANSHIP FOR A PERIOD OF (1) YEAR FROM THE DATE OF COMPLETION OF THE WORK. THE G.C. AND SUBCONTRACTORS AGREE TO RETURN TO THE JOB AND MAKE REPAIRS AND REPLACEMENTS TO SUCH DEFECTS AT NO COST TO THE OWNER.

ALL SUBCONTRACTORS SHALL BE RESPONSIBLE FOR REVIEWING ALL DRAWINGS AND 6. SPECIFICATIONS FOR THE COORDINATION OF THEIR WORK. ANY DISCREPANCIES SHALL BE REPORTED TO THE OWNER BEFORE FINALIZING BIDS AND COMMENCING ANY WORK.

THE G.C. SHALL ASSUME FULL RESPONSIBILITY FOR THE COORDINATION OF ALL PARTS OF THE WORK AND SHALL CROSS-CHECK ALL SHOP DRAWINGS, SPECIFICATIONS AND INSTALLATIONS. EACH CONTRACTOR SHALL COORDINATE THEIR WORK WITH ALL ADJACENT WORK AND SHALL COORDINATE WITH ALL TRADES. EACH TRADE SHALL AFFORD ALL OTHER TRADES EVERY REASONABLE OPPORTUNITY FOR THE INSTALLATION OF THEIR WORK AND FOR THE STORAGE OF THEIR MATERIAL. EACH TRADE SHALL BE FAMILIAR WITH THE ENTIRE PROJECT AND HAVE THEIR WORK RELATE TO THE JOB IN TOTAL.

8. MAINTAIN ACCESS TO EXITS AND EXIT STAIRS AT ALL TIMES. FIRE ALARM AND SMOKE DETECTOR SYSTEMS SHALL REMAIN OPERATIONAL. PROTECT SMOKE DETECTORS AS REQUIRED.

9. PROVIDE TEMPORARY PARTITIONS/ DUST PROTECTION AT THE DOORS.

10. G.C. SHALL KEEP PROJECT SITE FREE OF DEBRIS AND MAKE FINAL CLEAN UP TO THE SATISFACTION OF THE OWNER. G.C. SHALL BE RESPONSIBLE FOR REMOVAL OF ALL CONSTRUCTION DEBRIS FROM PROJECT SITE AND SHALL PROVIDE DUMPSTERS AS REQUIRED. REMOVE ALL DEBRIS ON A DAILY BASIS.

11. G.C. IS RESPONSIBLE FOR SECURING ALL PERMITS REQUIRED BY THE LOCAL GOVERNING JURISDICTIONS.

^{12.} G.C. TO PROVIDE SUBMITTALS FOR ALL FINISHES, AND SHOP DRAWINGS, FOR REVIEW AND APPROVAL BY OWNER AND ARCHITECT.

COLLECT WASTE DAILY AND DISPOSE OF WASTE OFF-SITE ACCORDING TO LOCAL ORDINANCES, WHEN CONTAINERS ARE FULL. IT IS NOT KNOWN HETHER HAZARDOUS MATERIALS WILL BE ENCOUNTERED IN THE WORK. IF SUCH MATERIALS ARE ENCOUNTERED, DISPOSE OF THE MATERIALS ACCORDINGLY TO APPLICABLE LAWS AND REGULATIONS.

PROVIDE PRODUCTS OF SAME KIND FROM A SINGLE SOURCE. DELIVER, STORE AND HANDLE PRODUCTS ACCORDING TO THE MANUFACTURERS WRITTEN INSTRUCTIONS, USING MEANS AND METHODS THAT WILL PREVENT DAMAGE, DETERIORATION, AND LOSS.

TYPICAL CAULKING - CLEAN & PRIME SUBSTRATE PER MFR'S RECOMMENDATIONS. INSTALL CLOSED CELL BACKER ROD & MASK JOINT. APPLY SILICONE CAULK TO MFR'S INSTRUCTIONS, RECOMMENDED DEPTH TO BONDING RATIO. ALL JOINTS SHALL BE TOOLED CONCAVE, TYPICAL AT ALL CAULK APPLICATIONS.

CONTRACTOR(S) WILL BE RESPONSIBLE TO REPAIR ANY DAMAGE TO THE GROUNDS OR THE BUILDING CAUSED BY THEIR PERSONNEL OR EQUIPMENT.

DRAWING ALTERATION
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DESCRIPTION OF THE ALTERATION".
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PROJECT:
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Residence
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DATE: 7/20/2020 1:53:07 PM ARCHITECT: RHW
DRAWING BY: Author
JOB NUMBER: 19-117
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GENERAL NOTES:

- DESIGN AND CONSTRUCTION SHALL CONFORM TO THE <u>RESIDENTIAL BUILDING CODE OF NEW YORK STATE 2020</u>
 LIVE LOADS: ALL ELEVATED FLOORS = 40PSF
- 3. SNOW LOADS: Pg = 40psf Ce = 1.0 Is = 1.0

 $Psloped = 31psf \qquad Ct = 1.1$

4. WIND LOADS V = 115mph

FOUNDATION AND FLOOR SLAB NOTES:

- 1. FOOTING DESIGN IS BASED ON A PRESUMPTIVE SOIL BEARING CAPACITY OF 1,500psf. VERIFY SOIL CONDITION PRIOR TO CONSTRUCTION.
- 2. CONTRACTOR SHALL VERIFY EXISTING BELOW GRADE UTILITIES.
- EXCAVATION FOR FOUNDATION SHALL BE TAKEN TO FIRM UNDISTURBED SOIL, DRY AND FREE FROM FROST OR LOOSE MATERIAL.
 BACKFILL BELOW GRADE SHALL BE WELL GRADED SAND AND GRAVEL OR CRUSHER RUN STONE HAVING A MAXIMUM
- 4. BACKFILL BELOW GRADE SHALL BE WELL GRADED SAND AND GRAVEL OR CRUSHER RUN STONE HAVING A MAXIMUM SIZE OF 3" AND NO MORE THAN 10% PARTICLES PASSING THE #200 SIVE. BACKFILL SHALL BE PLACED IN 6" TO 8" LIFTS. EACH LIFT SHALL BE COMPACTED TO AT LEASE 95% OF MAXIMUM DENSITY AS DETERMINED BY THE MODIFIED PROCTOR METHOD.
- 5. ALL PIPING SLEEVES THROUGH FOUNDATION WALLS AND FOOTING STEPS TO ACCOMMODATE PIPING SHALL BE COORDINATED WITH THE PLUMBING CONTRACTOR/DRAWINGS.
- 6. CONCRETE COVER FOR REINFORCEMENT:
- BOTTOM OF ALL FOOTINGS SHALL BE A MINIMUM OF 4'-0" BELOW GRADE EXCEPT WHERE FIELD CONDITIONS
- REQUIRE AN ADJUSTMENT.
 8. REFERENCE ARCHITECTURAL AND PLUMBING PLANS FOR SLOPED FLOOR SLABS. ALL SLABS TO MAINTAIN FULL THICKNESS.
- NO BACKFILLING OF FOUNDATION WALLS TO BE DONE UNLESS WALLS ARE ADEQUATELY BRACED OR FILLING IS BALANCED.
- 10. PROVIDE CORNER BARS TO MATCH HORIZONTAL REINFORCING IN ALL WALLS AND FOOTINGS.

MASONRY NOTES:

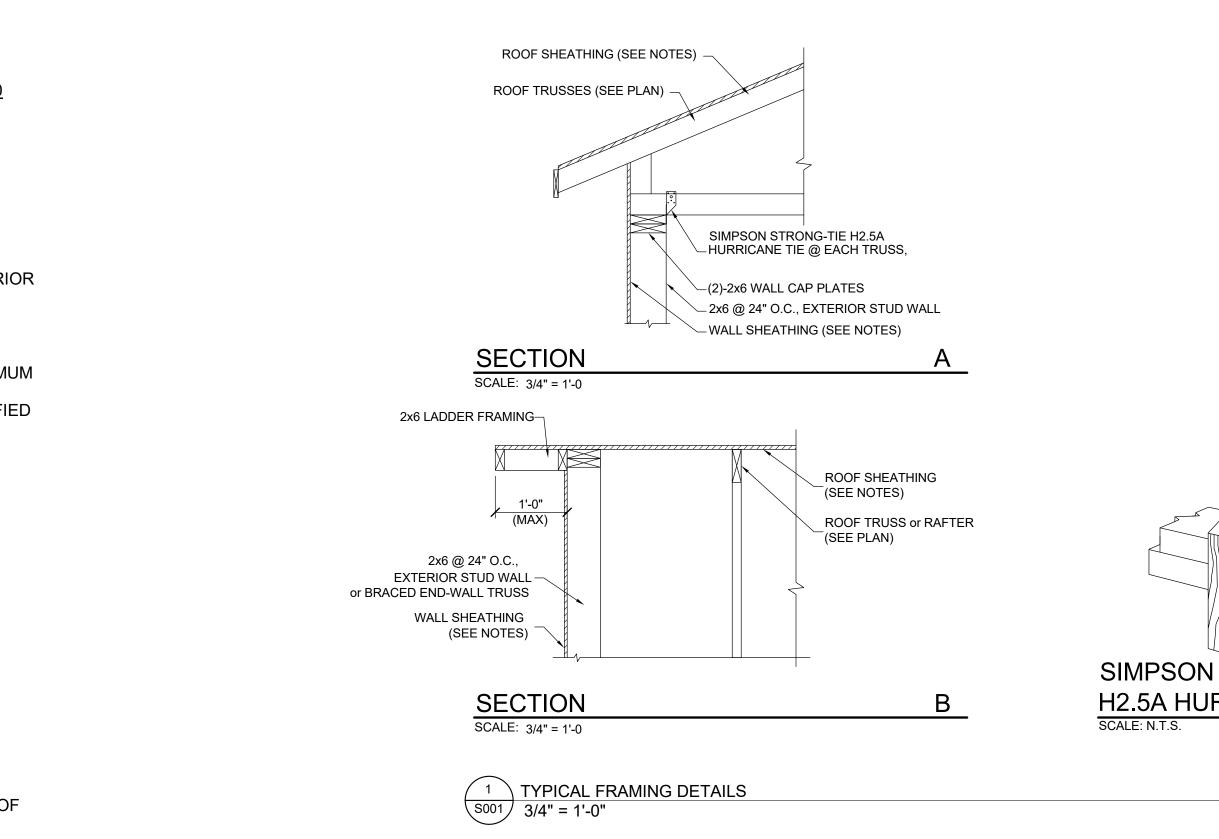
- CONCRETE MASONRY SHALL CONFORM TO THE REQUIREMENTS OF ACI 530-05, AND ACI 350.1-50
 CONCRETE MASONRY UNITS SHALL CONFORM TO ASTM C-90, TYPE 1, GRADE N, MOISTURE CONTROLLED UNITS. MORTAR SHALL BE TYPE M OR S. PROVIDE GALVANIZED HORIZONTAL JOINT REINFORCING AT 16"O.C. UNLESS NOTED OTHERWISE.
- 3. GROUT FOR FILLING BLOCK CORES SHALL CONFORM TO ASTM C476 WITH A MINIMUM COMPRESSIVE STRENGTH OF 3,000psi AT 28 DAYS. GROUT SHALL BE PLACED IN LIFTS NOT EXCEEDING 7 COURSES IN HEIGHT UNLESS OTHERWISE APPROVED BY THE ENGINEER.
- 4. LAP SPLICES IN VERTICAL REINFORCING FOR CONCRETE BLOCK MASONRY WALLS AND PILASTERS SHALL BE A MINIMUM OF 48 BAR DIAMETERS UNLESS DETAILED OTHERWISE ON THE DRAWINGS.

CONCRETE NOTES:

- 1. CONCRETE DESIGN AND CONSTRUCTION SHALL CONFORM TO ACI 318-05 AND ACI 301-05.
- 2. MINIMUM COMPRESSIVE STRENGTH AT 28 DAYS SHALL BE: 4000PSI
- 3. REINFORCING STEEL SHALL CONFORM TO ASTM A615, GRADE 60. WELDED WIRE FABRIC SHALL CONFORM TO ASTM A185, AND SHALL BE SUPPLIED IN SHEETS ONLY.
- 4. THE REINFORCING STEEL CONTRACTOR SHALL FABRICATE ALL REINFORCEMENT AND FURNISH ALL ACCESSORIES, CHAIRS, SPACER BARS AND SUPPORTS NECESSARY TO SECURE THE REINFORCEMENT UNLESS SHOWN OTHERWISE ON THE DRAWINGS.

WOOD NOTES:

- 1. WOOD CONSTRUCTION SHALL CONFORM TO THE AMERICAN FOREST and PAPER ASSOCIATION'S (AF&PA) NATIONAL DESIGN SPECIFICATIONS. LUMBER SHALL BE #2 HEM-FIR OR BETTER WITH Fb=850 psi, Fv=150 psi AND E=1,300,000 psi
- 2. WOOD IN CONTACT WITH MASONRY, CONCRETE OR EARTH, OR WITHIN 1'-0" OF GRADE OR EXPOSED TO THE EXTERIOR SHALL BE PRESSURE PRESERVATIVE TREATED.
- 3. MICRO-LAM LUMBER AND TRUSS-JOISTS SHALL BE AS MANUFACTURED BY "TRUSS-JOIST, iLEVEL by Weyerhaeuser". BEAMS SHALL BE PROPERLY FASTENED TOGETHER WITH A MINIMUM OF (2)-ROWS OF 16d NAILS PER FOOT. INSTALL PER MANUFACTURERS RECOMMENDATIONS.
- 4. FRAMING ANCHORS AND MISCELLANEOUS METAL DEVICES FOR WOOD FRAMING SHALL BE GALVANIZED STEEL OF AT LEAST 16 GAGE THICKNESS INSTALL IN STRICT ACCORDANCE WITH MANUFACTURER'S RECOMMENDATIONS. USE NAILS SUPPLIED BY OR RECOMMENDED BY THE MANUFACTURER.
- 5. ROOF TRUSSES, INCLUDING DESIGN, CONNECTIONS, BRACING ERECTION AND QUALITY SHALL CONFORM TO THE SPECIFICATIONS AND RECOMMENDATIONS OF NFPA AND THE TRUSS PLATE INSTITUTE (TPI). TEMPORARY AND PERMANENT BRACING SHALL BE IN STRICT ACCORDANCE WITH TPI BWT-76, BRACING WOOD TRUSSES. TRUSS MANUFACTURER'S REPRESENTATIVE SHALL BE ON SITE AS NECESSARY TO INSURE THAT TRUSSES AND BRACING IS INSTALLED PER MANUFACTURER'S SHOP DRAWINGS.
- 6. SUBMIT DESIGN CALCULATIONS AND SHOP DRAWINGS FOR ROOF TRUSSES, PREPARED AND SEALED BY A PROFESSIONAL ENGINEER LICENSED IN THE STATE OF NEW YORK, TO THE ARCHITECT FOR REVIEW BEFORE BEGINNING FABRICATION.
- 7. <u>SHEATHING NOTES:</u>
 - A. ROOF SHEATHING: 1/2" ADVANTECH SHEATHING FASTEN w/ 10dx214"Lg. NAILS, SPACED @6" O.C. ALONG PANEL EDGES AND 12" O.C. IN PANEL FIELDS.
 - B. FLOOR SHEATHING: 3/4" TONGUE & GROOVE PLYWOOD FASTEN w/ 8dx212"Lg. NAILS, SPACED @6" O.C. ALONG PANEL EDGES AND 12" O.C. IN PANEL FIELDS.
 C. EXTERIOR WALL SHEATHING: 1/2" PLYWOOD, FASTEN w/ 16ga x 3" STAPLES (716" CROWN), SPACED @ 3" O.C.
 - ALONG PANEL EDGES AND 6" O.C. IN PANEL FIELDS. PROVIDE SOLID 2x WOOD BLOCKING AT ALL HORIZONTAL PANEL JOINTS.



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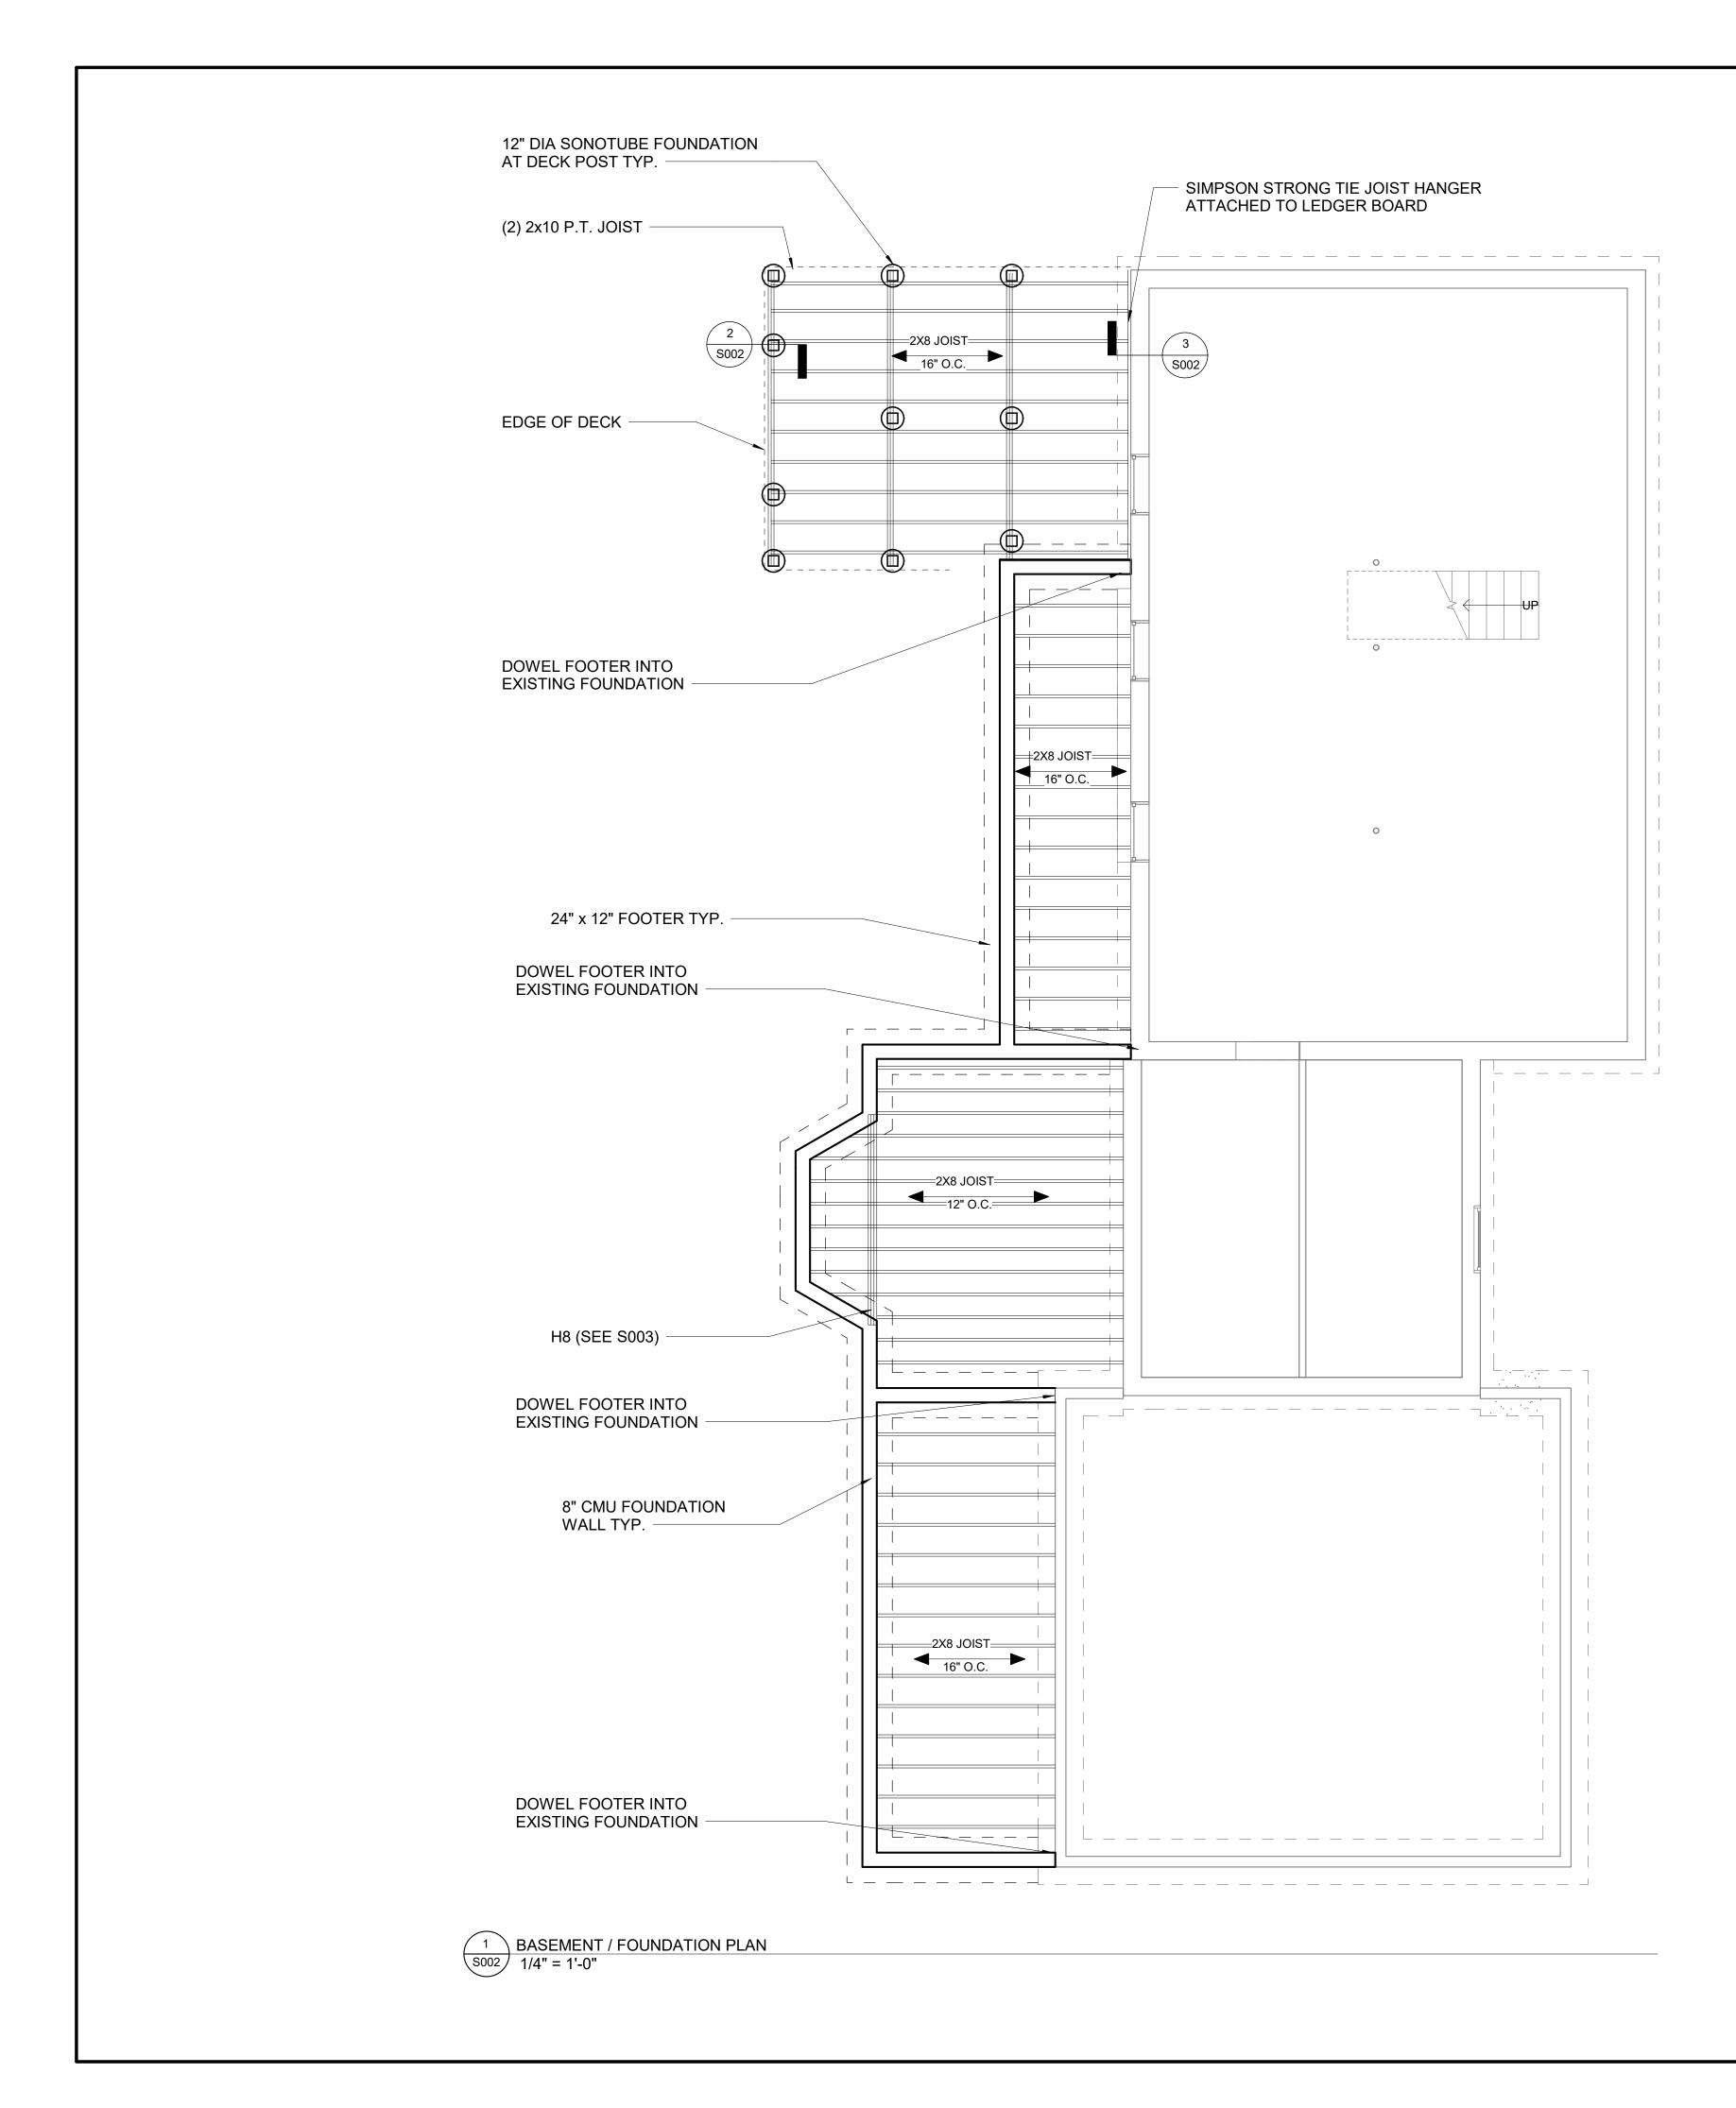
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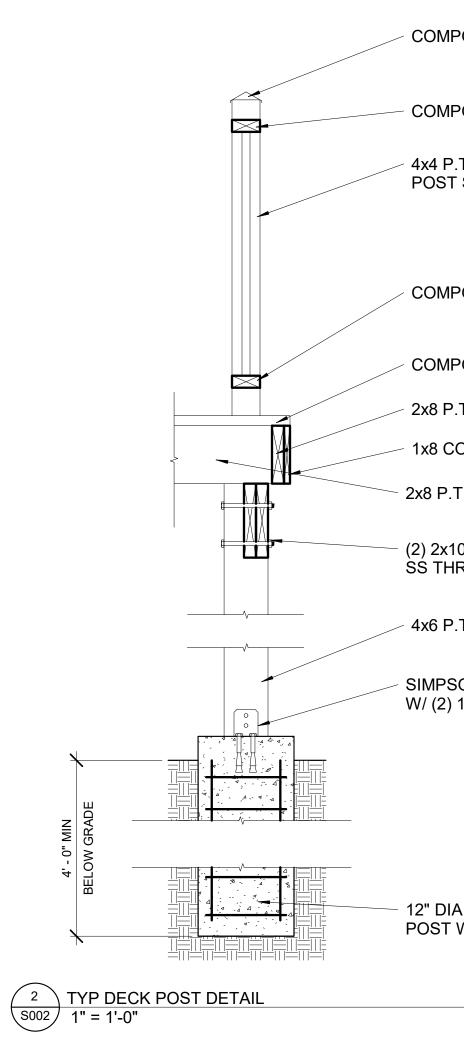
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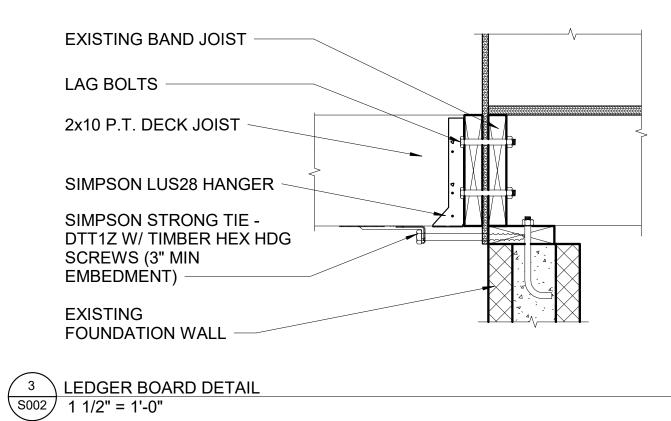
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2 TYP. EXTERIOR WALL DETAIL \$001 1 1/2" = 1'-0"

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	SEAL
	OWNER: MR & MRS HAMANN
	PROJECT:
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	LOCATION:
	323 EAST ST. PITTSFORD, NY 14534
	DATE: 7/20/2020 1:53:10 PM ARCHITECT: RHW
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POSITE	POST	CAP

- COMPOSITE RAILING

4x4 P.T. POST WITH COMPOSITE POST SLEEVE

COMPOSITE BOTTOM PLATE

COMPOSITE DECK BOARDS

2x8 P.T. RIDGE BEAM

1x8 COMPOSITE TRIM BOARD

2x8 P.T. DECK JOIST

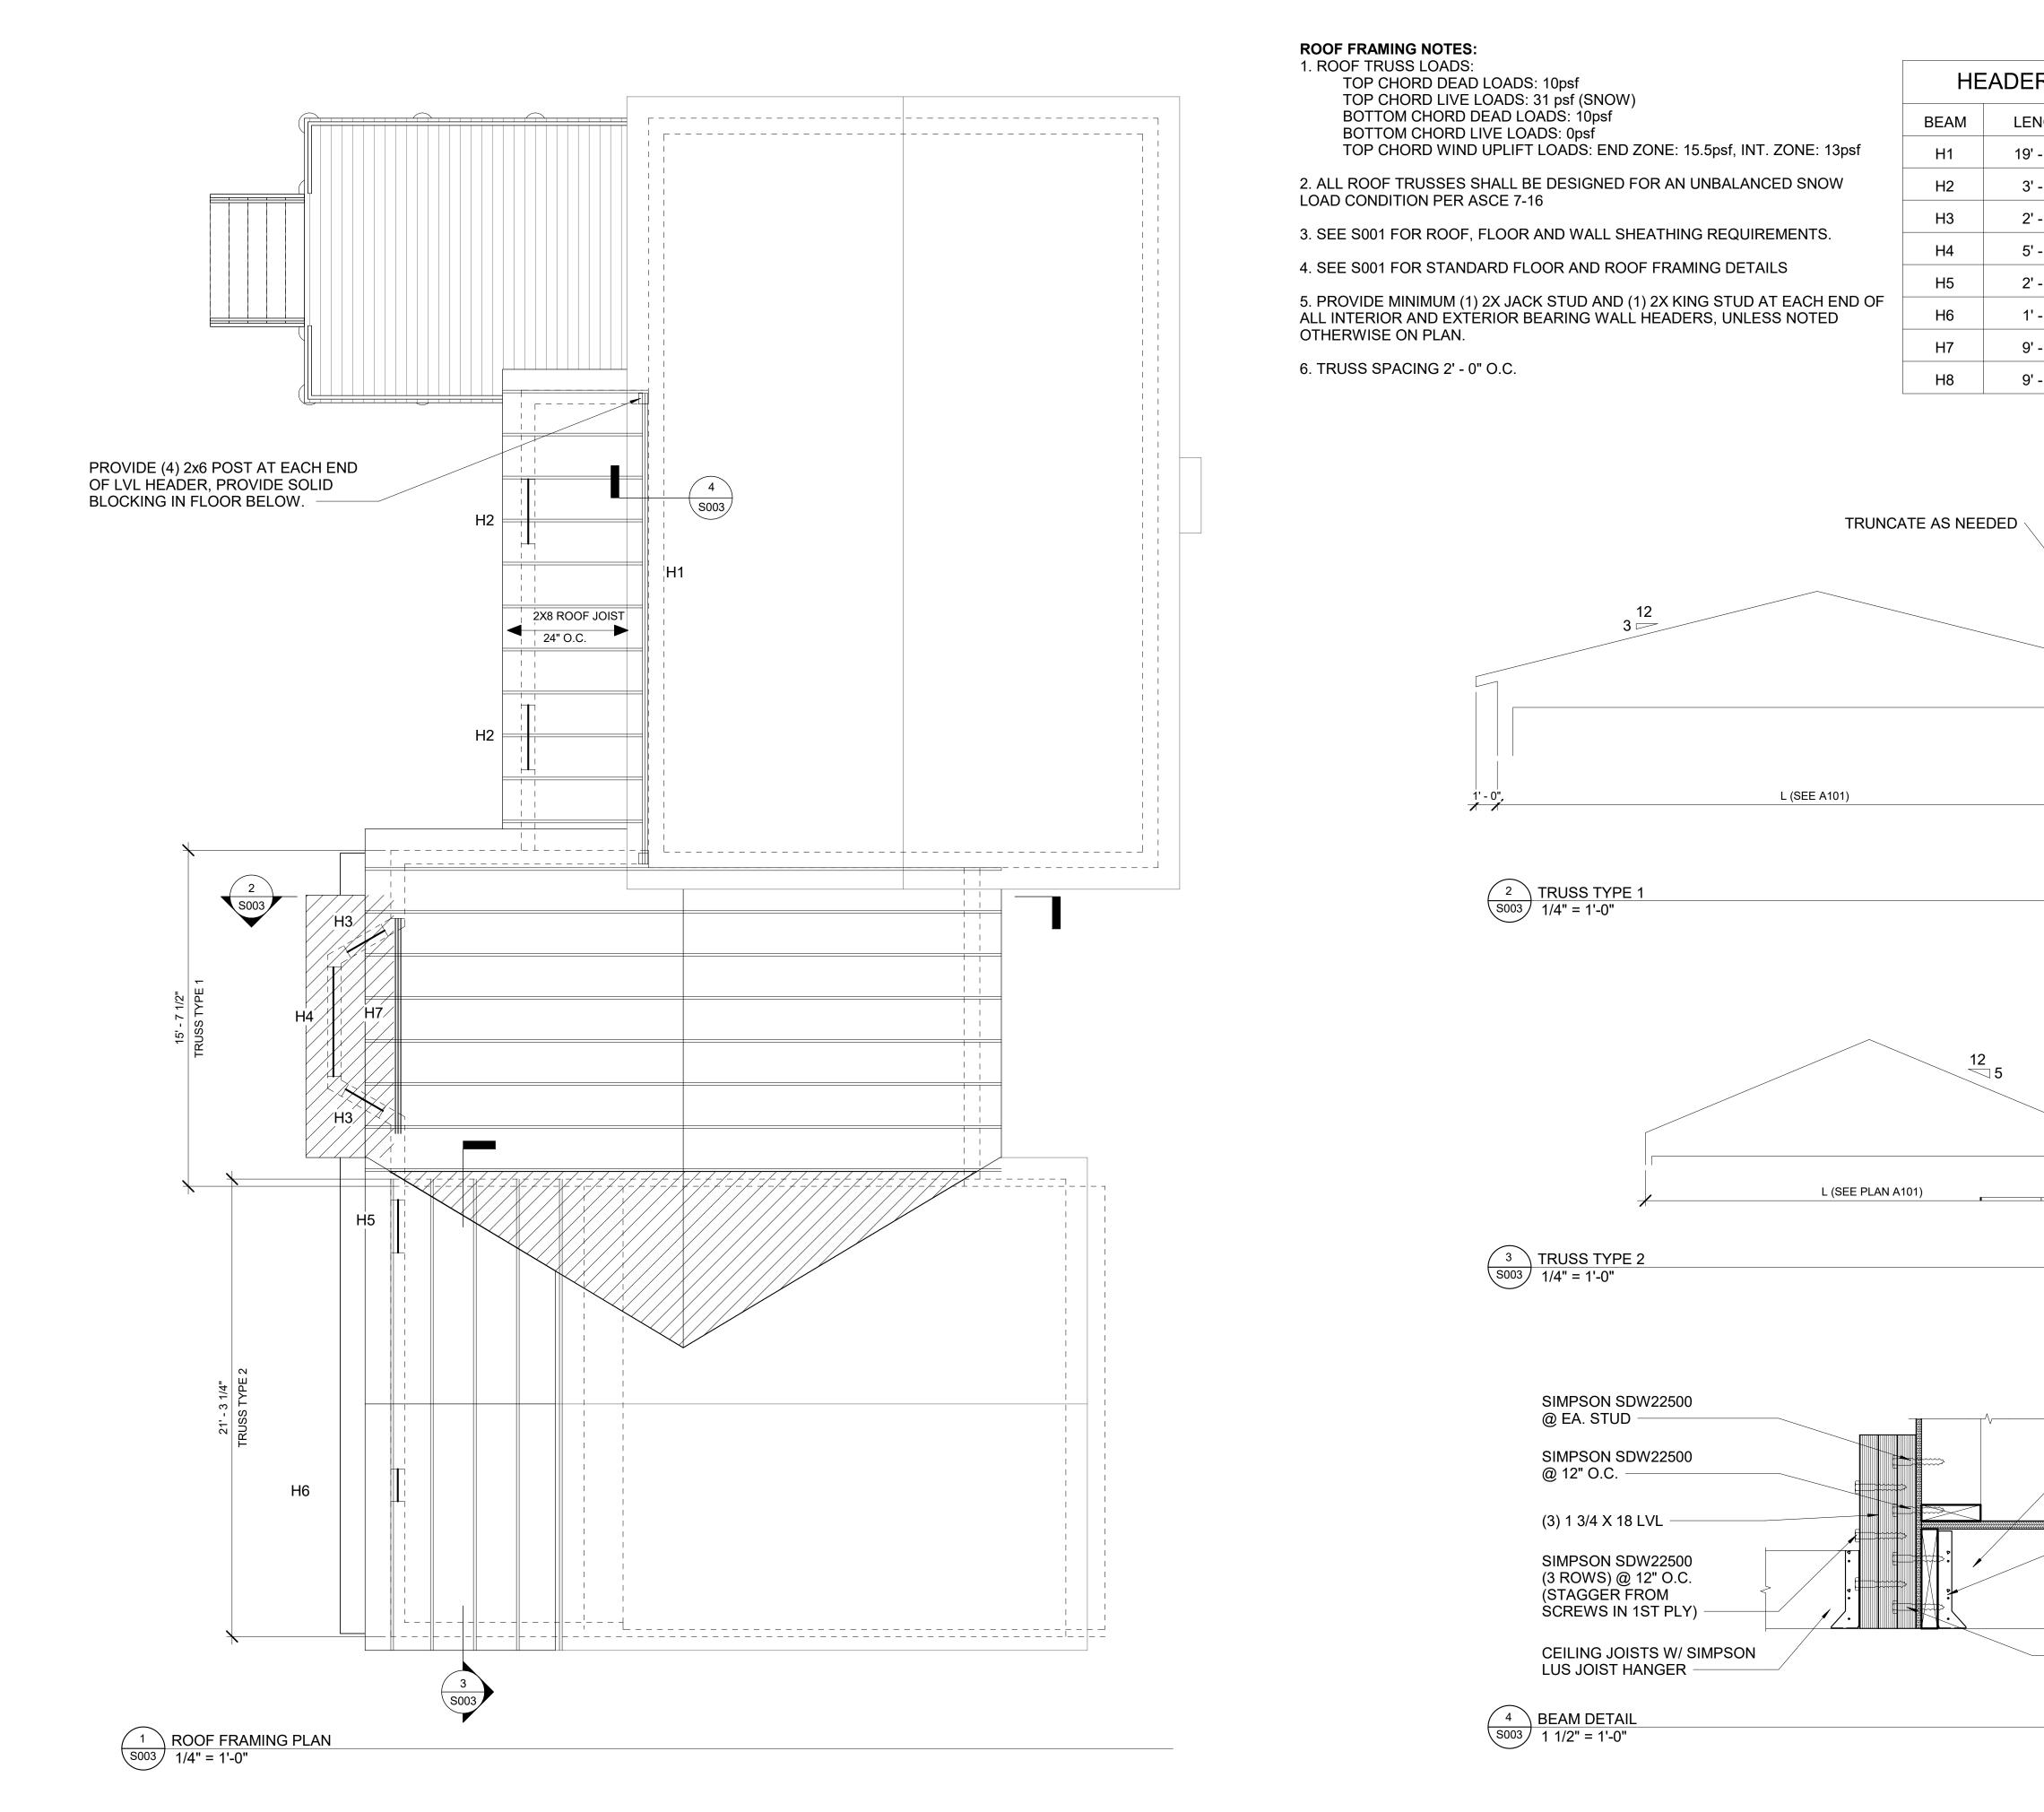
(2) 2x10 P.T. HEADER W/ (2) 1/2" DIA.
 SS THRU BOLT @ EACH POST

- 4x6 P.T. POST

SIMPSON STRONG TIE - ABU46SS (STAINLESS STEEL) W/ (2) 1/2" DIA. S.S. EXP. ANCHORS (3 1/2" EMBED)

12" DIA. SONOTUBE FOUNDATION @ EACH POST W/ (4) #5 VERTS & #3 TIES @ 10" O.C.

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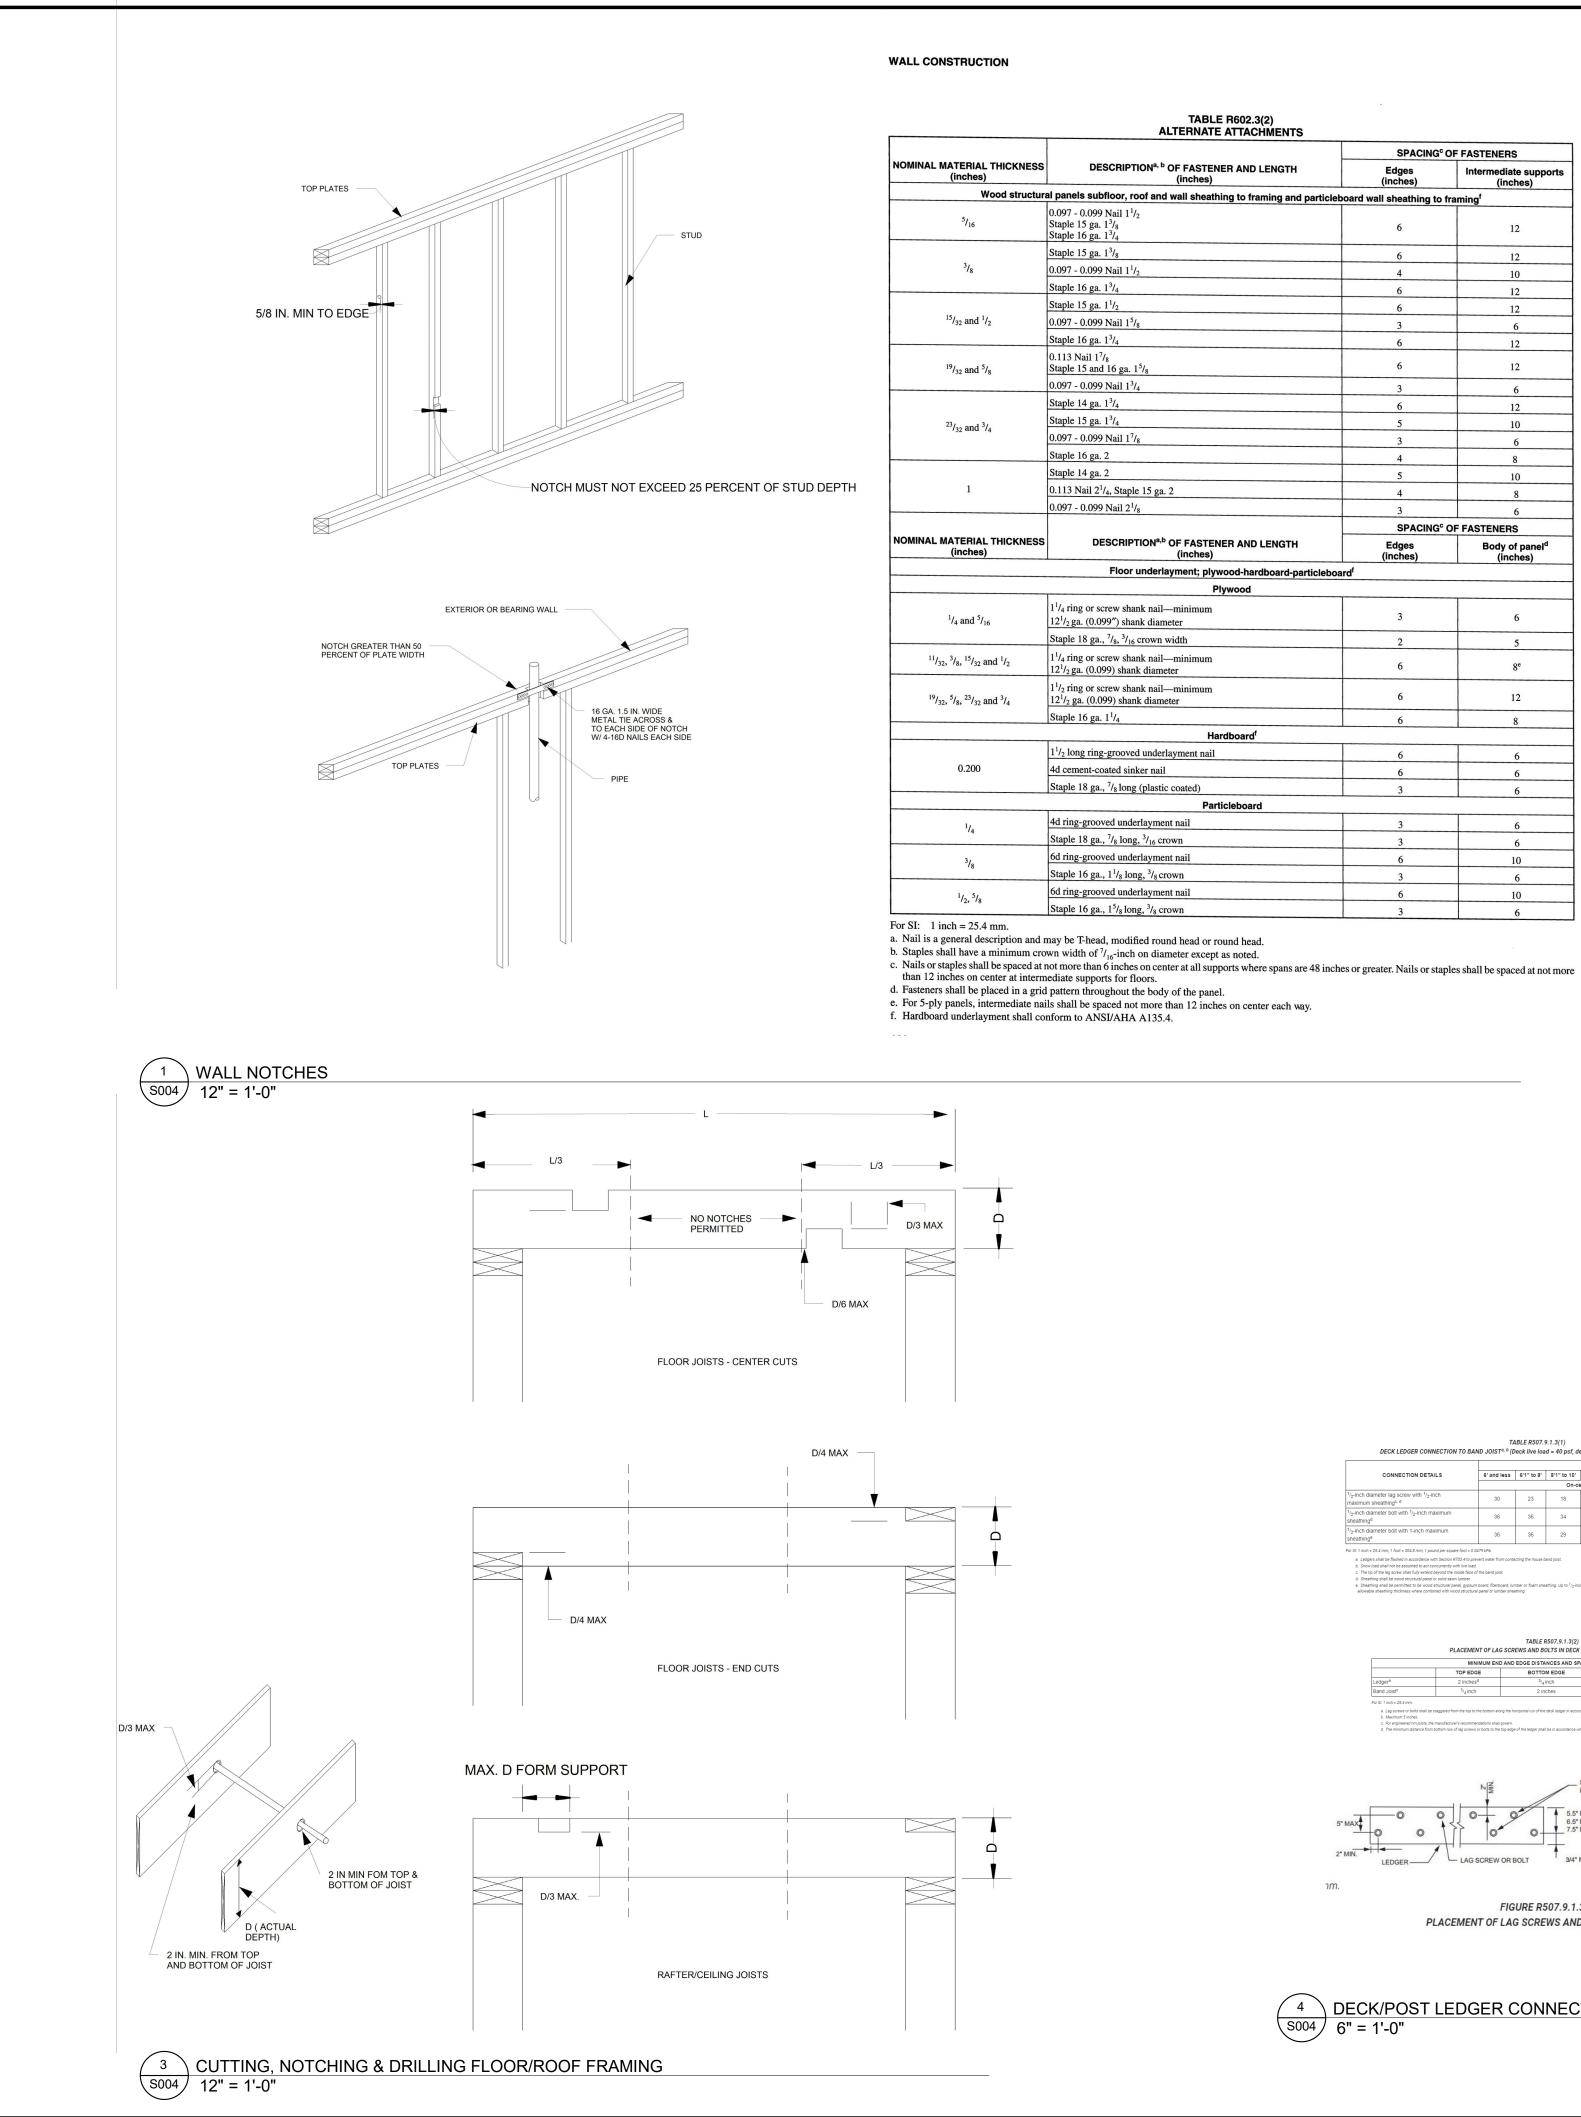




TABLE R507.9.1.3(1) DECK LEDGER CONNECTION TO BAND JOIST^{a, b} (Deck live load = 40 psf, deck dead load = 10 psf, snow load ≤ 40 psf)

CONNECTION DETAILS

h diameter lag screw with 1/2-inch aximum sheathing^{c, d} /₂-Inch diameter bolt with ¹/₂-Inch maximum

sheatning⁴ ¹/₂-inch diameter bolt with 1-inch maximum

Sheathing^e For St: 1 inch = 25.4 mm, 1 foot = 304.8 mm, 1 pound per square foot = 0.0479 kPa.

Ledgers shall be flashed in accordance with Section R703.4 to prevent water from contacting the house band joist.
 Sow was do that not be assumed for act concurrently with live load.
 The tip of the lipser with filly areas they boynd the inside free of the band joist.
 Sharing that be anod structural parent corsolid sawn lumber.
 Sharing hash be permitted to be works unclusted in the load.

ructural panel, gypsum board, fiberboard, lumber or foam sheathing ed with wood structural panel or lumber sheathing.

 JOIST SPAN

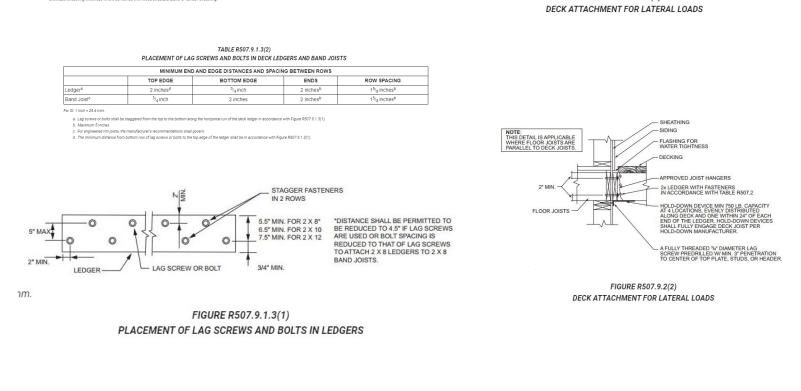
 6' and less
 6'1" to 8'
 8'1" to 10'
 10'1" to 12'
 12'1" to 14'
 14'1" to 16'
 16'1" to 18'

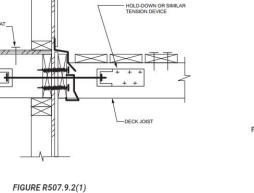
 On-center spacing of fasteners

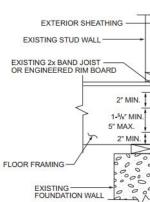
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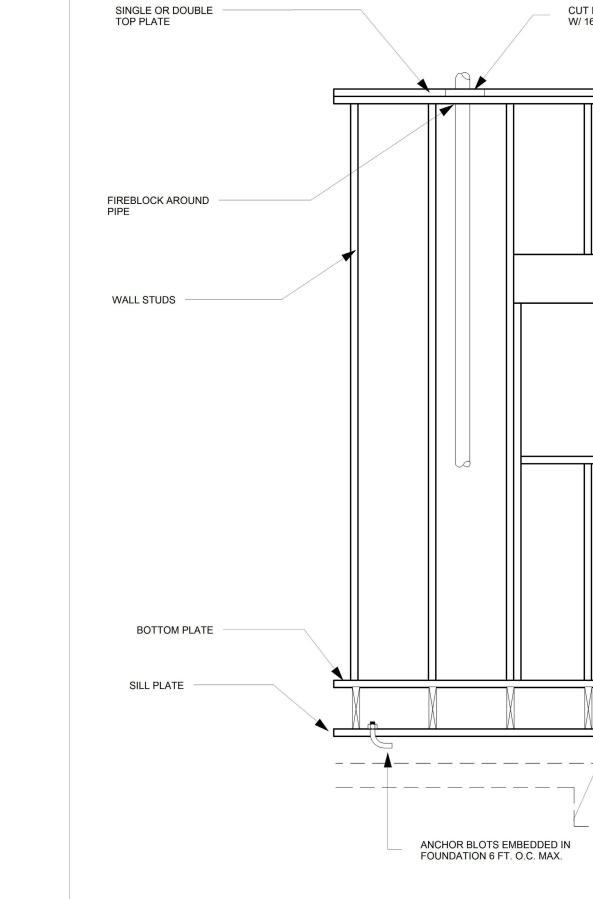







SINGLE PLY BEAM


113 Nail 1 ⁷ / ₈ aple 15 and 16 ga. 1 ⁵ / ₈	6	12		
097 - 0.099 Nail 1 ³ / ₄	3	6		
aple 14 ga. 1 ³ / ₄	6	12		
aple 15 ga. 1 ³ / ₄	5	10		
097 - 0.099 Nail 1 ⁷ / ₈	3	6		
aple 16 ga. 2	4	8		
aple 14 ga. 2	5	10		
113 Nail 2 ¹ /4, Staple 15 ga. 2	4	8		
097 - 0.099 Nail 2 ¹ / ₈	3	6		
SPACING® OF FASTENERS				
DESCRIPTION ^{a,b} OF FASTENER AND LENGTH (inches)	Edges (inches)	Body of panel ^d (inches)		
Floor underlayment; plywood-hardboard-particleboa	Ird ^f			
Plywood				
l_4 ring or screw shank nail—minimum $l_2 ga. (0.099'')$ shank diameter	3	6		
aple 18 ga., ⁷ / ₈ , ³ / ₁₆ crown width	2	5		
/4 ring or screw shank nail—minimum ¹ / ₂ ga. (0.099) shank diameter	6	8°		
/2 ring or screw shank nail—minimum 2 ¹ /2 ga. (0.099) shank diameter	6	12		
aple 16 ga. $1^{1}/_{4}$	6	8		
Hardboard ^f				
/2 long ring-grooved underlayment nail	6	6		
cement-coated sinker nail	6	6		
aple 18 ga., ⁷ / ₈ long (plastic coated)	3	6		
Particleboard				
l ring-grooved underlayment nail	3	6		
aple 18 ga., ⁷ / ₈ long, ³ / ₁₆ crown	3	6		
l ring-grooved underlayment nail	6	10		
aple 16 ga., 1 ¹ / ₈ long, ³ / ₈ crown	3	6		
l ring-grooved underlayment nail	6	10		
aple 16 ga., 1 ⁵ / ₈ long, ³ / ₈ crown	3	6		
y be T-head, modified round head or round head. width of $\frac{7}{1_6}$ -inch on diameter except as noted. more than 6 inches on center at all supports where spans are 48 inch	es or greater Nails or stopla	shall be appead at not more		



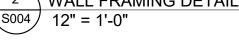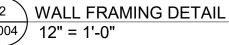2 WALL FRAMING DETAIL S004 12" = 1'-0"











6" MAXIMUM ON CENTER

+ +


111 111

FLOOR JOIST -

	SPACING" OF FASTENERS		
DESCRIPTION ^{a, b} OF FASTENER AND LENGTH (inches)	Edges (inches)	Intermediate supports (inches)	
nels subfloor, roof and wall sheathing to framing and particle	board wall sheathing to fra	ming ^f	
7 - 0.099 Nail 1 ¹ / ₂ e 15 ga. 1 ³ / ₈ e 16 ga. 1 ³ / ₄	6	12	
$e 15 \text{ ga. } 1^{3}/_{8}$			
$7 - 0.099$ Nail $1^{1}/_{2}$	6	12	
$e 16 ga. 1^{3}/_{4}$	4	10	
$e 15 ga. 1^{1}/_{2}$	6	12	
$7 - 0.099$ Nail $1^{5}/_{8}$	6	12	
$e 16 \text{ ga. } 1^{3}/_{4}$	3	6	
10 B Nail $1^{7}/_{8}$ e 15 and 16 ga. $1^{5}/_{8}$	6	12	
7 - 0.099 Nail 1 ³ / ₄	3		
$e 14 \text{ ga. } 1^{3}/_{4}$	6	6	
$e 15 ga. 1^{3}/_{4}$	5	12	
7 - 0.099 Nail 1 ⁷ / ₈	3	10	
e 16 ga. 2	4	6	
le 14 ga. 2	5	8	
$3 \text{ Nail } 2^{1}/_{4}$, Staple 15 ga. 2	4	10	
7 - 0.099 Nail 2 ¹ / ₈	3	8	
		6	
DESCRIPTION ^{a,b} OF FASTENER AND LENGTH (inches)	Edges (inches)	FFASTENERS Body of panel ^d	
Floor underlayment; plywood-hardboard-particleboard		(inches)	
Plywood			
ing or screw shank nail—minimum ga. (0.099") shank diameter	3	6	
le 18 ga., $7/_8$, $3/_{16}$ crown width			
ring or screw shank nail—minimum ga. (0.099) shank diameter	6	5 8°	
ing or screw shank nail—minimum ga. (0.099) shank diameter	6	12	
le 16 ga. $1^{1}/_{4}$	6	8	
Hardboard ^f		0	
ong ring-grooved underlayment nail	6	6	
ement-coated sinker nail	6	6	
le 18 ga., ⁷ / ₈ long (plastic coated)	3	6	
Particleboard	<u>J</u>	0	
ng-grooved underlayment nail	3	6	
le 18 ga., $\frac{7}{8} \log_3 \frac{3}{16}$ crown	3	6	
		0	


SPACING^c OF FASTENERS

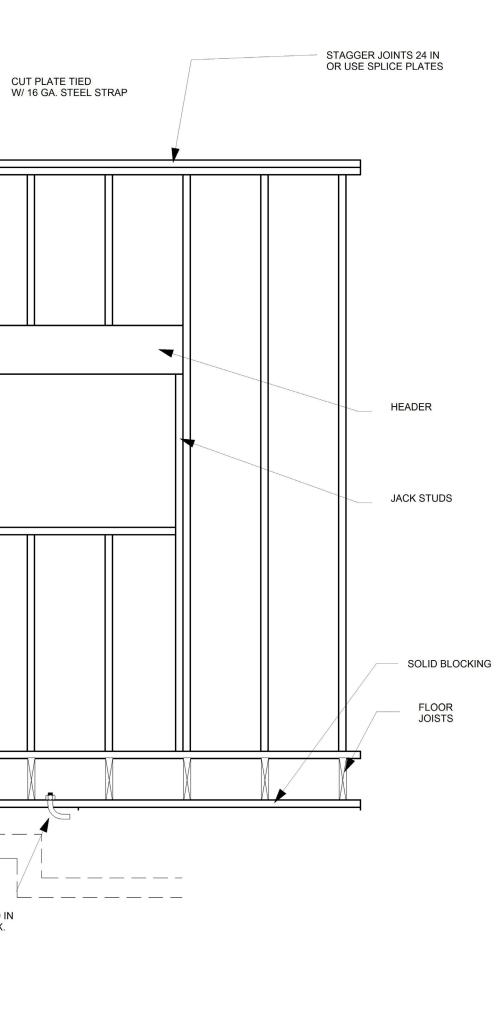
TABLE R602.3(2) ALTERNATE ATTACHMENTS




EXTERIOR SHEATHING EXISTING STUD WALL STING 2x BAND JOIST ENGINEERED RIM BOARD 2" MIN. 5" MAX. 2" MIN. 5" MAX. 5" MAX. 5" O O O O O O O O O O O O O O O O O O O	BEAM SPLICE (F REQUIRED)
FIGURE R507.9.1.3(2) PLACEMENT OF LAG SCREWS AND BOLTS IN BAND JOISTS	FIGURE R507.5.1(1) DECK BEAM TO DECK POST
MINIMUM 2' LE PLY BEAM (2) 1/2' DIAMETER THROUGH-BOLTS OR APPROVED E QUIVALENT CONNECTOR POST NOTCH FOR FULL-BEAM BEARING 2 2%' MIN. BEAM SPLICE 2 2' (5' (5') (5') 12' MN IN ALLOWABLE SOLS GRADE BEPTH PER TABLE DEPTH PER TABLE CF ENGLASSING CF EMBEDMENT CF EMBEDMENT CF EMBEDMENT CF EMBEDMENT
≥ 21/4" ≥ 2 ^{1/4}	NOTE: POSTS MUST BE CENTERED ON OR IN FOOTING
FIGURE R507.5.1(2) NOTCHED POST-TO-BEAM CONNECTION	FIGURE R507.3 DECK POSTS TO DECK FOOTING CONNECTION

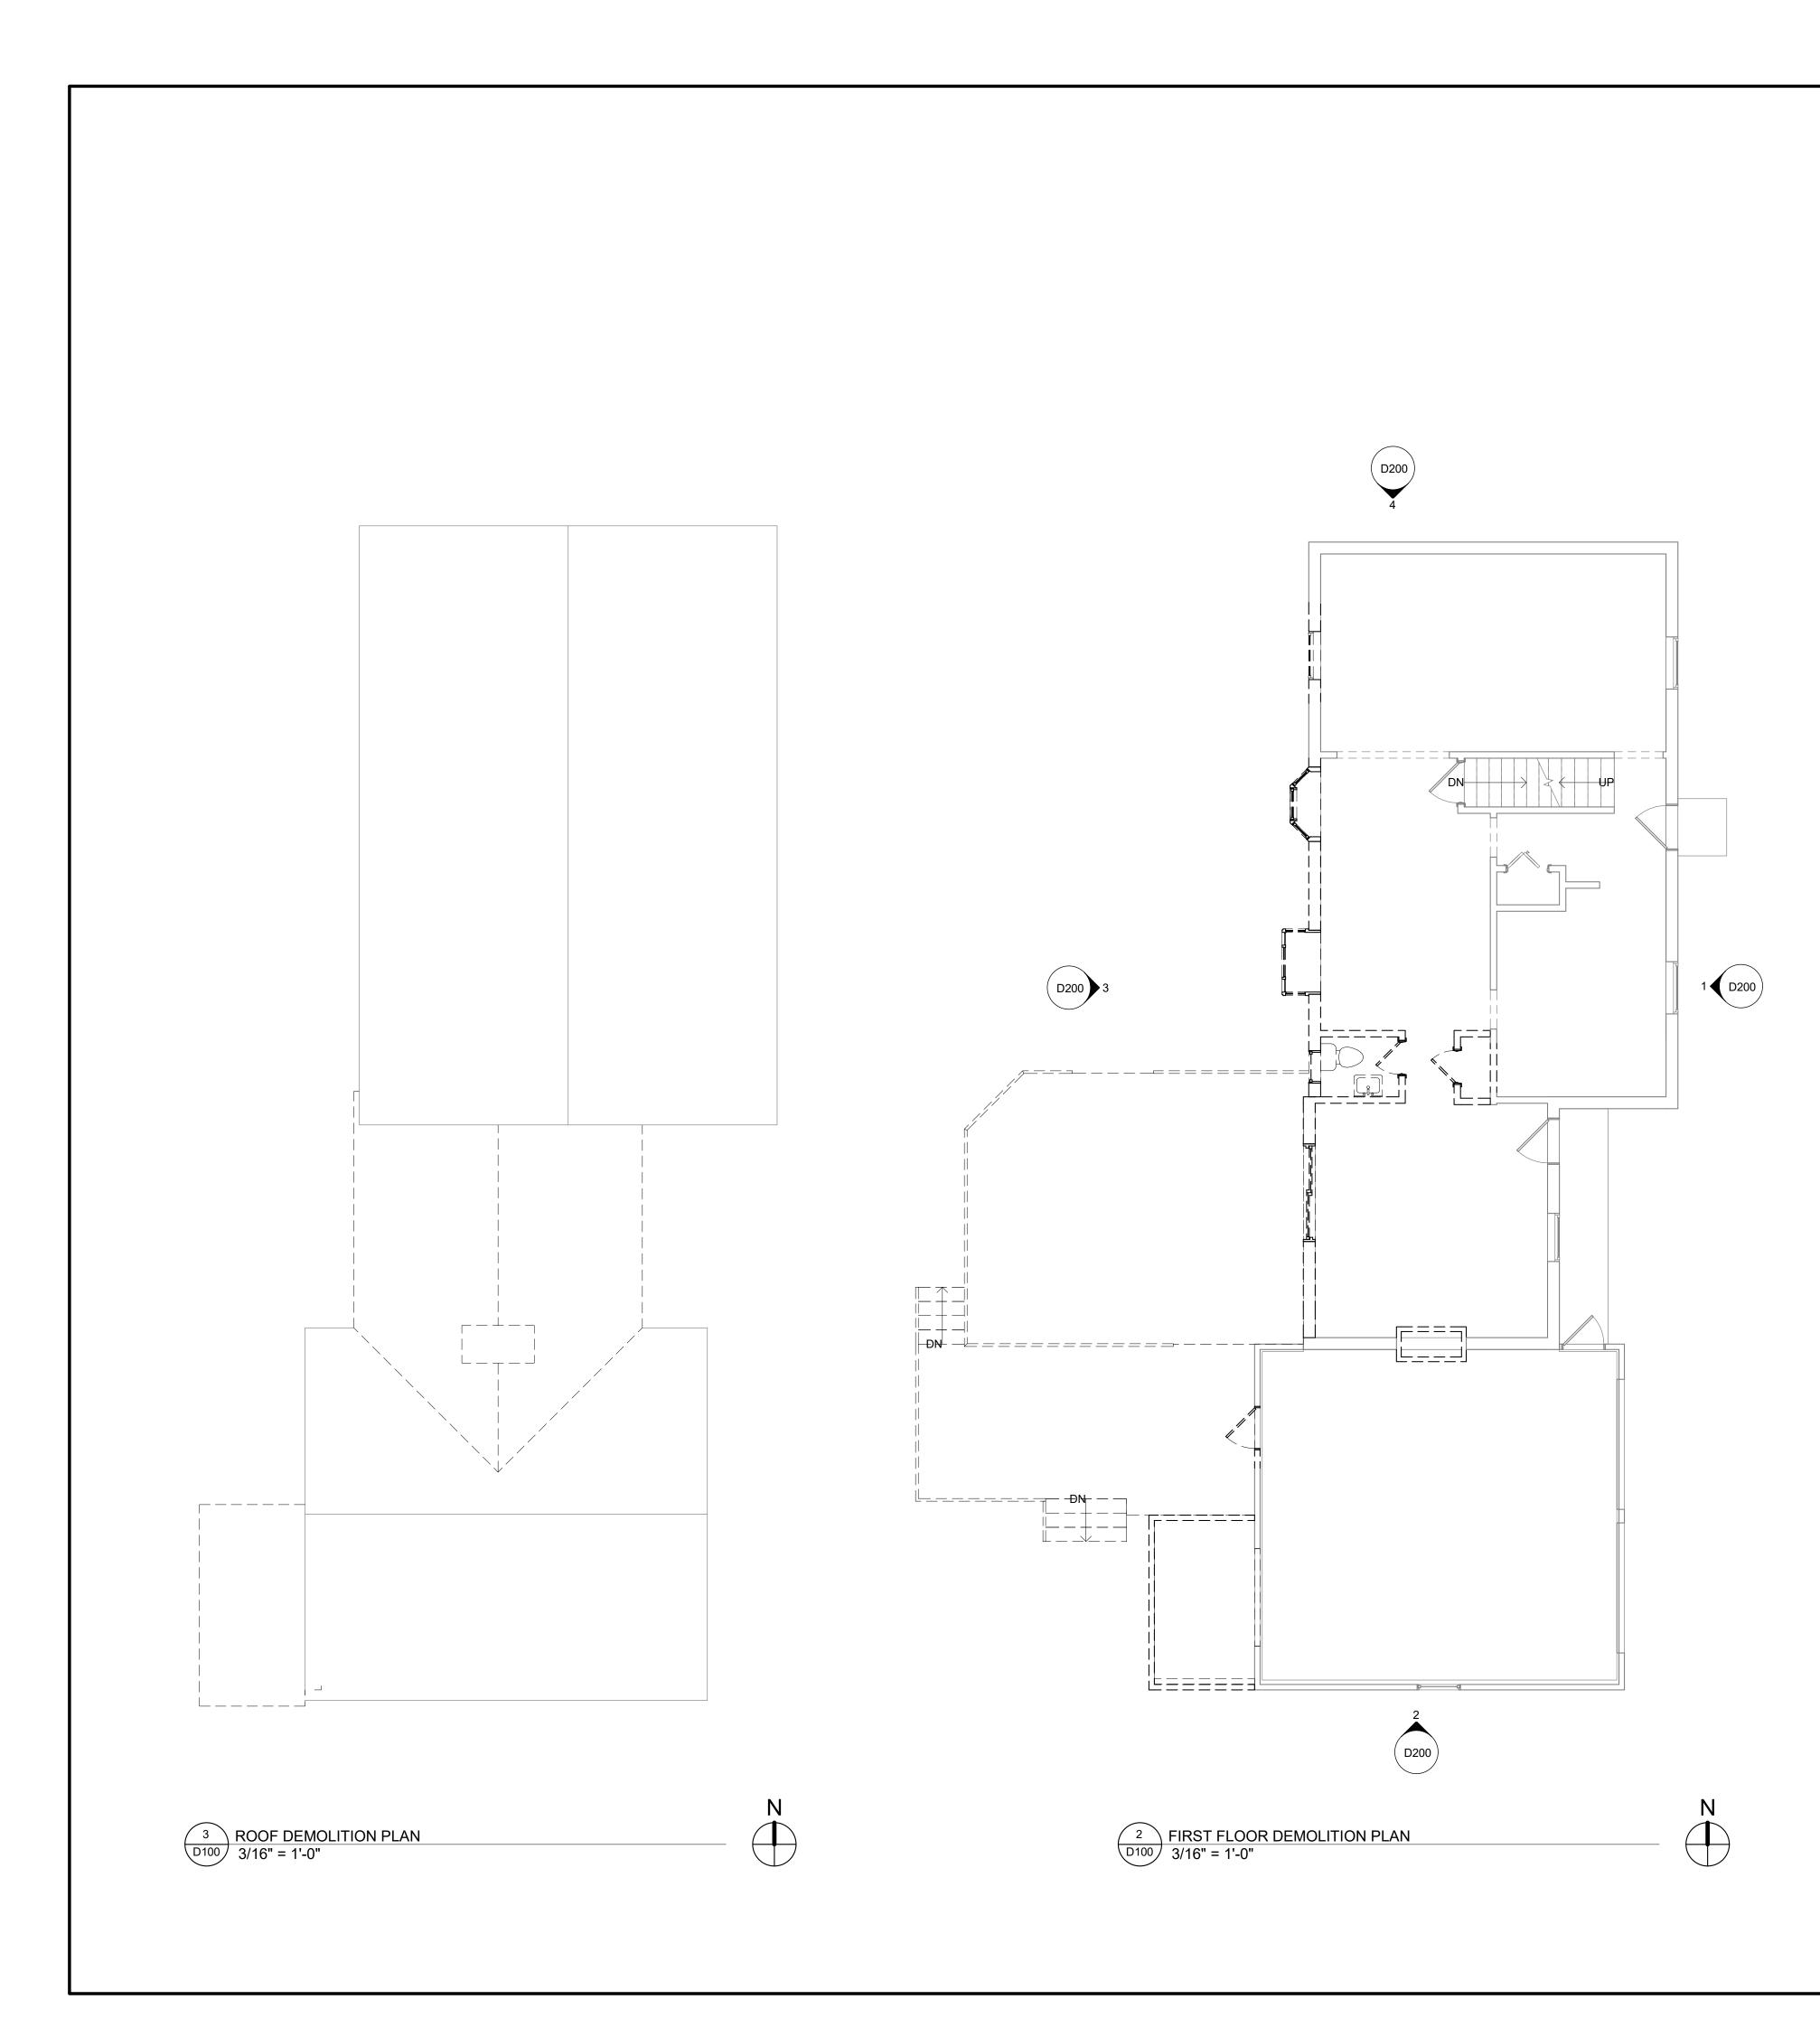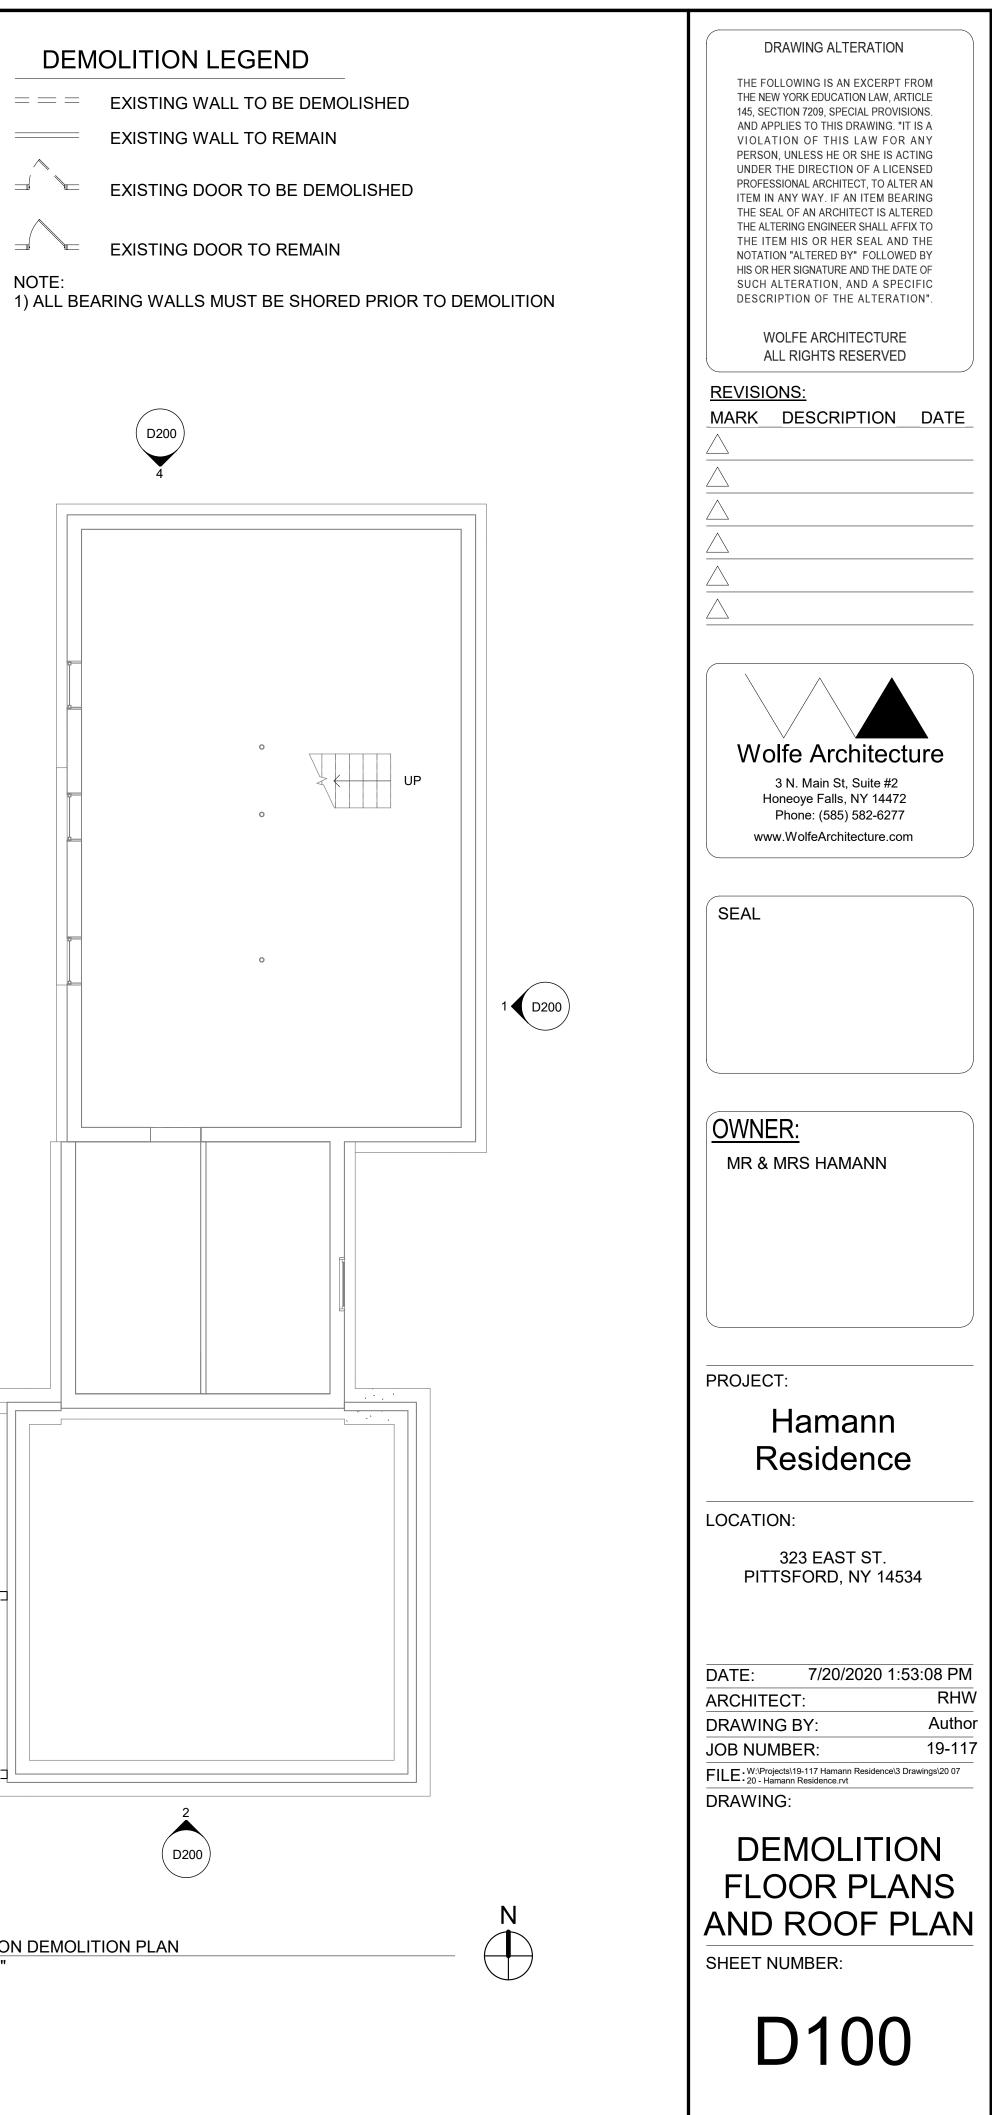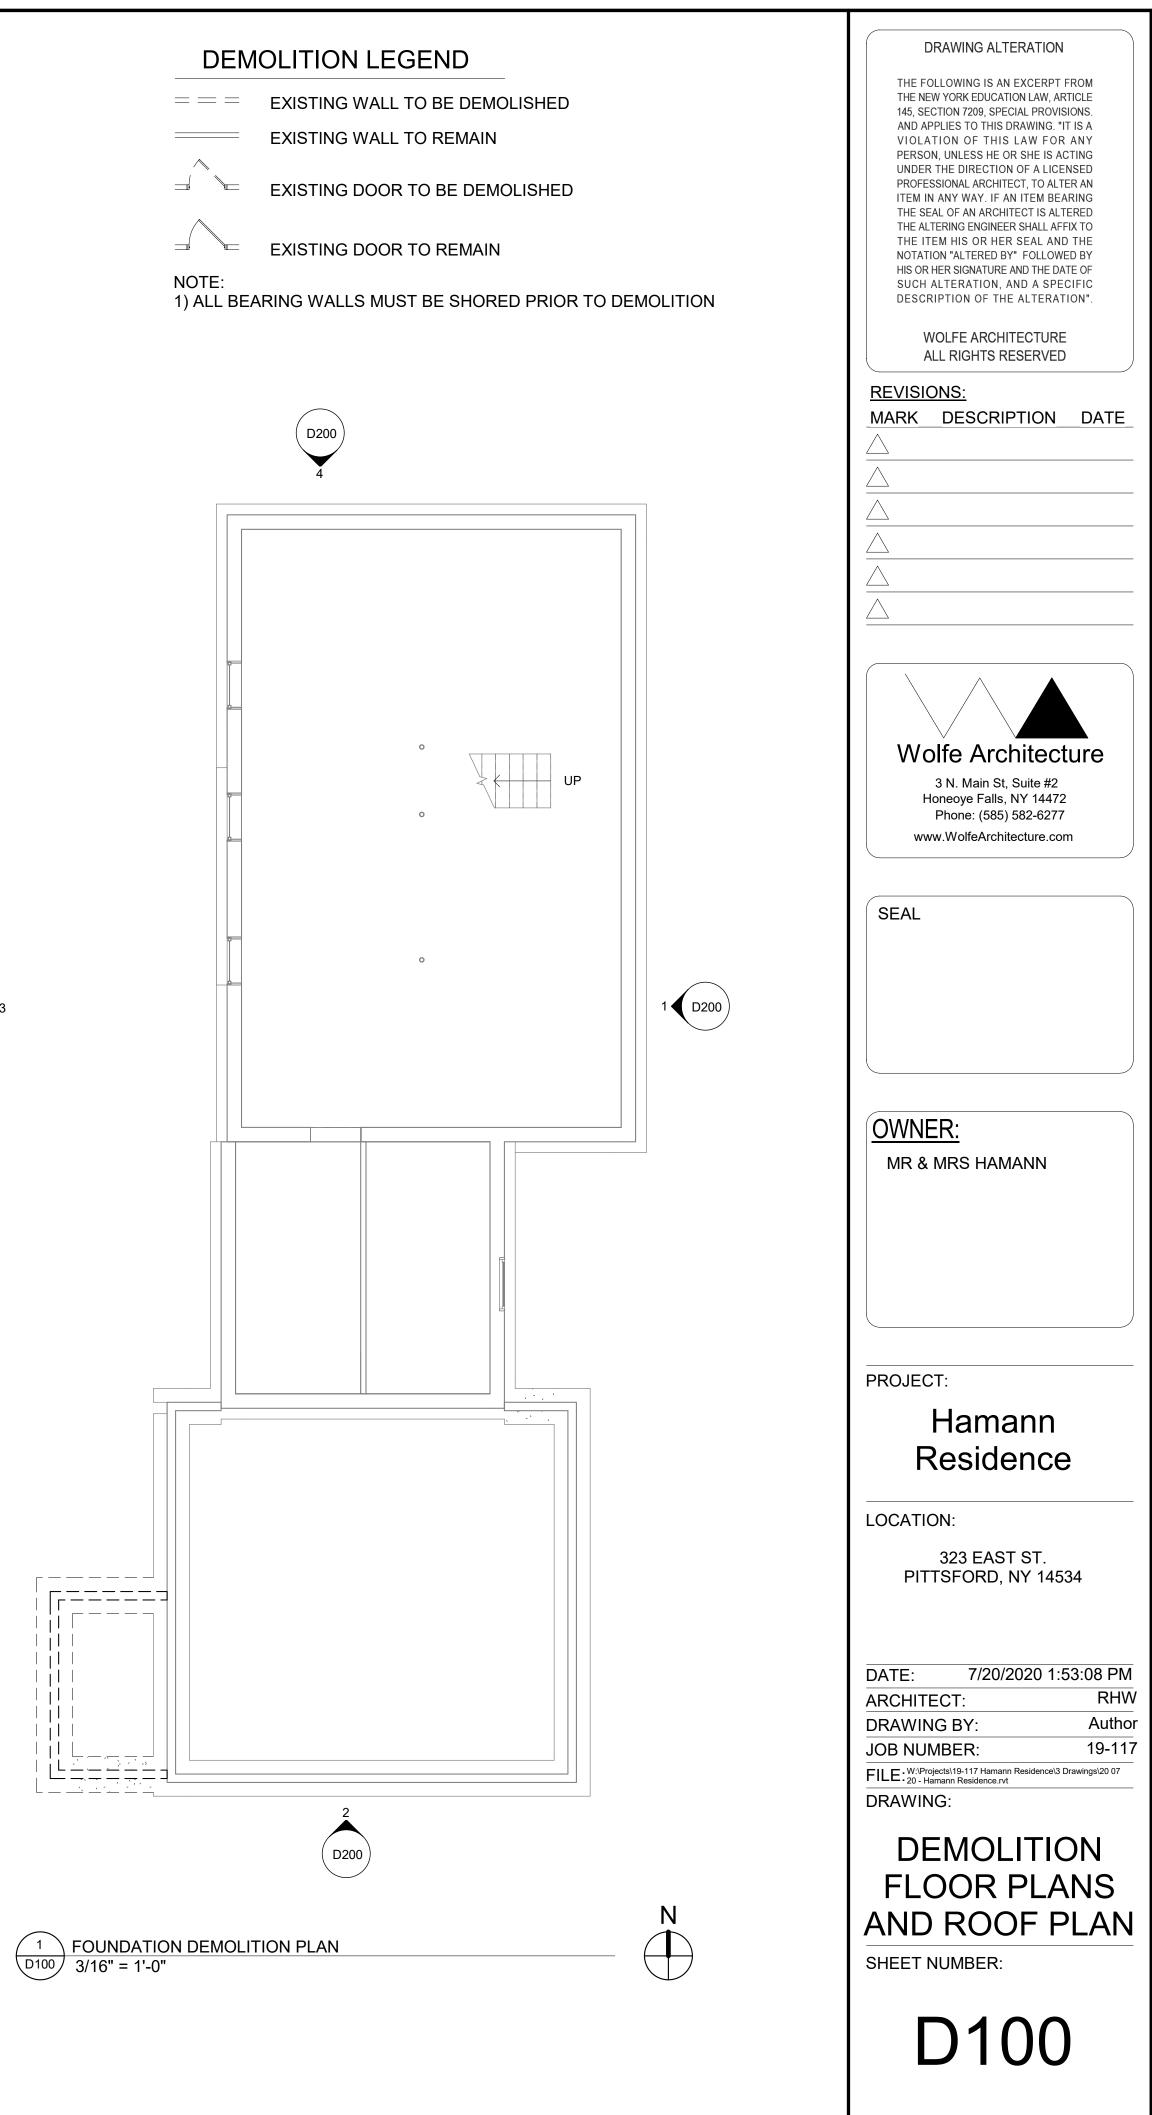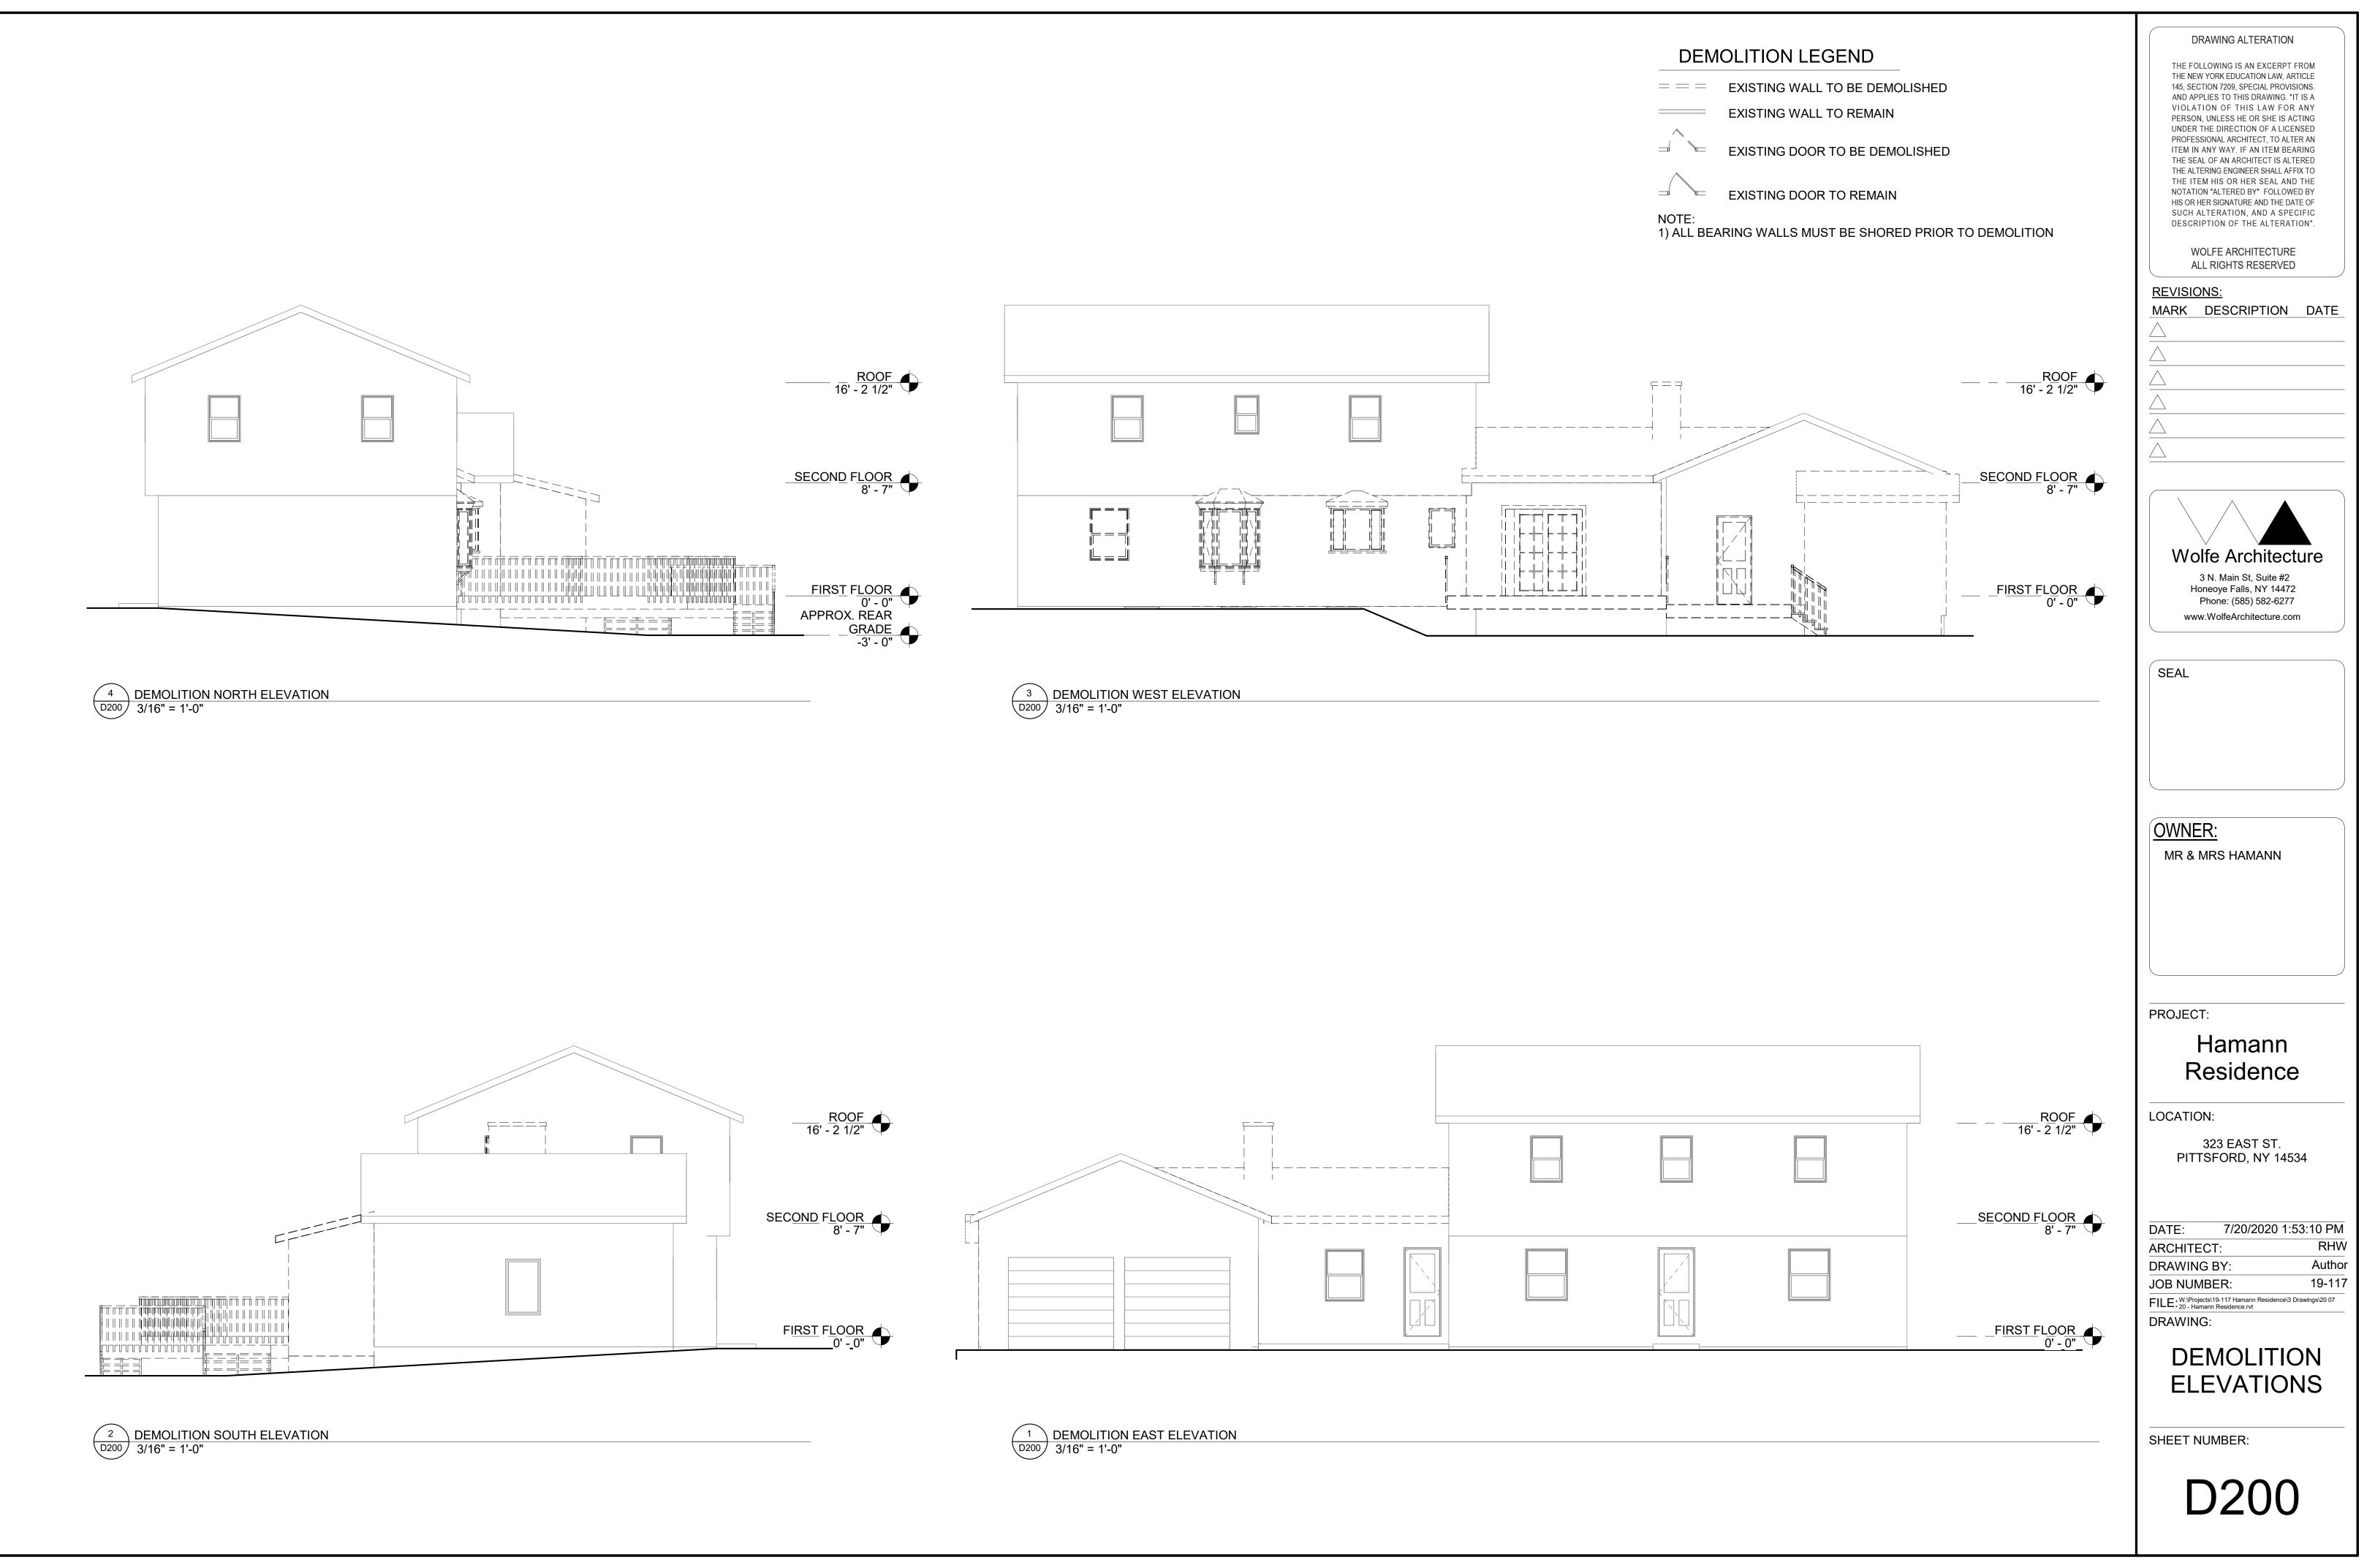
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	THE FOLLOWING IS AN EXCERPT FF	
	THE NEW YORK EDUCATION LAW, ART 145, SECTION 7209, SPECIAL PROVISIO	ONS.
	AND APPLIES TO THIS DRAWING. "IT VIOLATION OF THIS LAW FOR A PERSON, UNLESS HE OR SHE IS ACT	ANY
	UNDER THE DIRECTION OF A LICEN PROFESSIONAL ARCHITECT. TO ALTER	SED
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	WOLFE ARCHITECTURE	
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	Honeoye Falls, NY 14472 Phone: (585) 582-6277	
	www.WolfeArchitecture.com	
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	Hamann	
	Residence	
LOC	CATION:	
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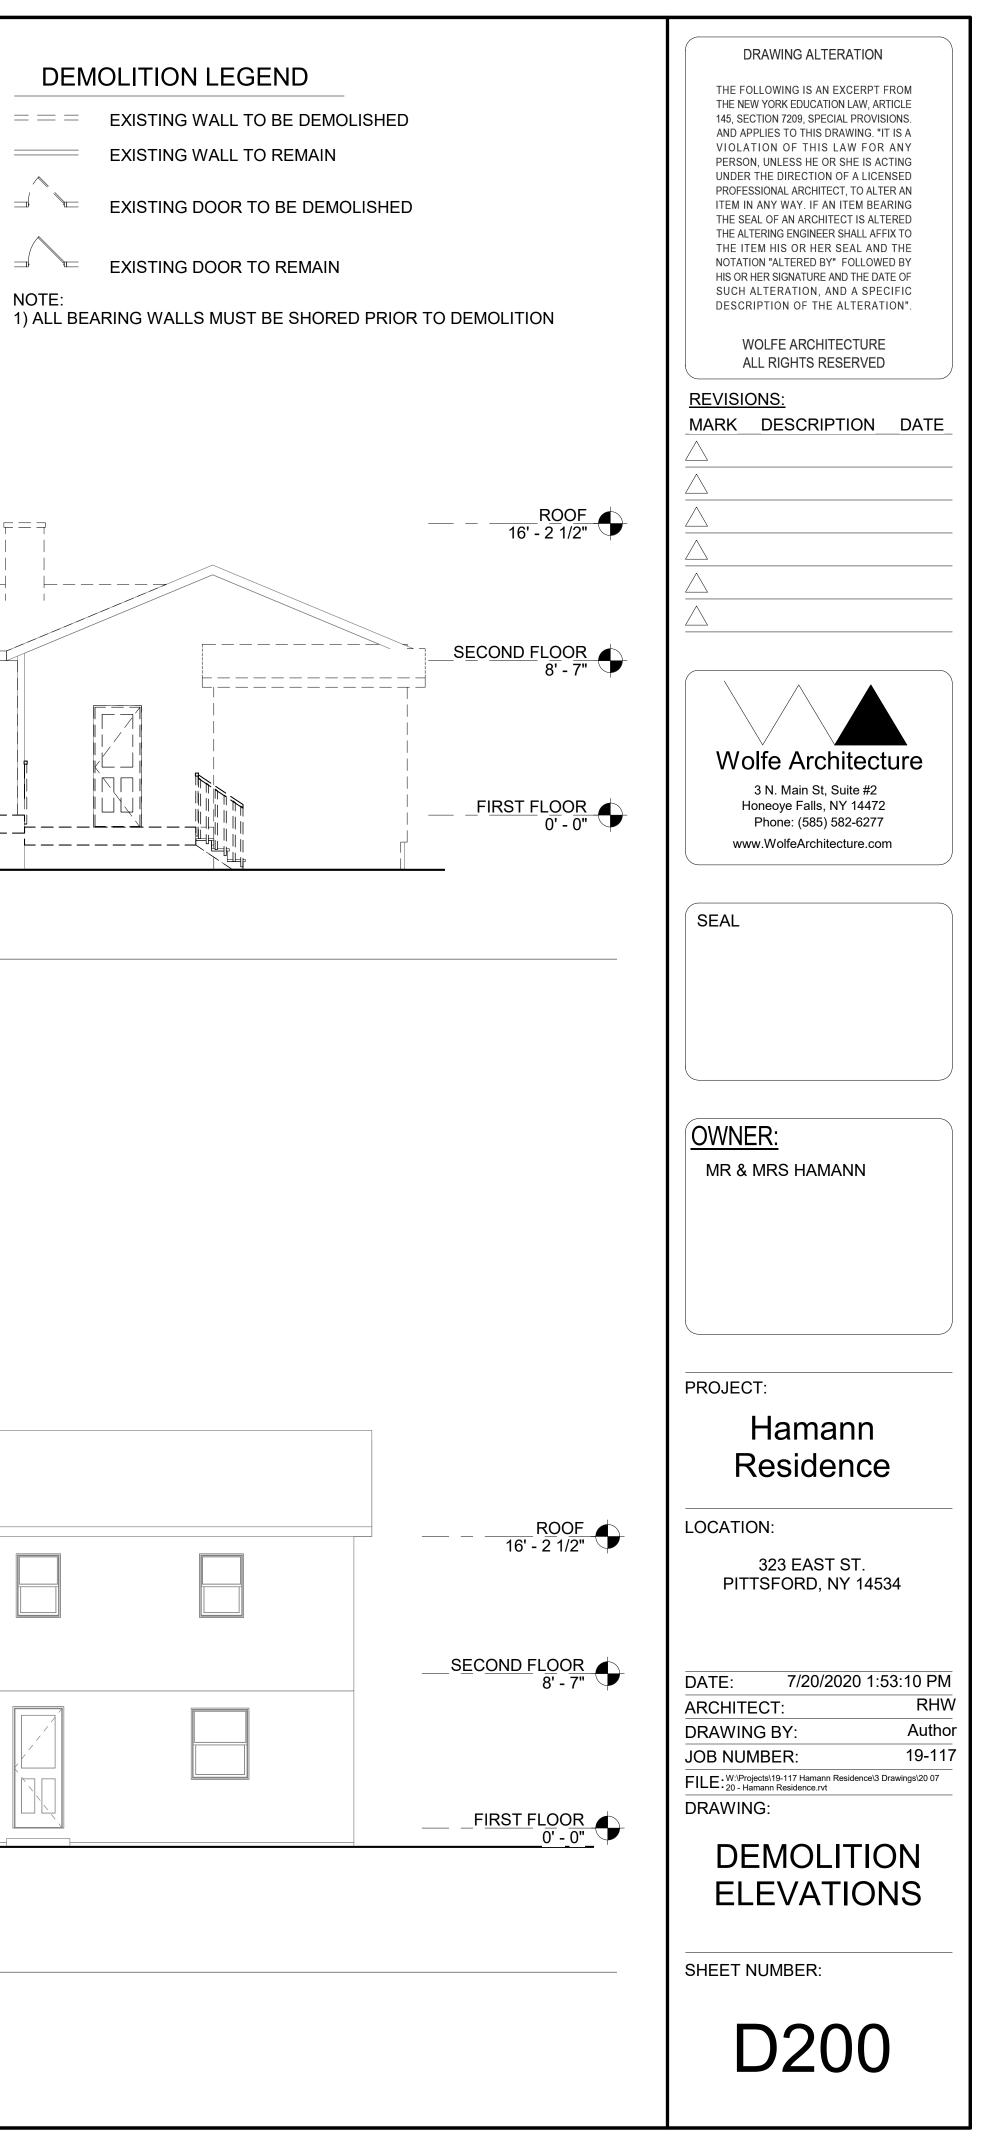


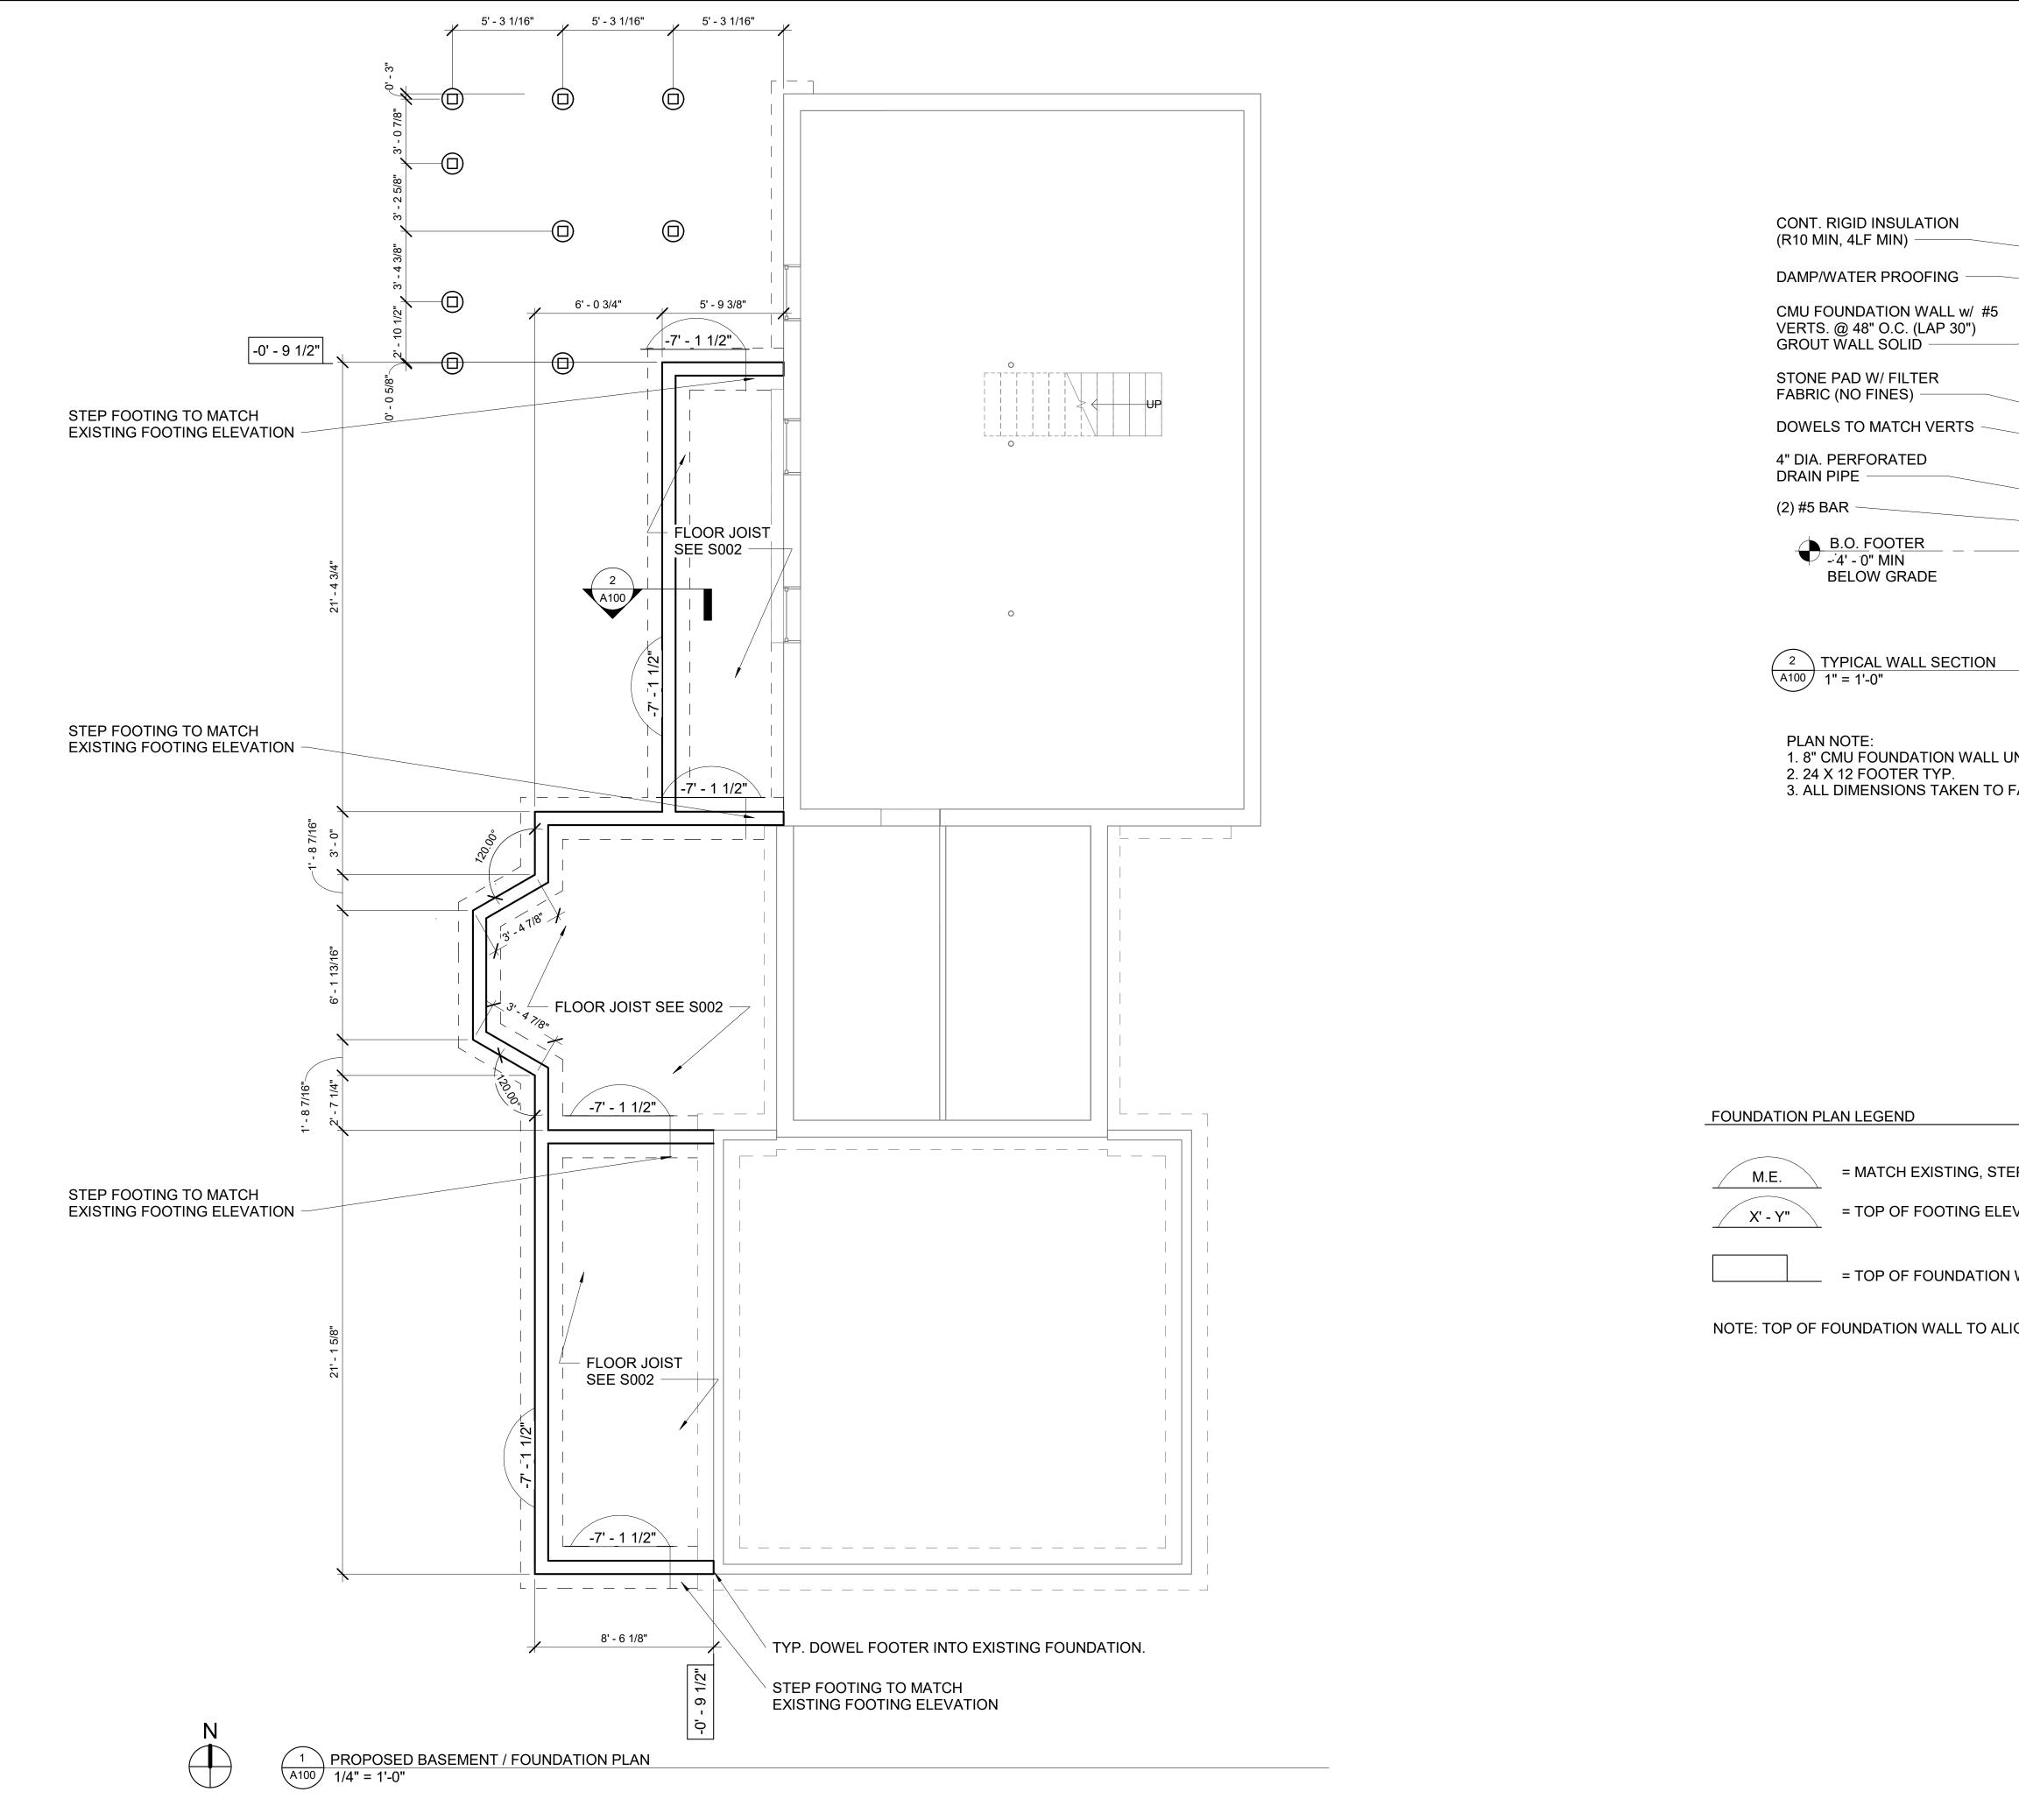


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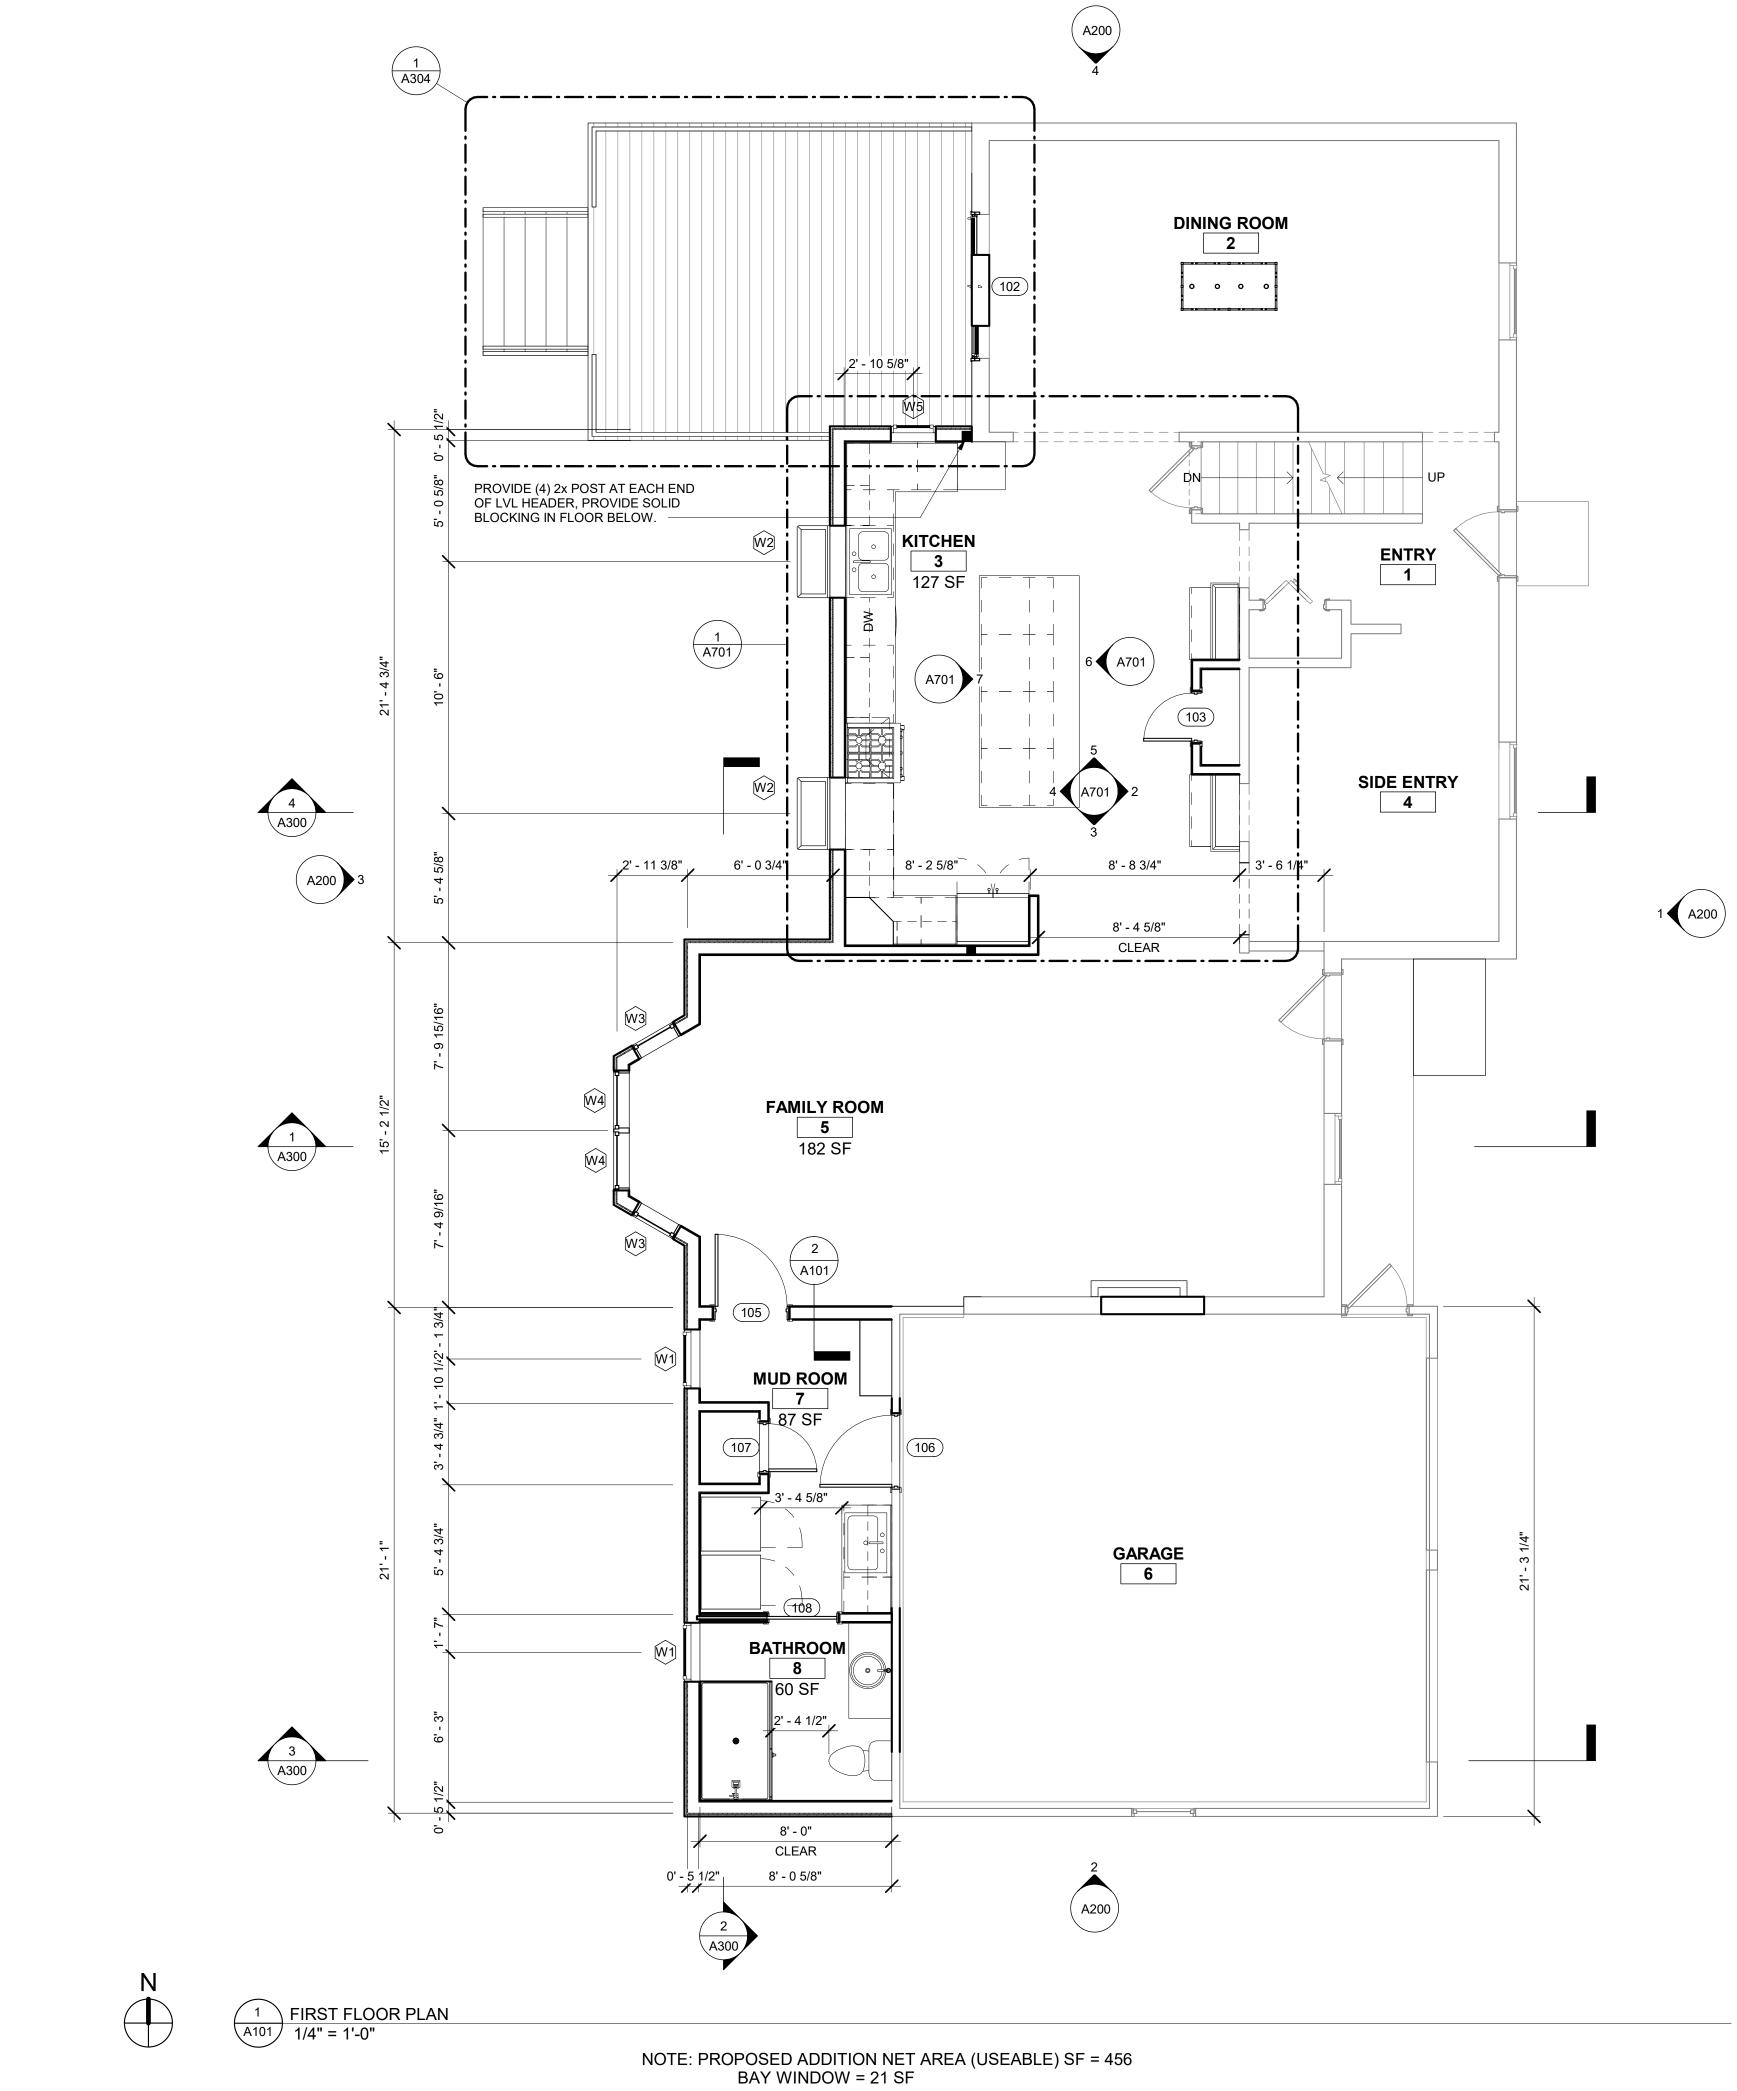




INLESS NOTED OTHERWISE. FACE OF FOUNDATION U.N.O.
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WALL ELEVATION CHANGE GN WITH EXISTING.

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PROJECT:
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LOCATION:
323 EAST ST.
PITTSFORD, NY 14534
DATE: 7/20/2020 1:52:51 PM ARCHITECT: RHW
DRAWING BY: Author JOB NUMBER: 19-117
FILE: W:\Projects\19-117 Hamann Residence\3 Drawings\20 07
FOUNDATION
PLAN
SHEET NUMBER:
A100

DRAWING ALTERATION



<u>GENERAL FIRST F</u> - EXTERIOR WALL MIN. CAVITY INSU VAPOR BARRIER. - PROVIDE WINDO SCHEDULE FOR S - COORDINATE NE ELECTRICAL CON - UPON WIRING CO INSPECTION - PROVIDE 1/2" GY - COORDINATE FIN

- PROVIDE WALL - PROVIDE FLOOR - PROVIDE CASING

<u>PLAN NOTES:</u> 1. ALL NEW WALL PURPOSES.

2. ALL BEARING W STRUCTURAL PLA

3. ALL NON-BEAR

4. ALL CABINET D 5. ALL HINGE SIDE

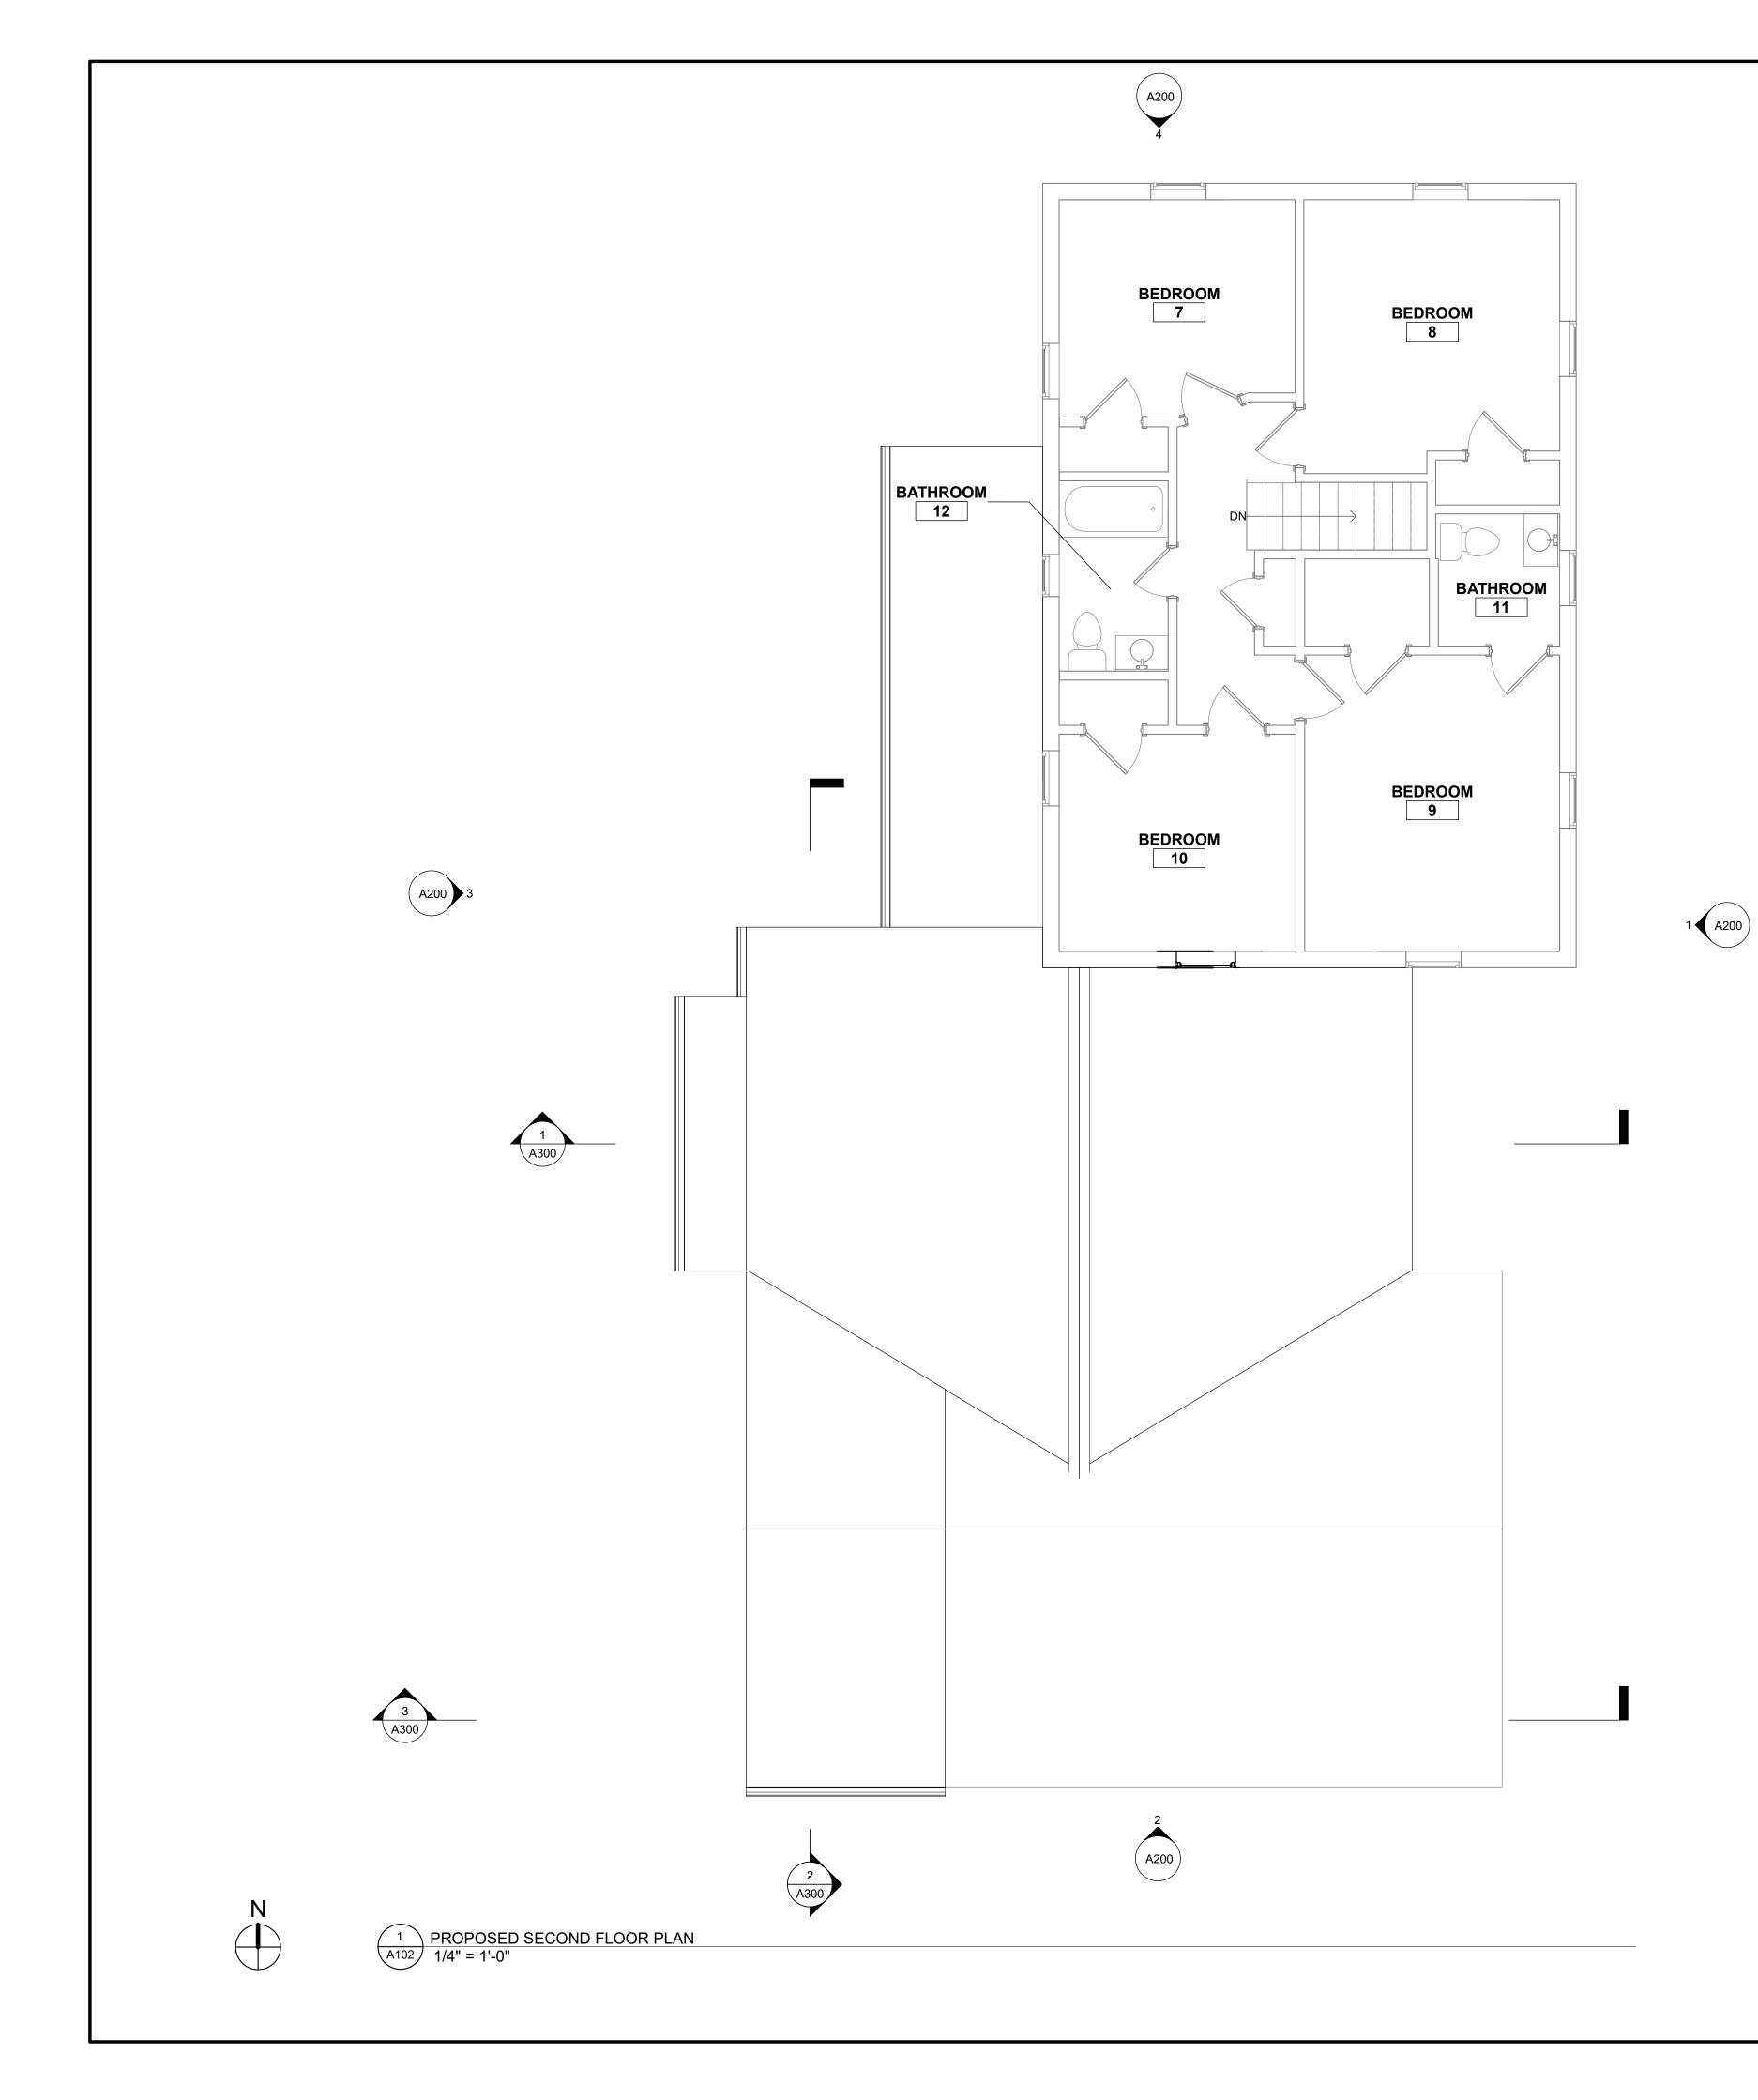
WALL MIN. U.N.O.

6. ALL CLOSET DO 7. REF. 2/A301 FO

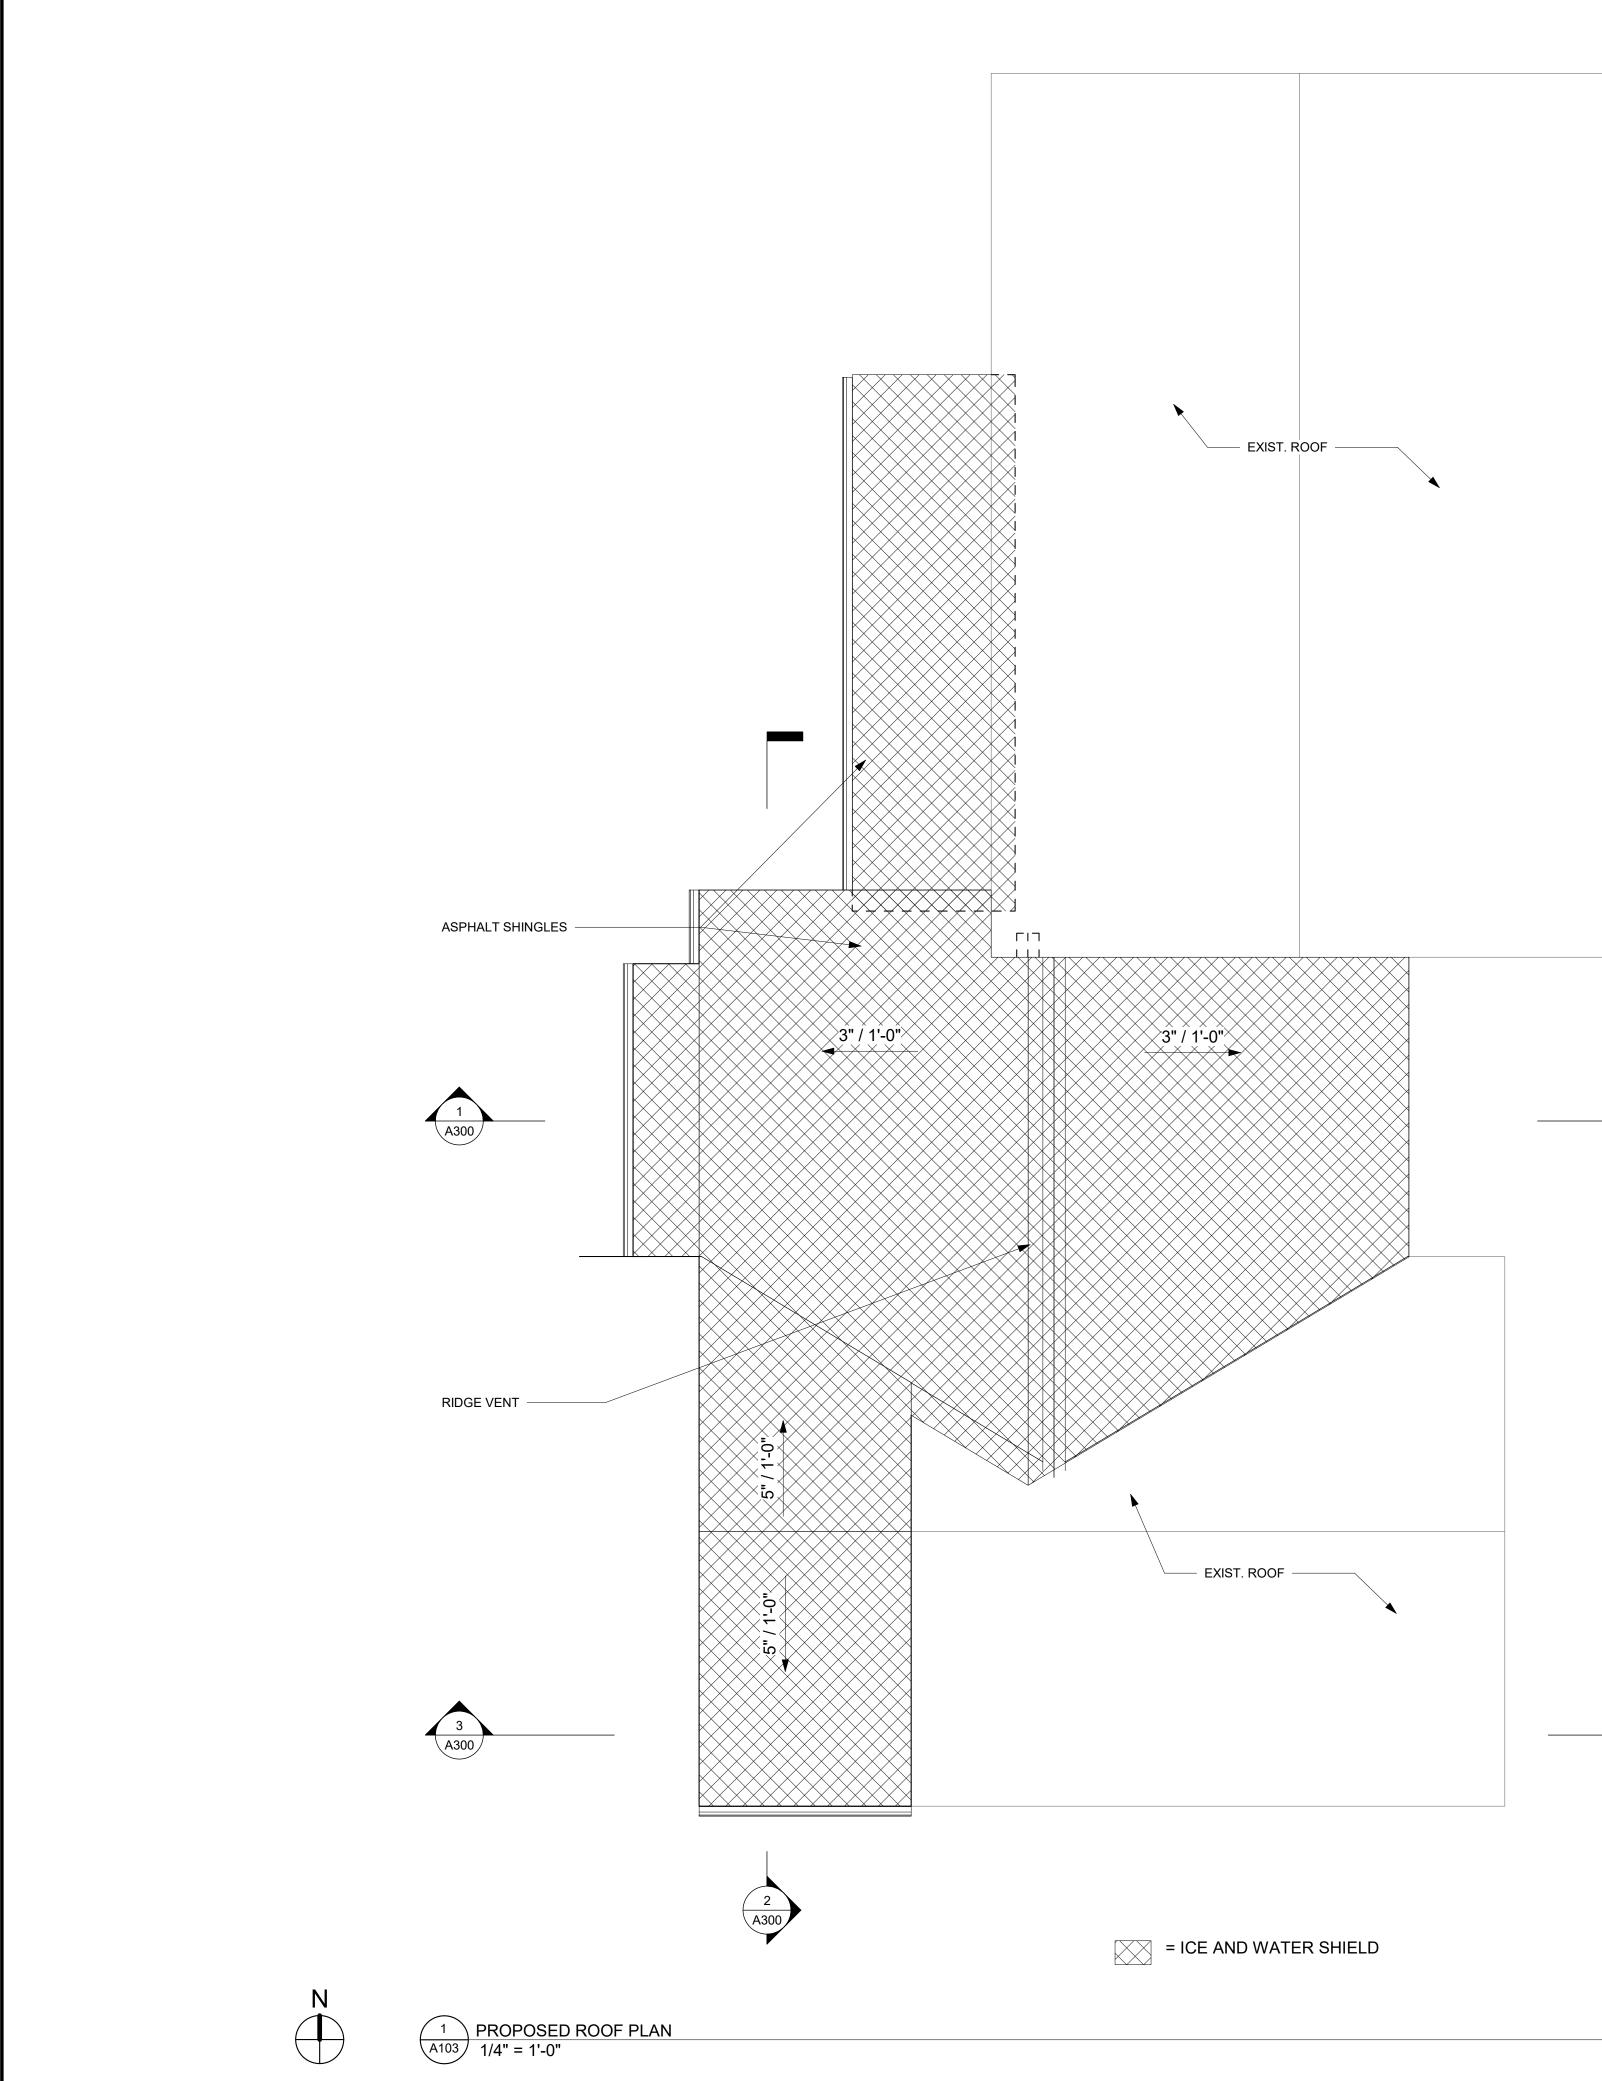
8. REF. HEADER S SEE STRUCTURA

2 2x6 INTERI A101 1" = 1'-0"

	DRAWING ALTERATION
ST FLOOR SCOPE OF WORK: ALLS TO BE 2X6 WD. STUD CONSTRUCTION W/ R-13 ISULATION, R-5 MIN CONTINUOUS INSULATION, AND	THE FOLLOWING IS AN EXCERPT FROM THE NEW YORK EDUCATION LAW, ARTICLE 145, SECTION 7209, SPECIAL PROVISIONS. AND APPLIES TO THIS DRAWING. "IT IS A
ER. U.N.O. SEE STRUCTURAL DRAWINGS. NDOWS AS INDICATED - REFER TO HEADER	VIOLATION OF THIS LAW FOR ANY PERSON, UNLESS HE OR SHE IS ACTING UNDER THE DIRECTION OF A LICENSED
OR SIZING E NEW ELECTRICAL WIRING & FIXTURE DIAGRAM W/ CONTRACTOR G COMPLETION, CONTACT BUILDING OFFICIAL FOR	PROFESSIONAL ARCHITECT, TO ALTER AN ITEM IN ANY WAY. IF AN ITEM BEARING THE SEAL OF AN ARCHITECT IS ALTERED THE ALTERING ENGINEER SHALL AFFIX TO THE ITEM HIS OR HER SEAL AND THE NOTATION "ALTERED BY" FOLLOWED BY HIS OR HER SIGNATURE AND THE DATE OF
' GYP. WALLS/ CEILINGS E FINISHES W/ OWNER JLL PAINT - COORDINATE W/ OWNER DORING - COORDINATE W/ OWNER SING AND TRIM - COORDINATE W/ OWNER	WOLFE ARCHITECTURE ALL RIGHTS RESERVED
	REVISIONS: MARK DESCRIPTION DATE
ALL DIMENSIONS, TO FACE OF DRYWALL FOR LAYOUT	$\frac{\bigtriangleup}{\bigtriangleup}$
G WALLS TO BE 2X6 WOOD CONSTRUCTION U.N.O. SEE PLANS.	$\frac{\bigtriangleup}{\bigtriangleup}$
ARING WALLS TO BE 2X4 WOOD CONSTRUCTION U.N.O.	$\frac{\bigtriangleup}{\swarrow}$
T DIMENSIONS TO BASE UNITS. SIDE DOOR JAMBS TO BE 9" FROM ADJACENT FINISHED	
I.O. SEE A800. DOORS TO BE CENTERED ON CLOSET AREA U.N.O.	
FOR WALL TYPES	Wolfe Architecture 3 N. Main St, Suite #2
R SCHEDULE FOR DOOR AND WINDOW HEADER SIZING. RAL DRAWINGS FOR DETAILS.	Honeoye Falls, NY 14472 Phone: (585) 582-6277 www.WolfeArchitecture.com
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0' - 6 3/4"	MR & MRS HAMANN
CEILING	
5/8" GWB FINISH - EACH SIDE	
2x6" WOOD FRAMING	PROJECT:
	Hamann Residence
	LOCATION:
	323 EAST ST. PITTSFORD, NY 14534
	DATE: 7/20/2020 1:52:52 PM ARCHITECT: RHW DRAWING BY: Author
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	SHEET NUMBER:
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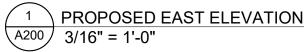


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SUCH ALTERATION, AND A SPECIFIC DESCRIPTION OF THE ALTERATION".
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SEAL
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Hamann Residence
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LOCATION: 323 EAST ST.
LOCATION: 323 EAST ST.
Residence LOCATION: 323 EAST ST. PITTSFORD, NY 14534
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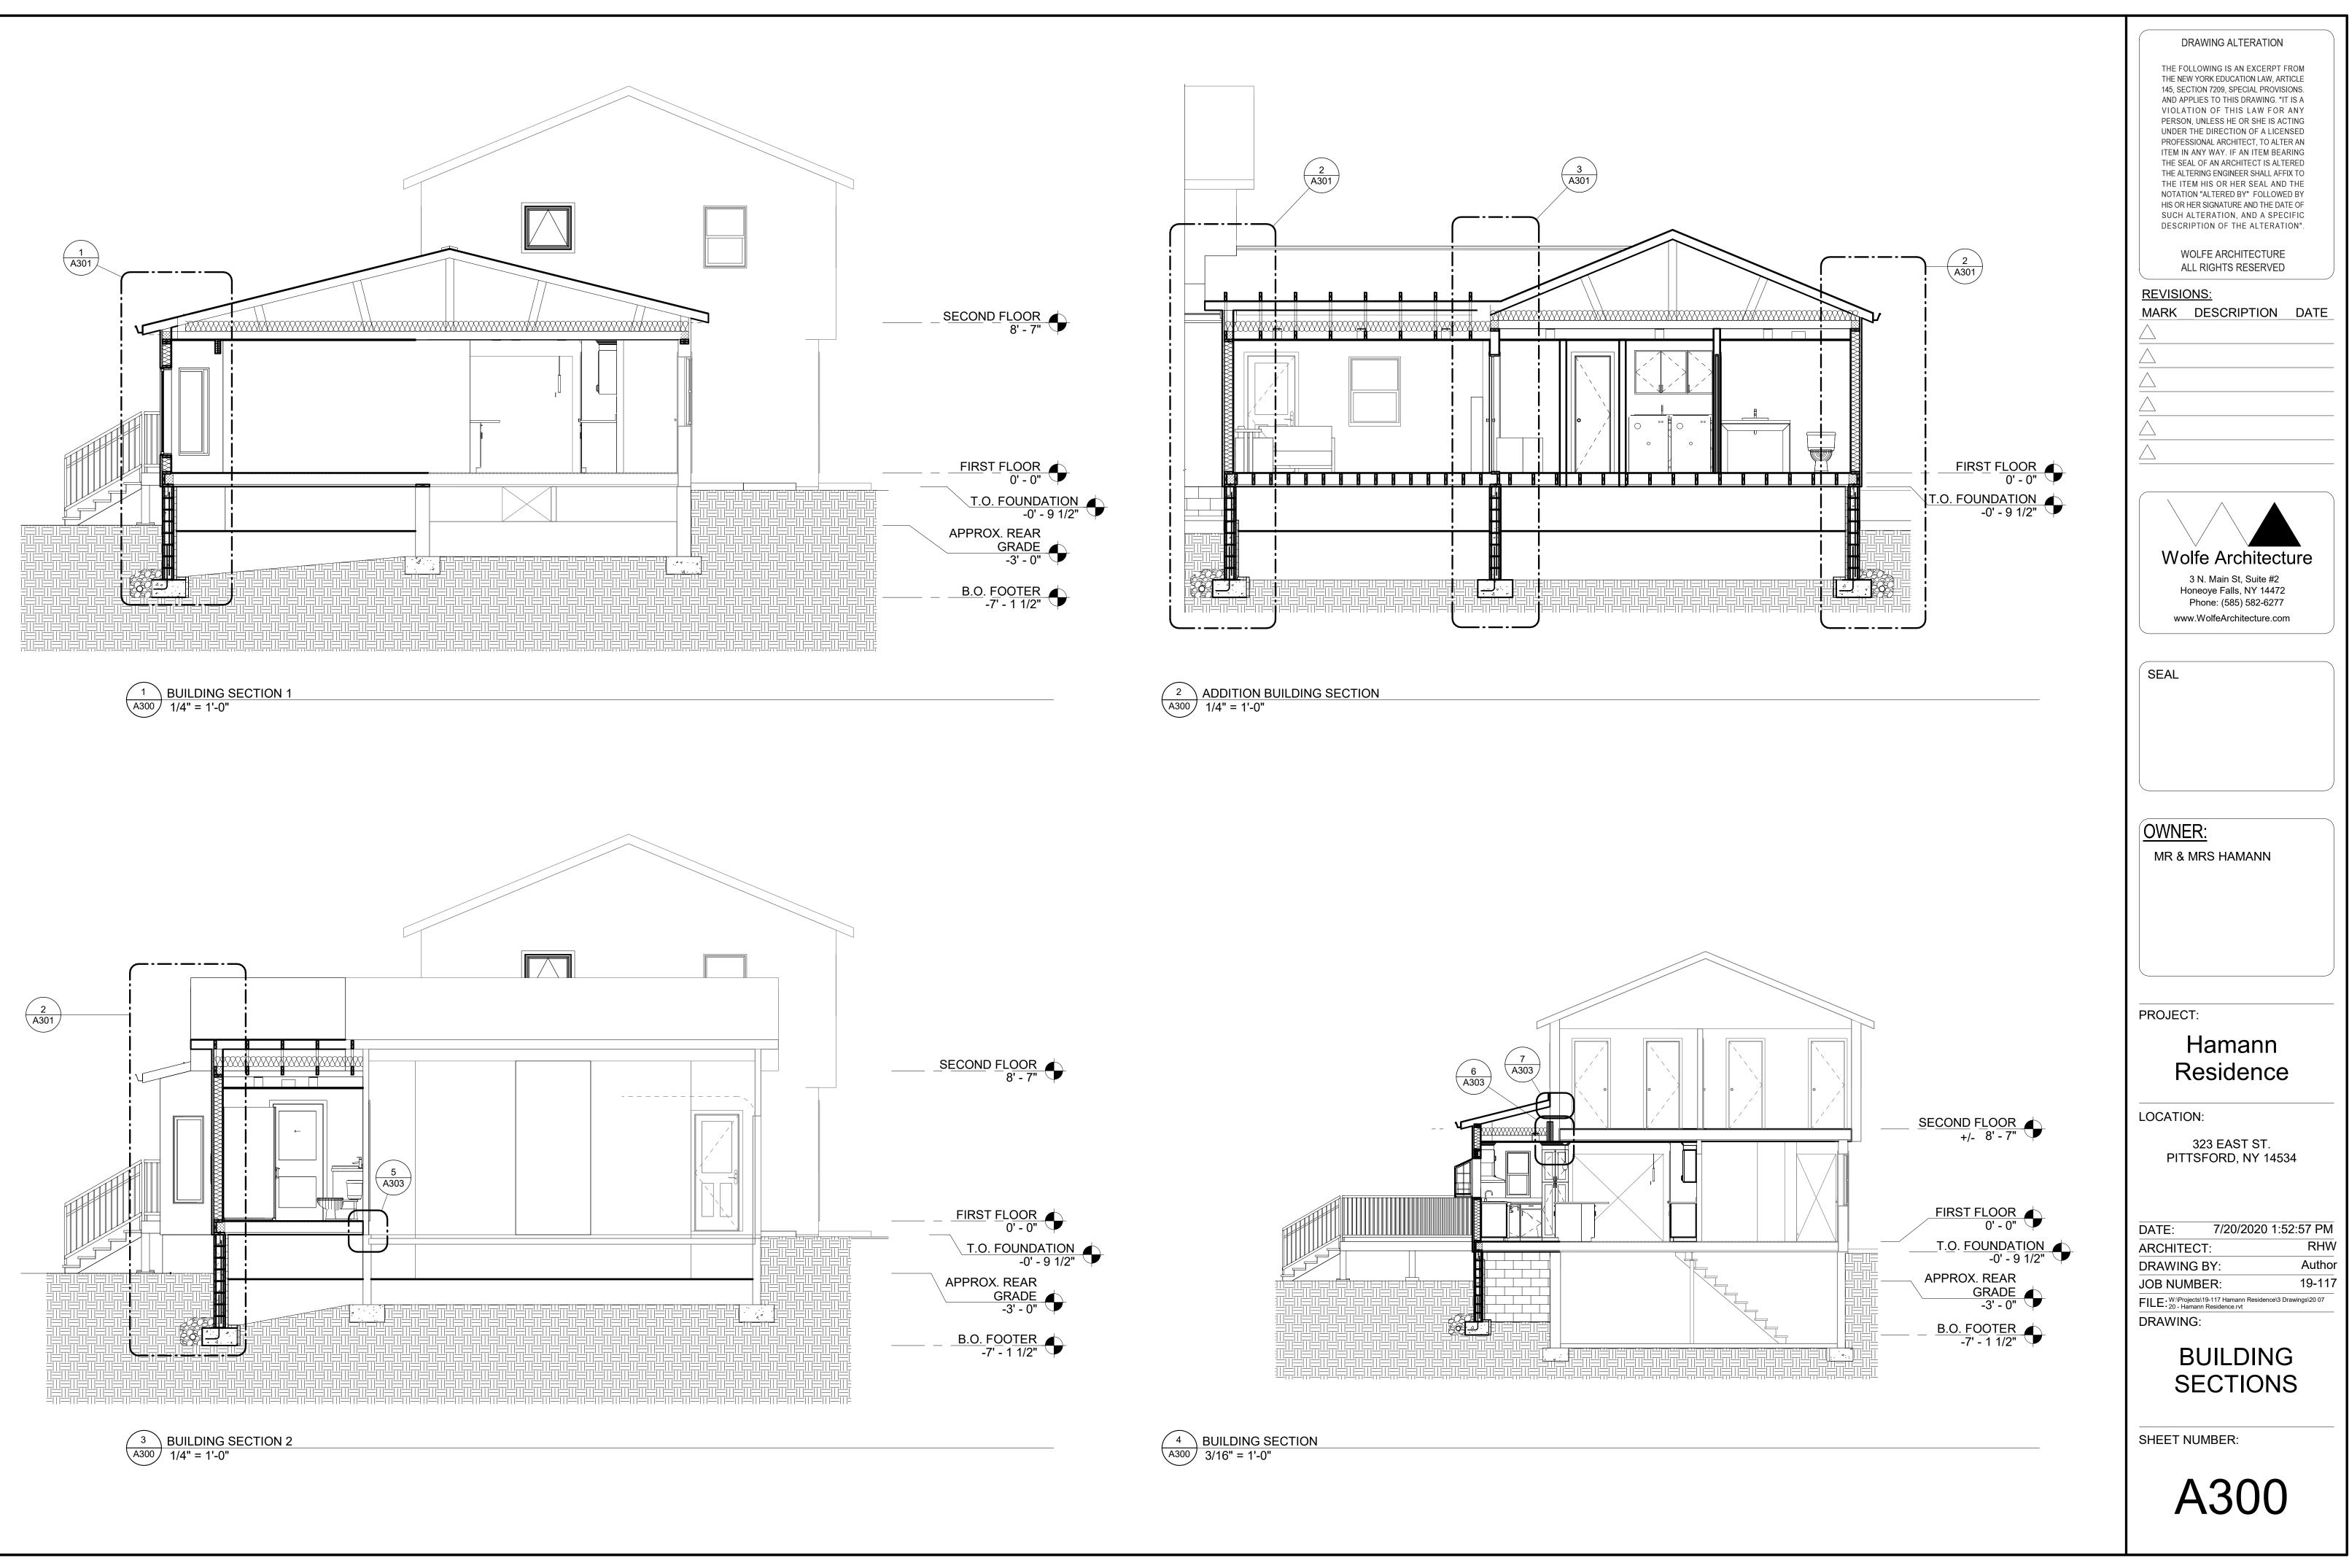


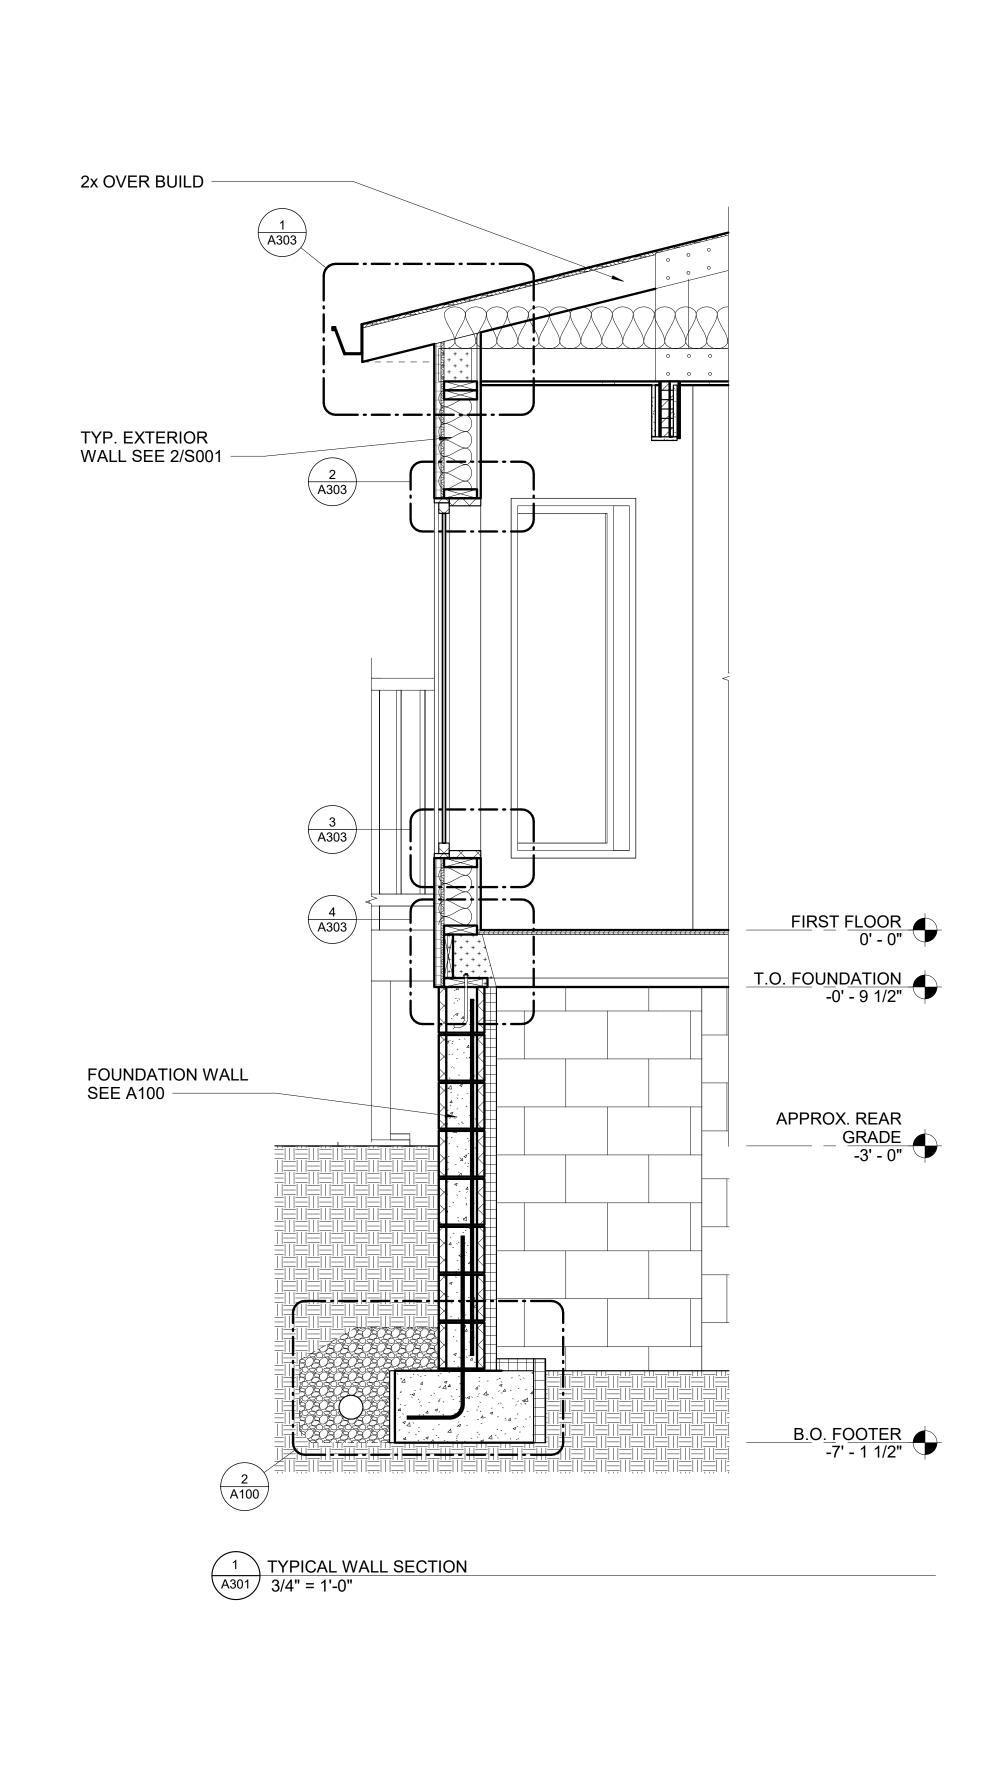
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PROJECT:
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PROJECT: Hamann
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Hamann Residence
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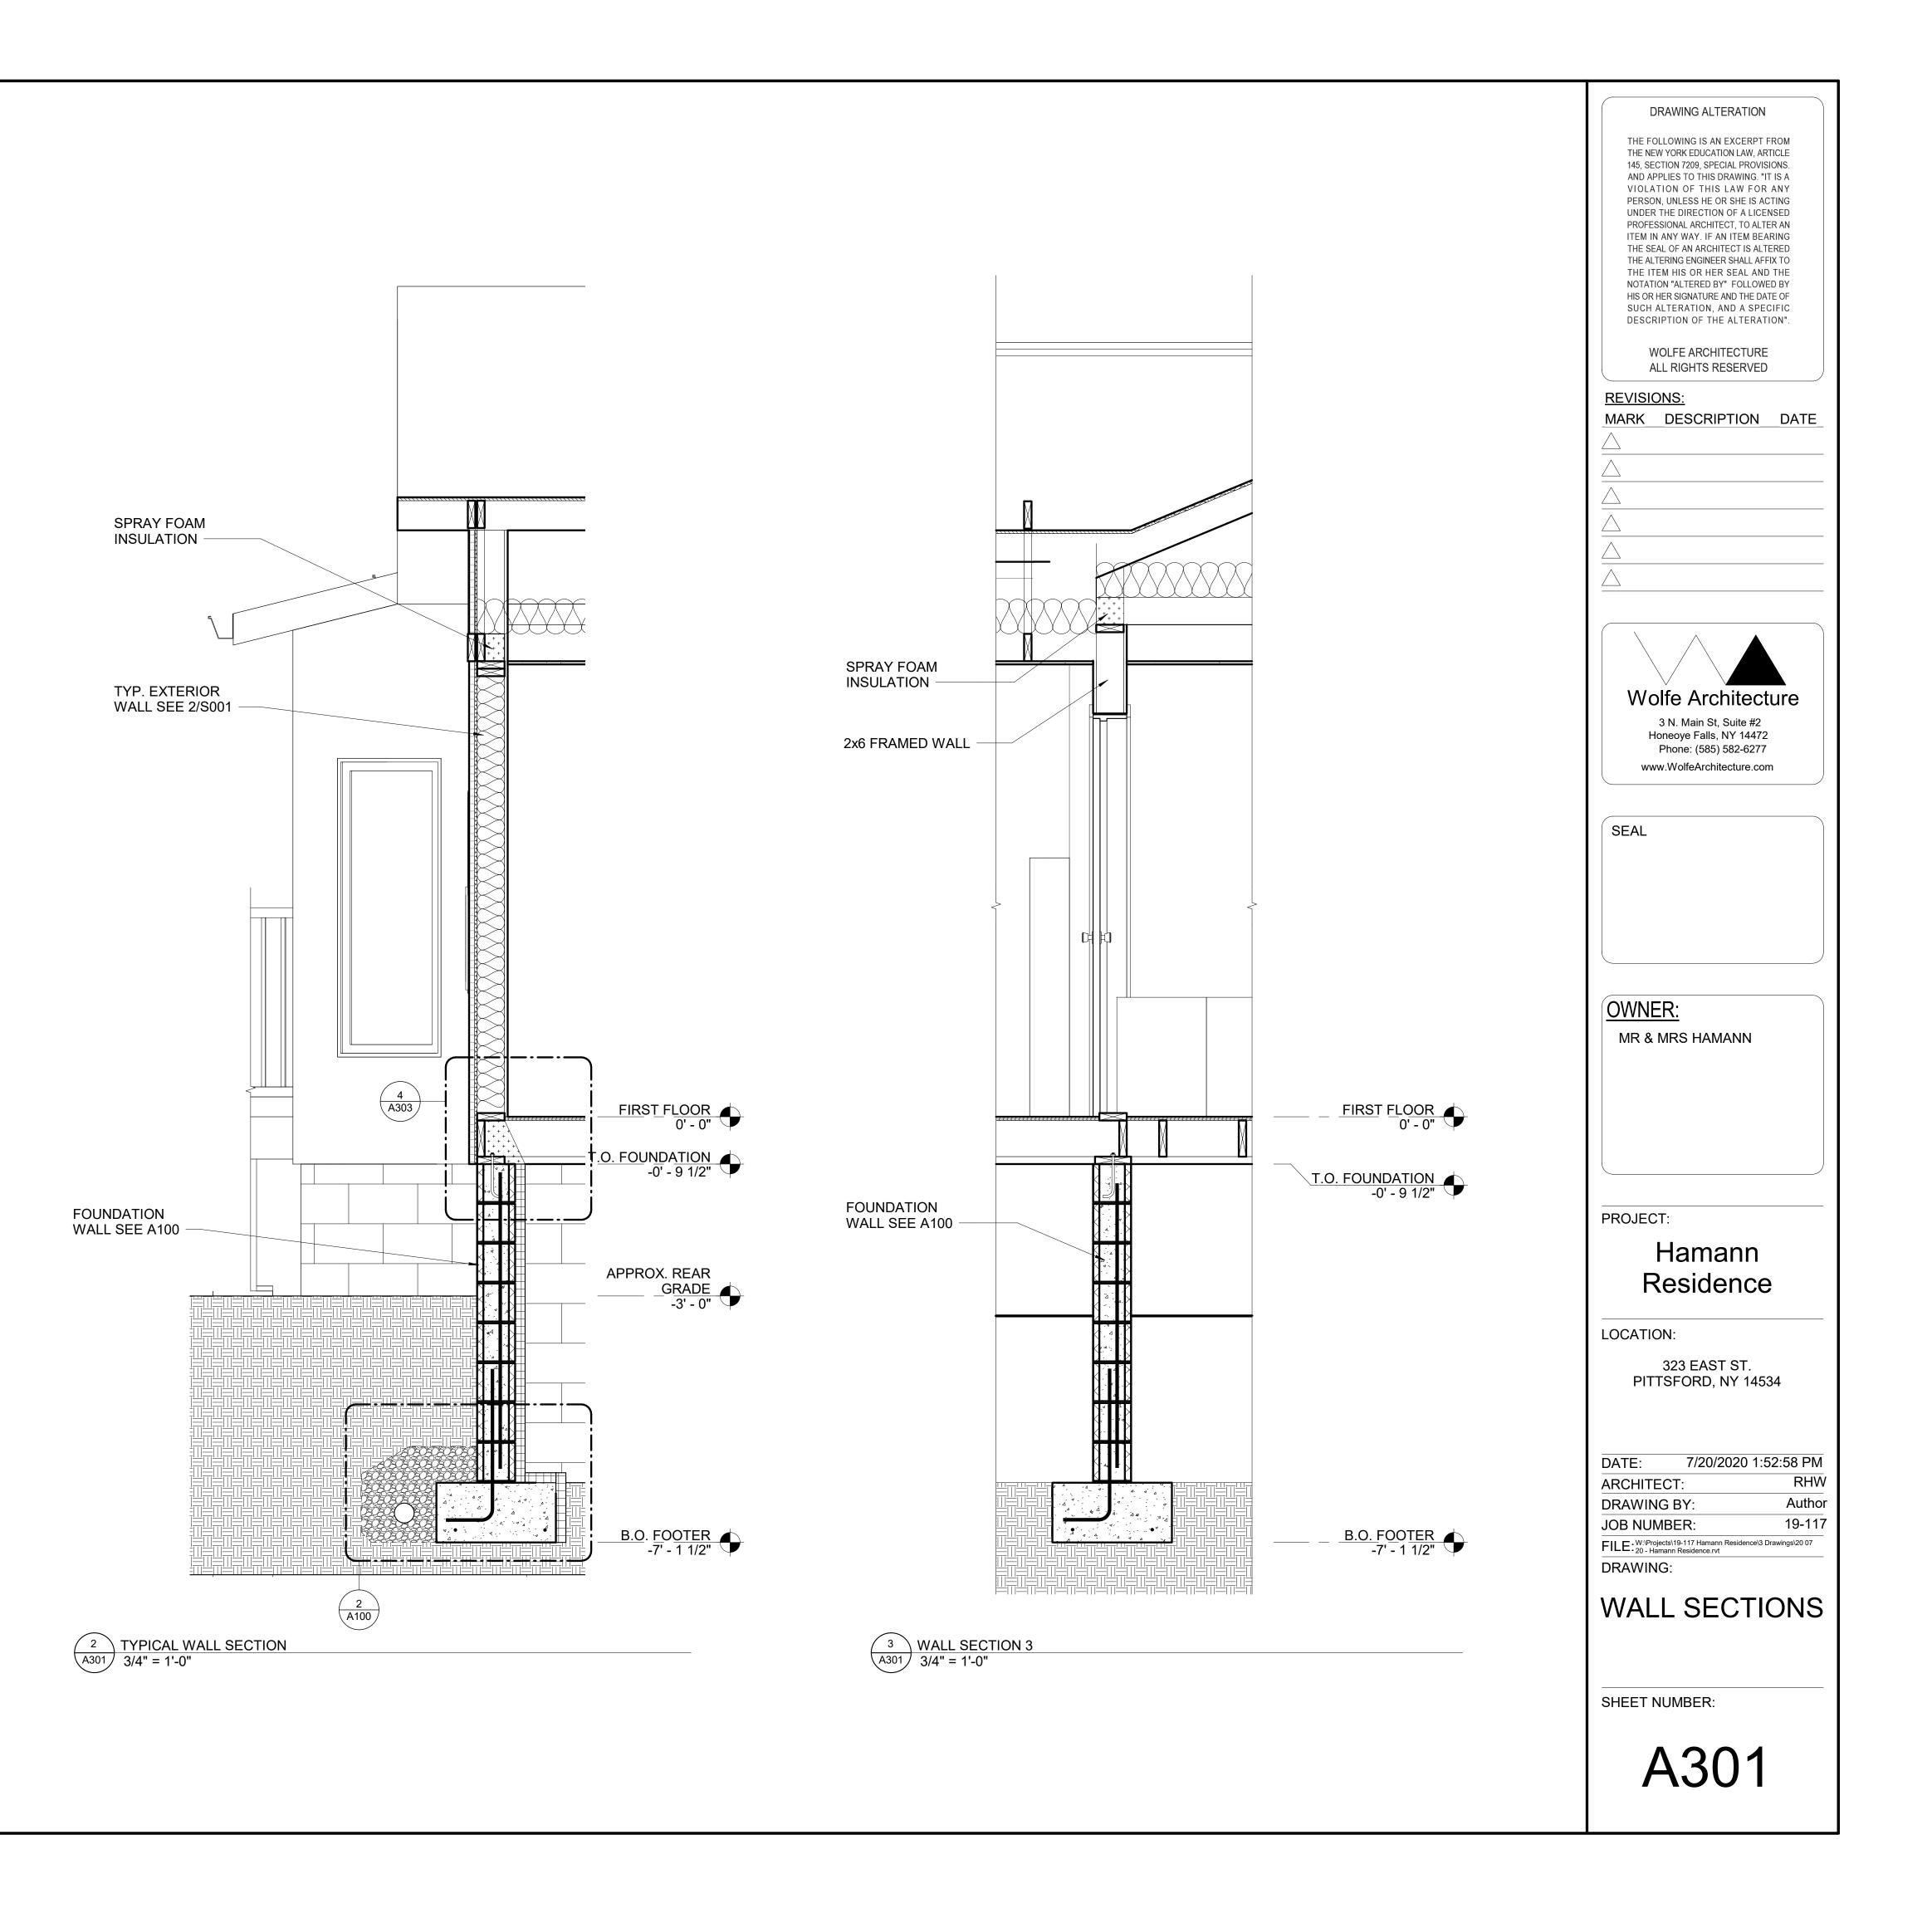




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	$\frac{\Delta}{\Delta}$
5" 1'-0" 5" / 1'-0" <u>SECOND</u> FLOOR 8' - 7"	
8' - 7" 🔎	
$\frac{1}{0' - 0''} = \frac{1}{0' - 0''}$	Wolfe Architecture3 N. Main St, Suite #2Honeoye Falls, NY 14472Phone: (585) 582-6277www.WolfeArchitecture.com
	SEAL
	OWNER: MR & MRS HAMANN
	PROJECT: Hamann
<u>ROOF</u> 16' - 2 1/2"	
SECOND FLOOR 8' - 7"	323 EAST ST. PITTSFORD, NY 14534
8' - 7" \	DATE: 7/20/2020 1:52:55 PM
	ARCHITECT:RHWDRAWING BY:AuthorJOB NUMBER:19-117
<u>0'</u> - 0"	FILE W:\Projects\19-117 Hamann Residence\3 Drawings\20 07 20 - Hamann Residence.rvt
	EXTERIOR ELEVATIONS
	SHEET NUMBER:
	A200







4	T١	ΥP
A303	1	1/2

PICAL WALL SECTION /2" = 1'-0"


TYP EXTERIOR WALL SEE 2/S002	
3/4" T&G SHEATHING	
2x RIM JOIST	
SPRAY FOAM INSULATION	
• T.O. FOUNDATION	
P.T. 2x8 SILL PLATE W/ 1/2" DIA BOLTS ANCHORED TO FOUNDATION @ 32" O.C. MIN.	
CMU FOUNDATION WALL SEE A100	

3 TYPICAL WALL SECTION (A303) 1 1/2" = 1'-0"

5/8" GWB

TYP EXTERIOR WALL SEE 2/S002

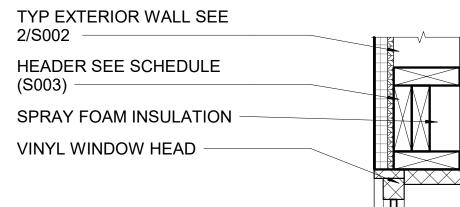2 TYPICAL WALL SECTION A303 1 1/2" = 1'-0"




1 TYPICAL WALL SECTION A303 1 1/2" = 1'-0"

ASPHALT SHINGLES

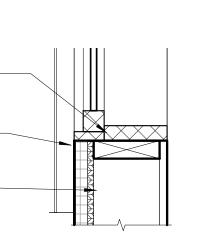
1/2" SHEATHING VENT CHANNEL WITH COMPRESSED INSULATION ROOF INSULATION (R49 MIN) CONT. GUTTER WITH DOWN SPOUTS @ ENDS ALUM DRIP EDGE CONT. 3 1/2" SCREEN SOFFIT VENT SPRAY FOAM INSULATION TYP EXTERIOR WALL SEE 2/S002





ALUM. TRIM w/ DRIP EDGE TO MATCH WINDOW



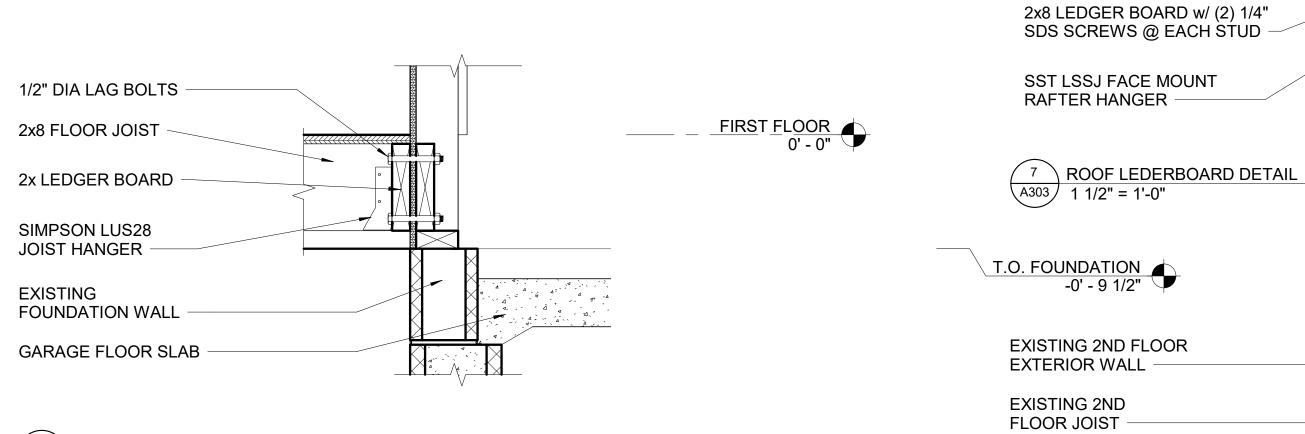

ASPHALT SHINGLES

3/4" SHEATHING ~

2x8 ROOF JOIST

SECOND FLOOR 8' - 7"

BATT INSULATION

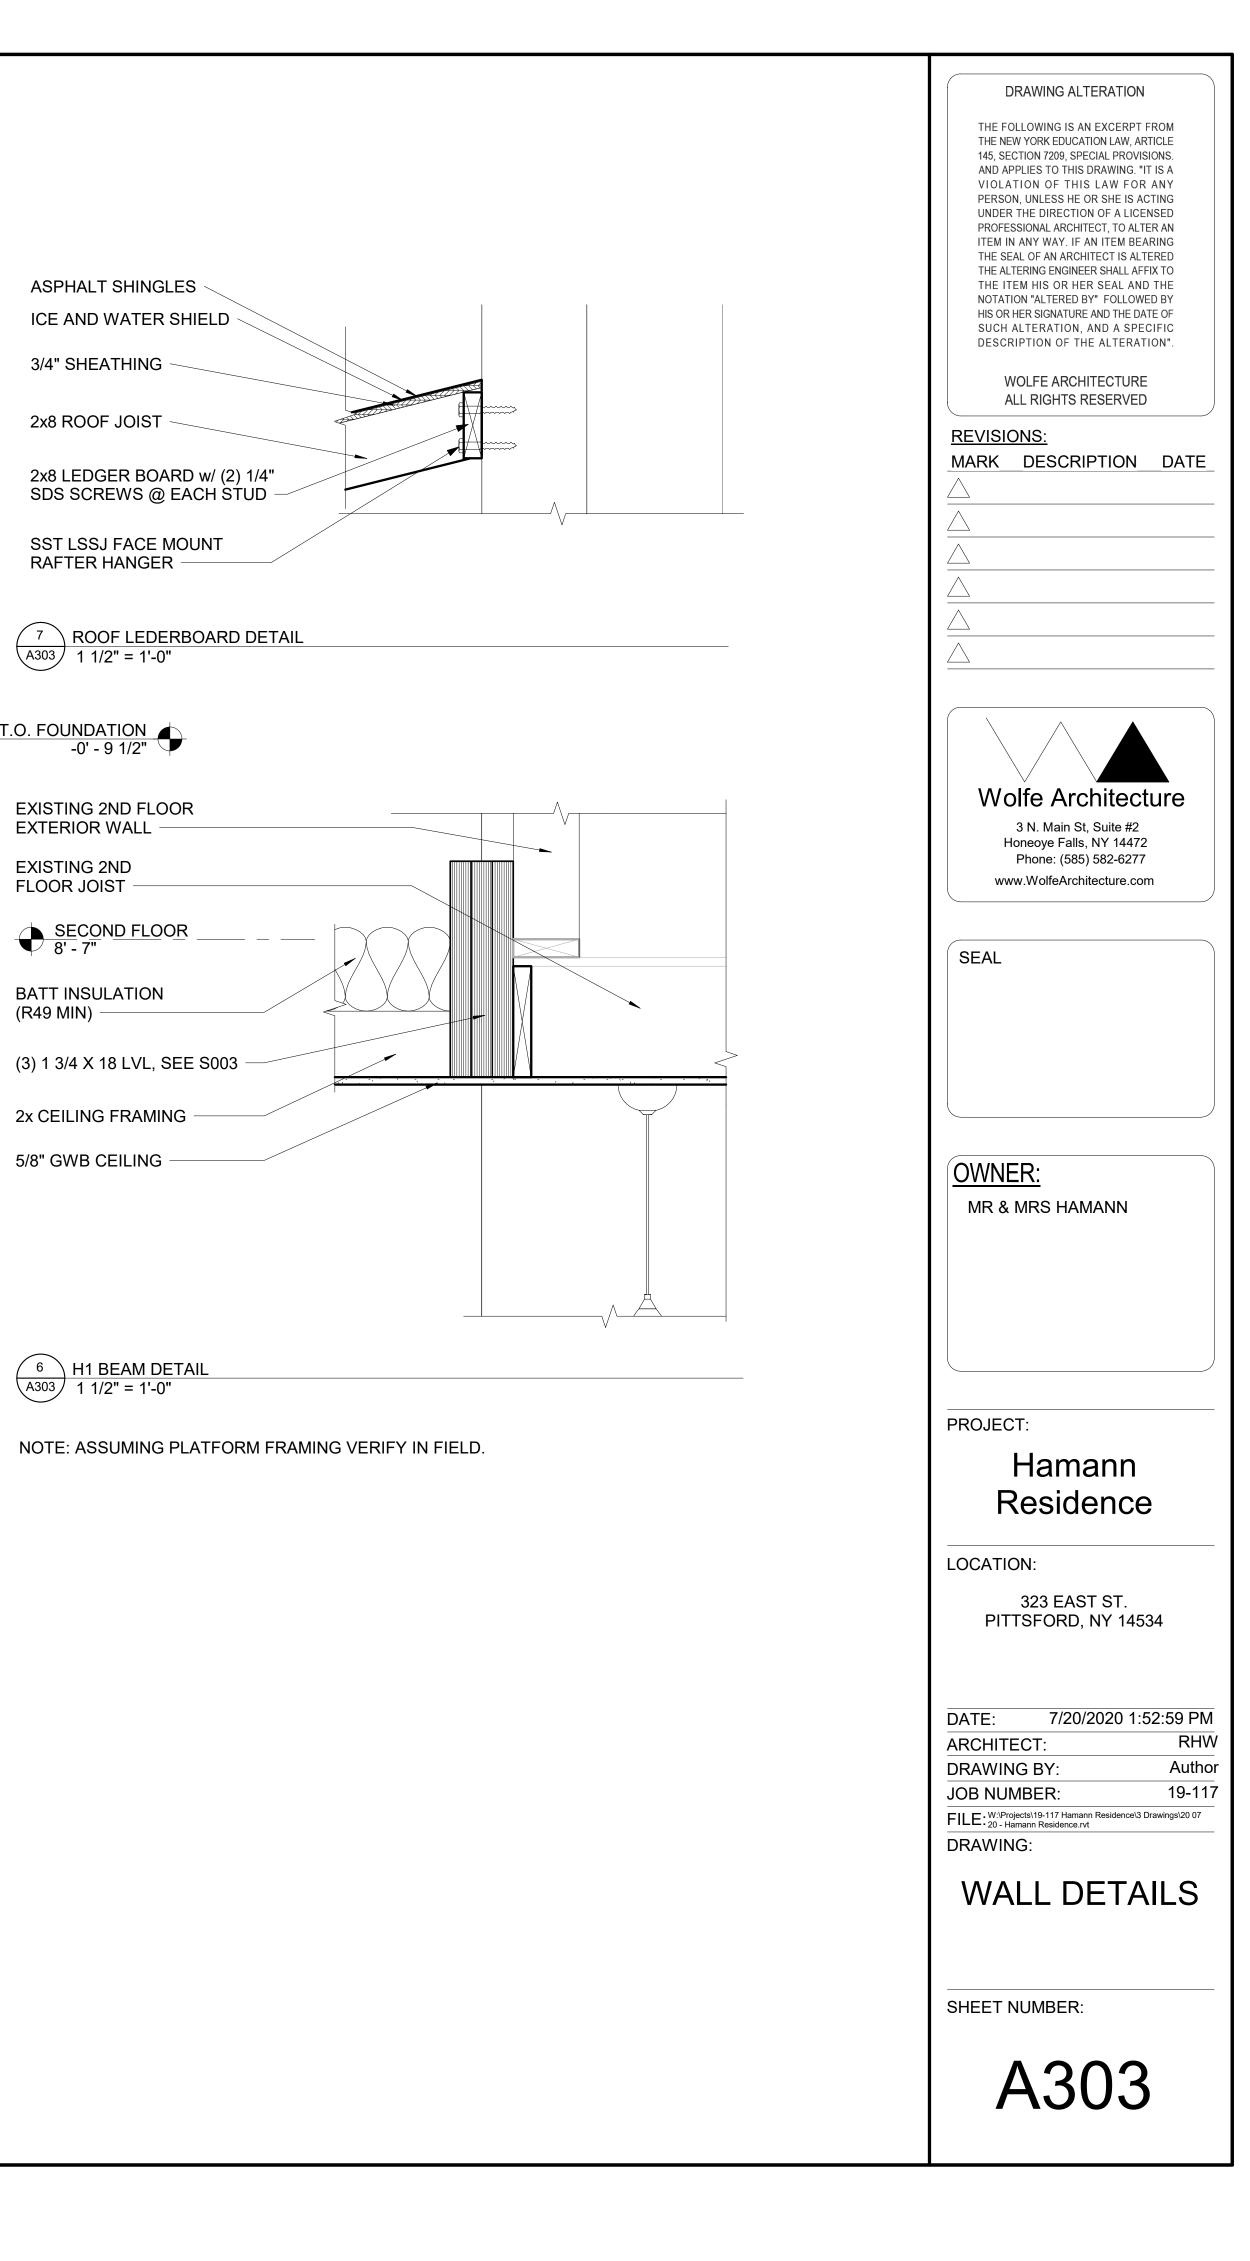
2x CEILING FRAMING

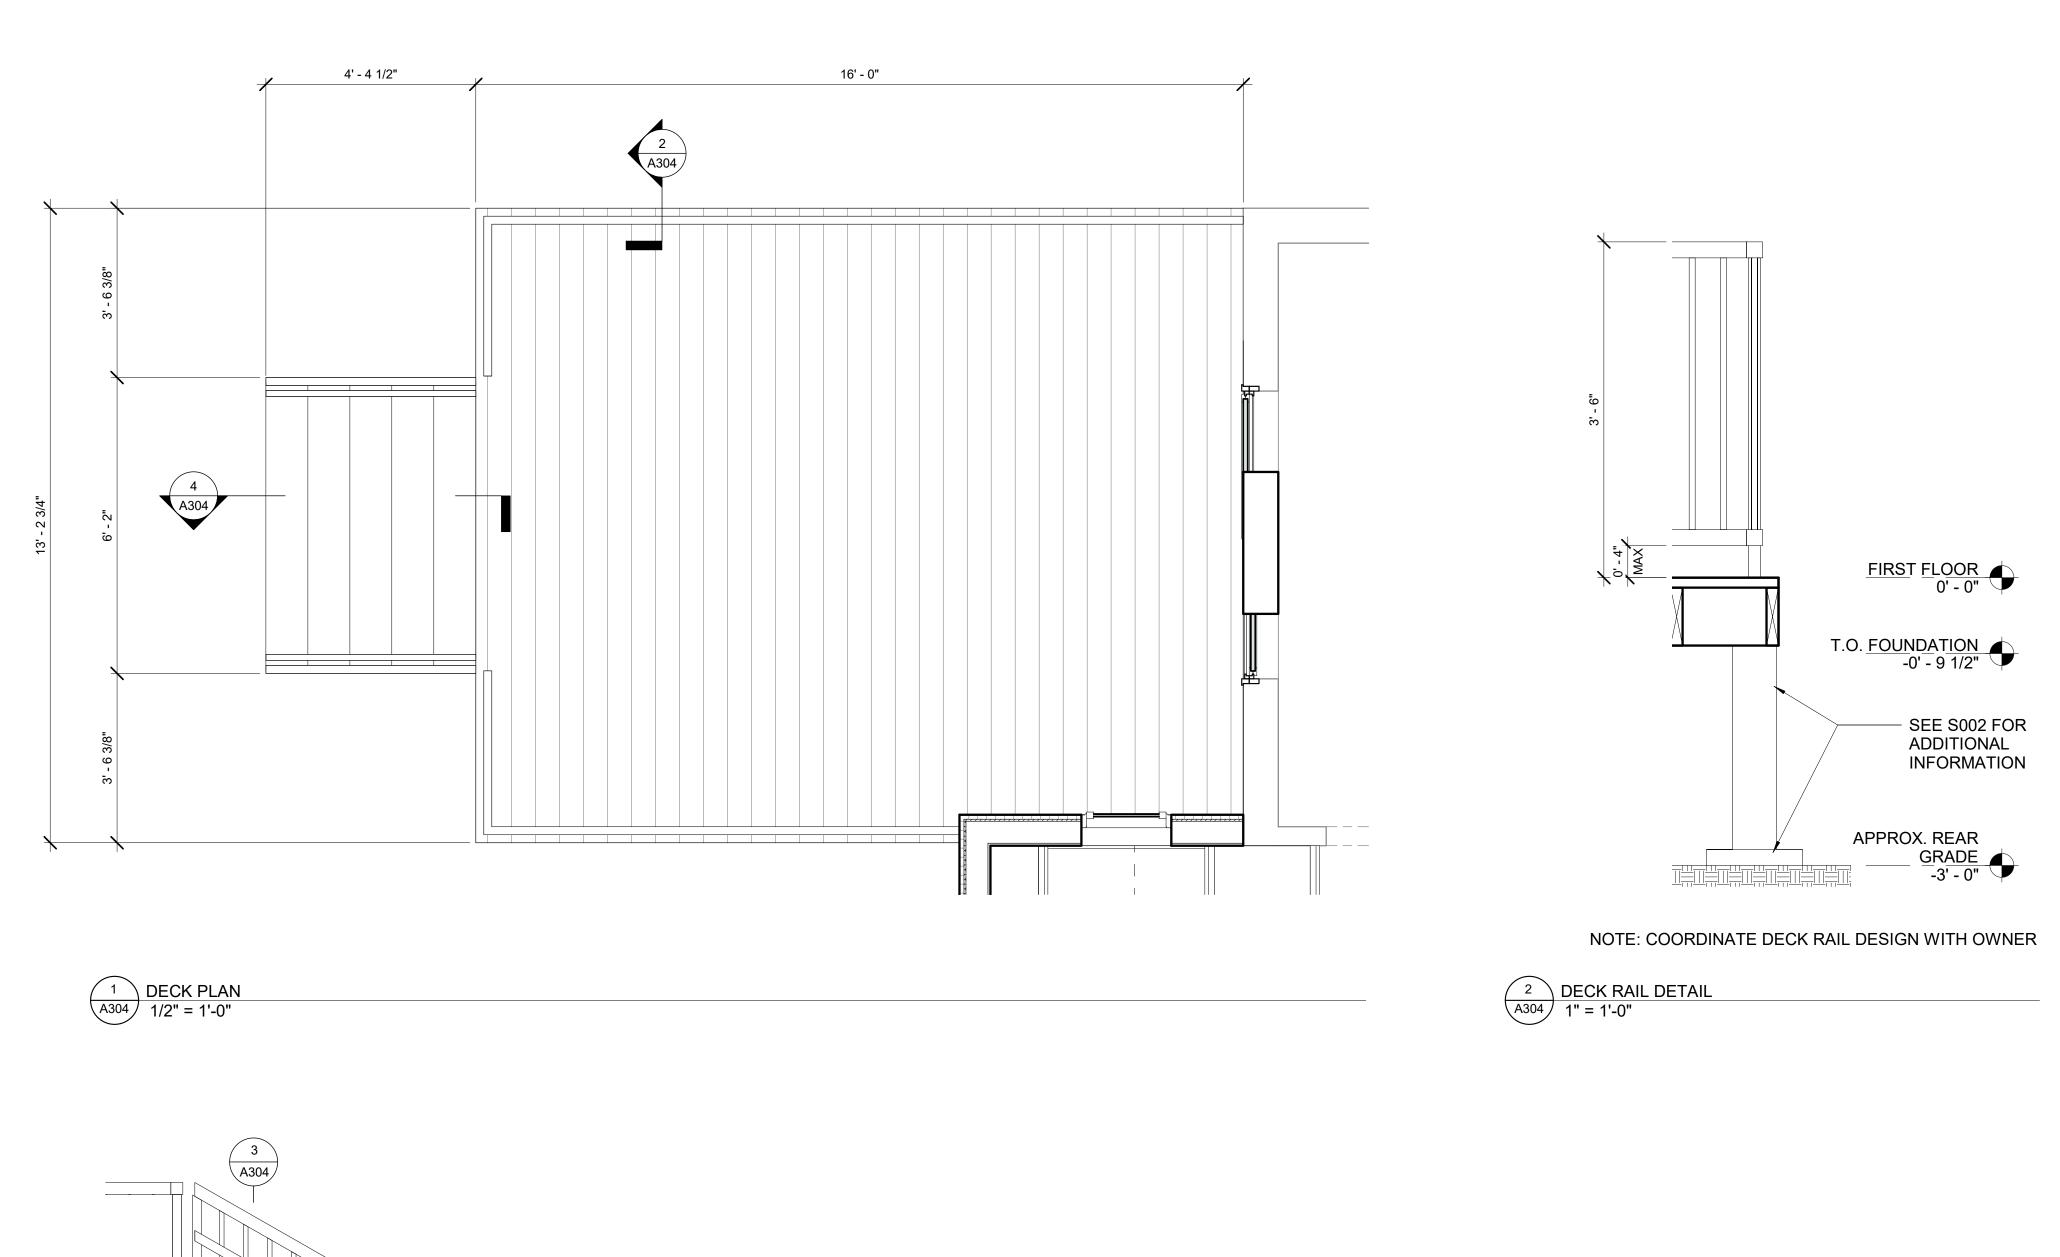
5/8" GWB CEILING -

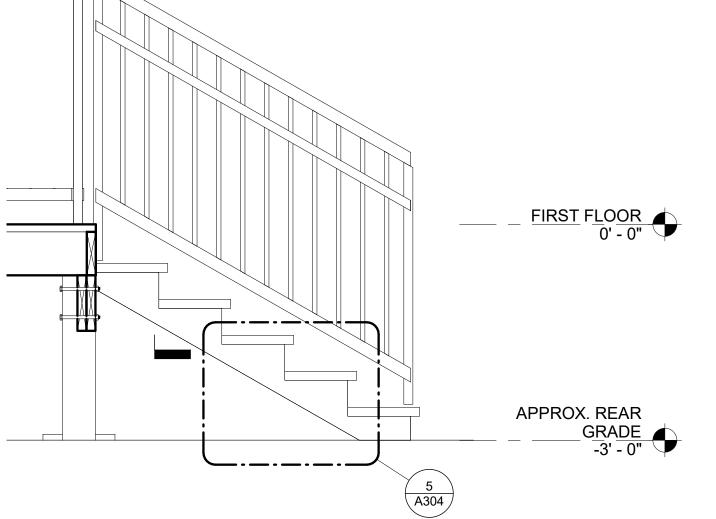
6 H1 BEAM DETAIL A303 1 1/2" = 1'-0"

(R49 MIN) -


5 GARAGE WALL LEDGER DETAIL A303 1 1/2" = 1'-0"








4 DECK STAIR SECTION A304 3/4" = 1'-0"

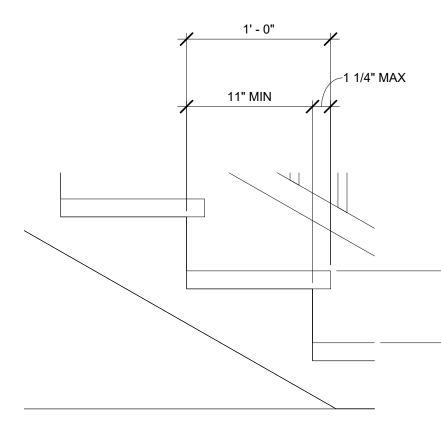

4" MIN 7" MAX

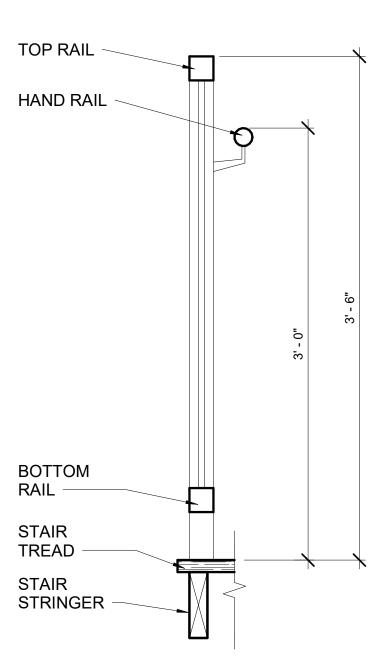
5 TYPICAL TREAD DETAIL A304 1 1/2" = 1'-0"



NOTE: COORDINATE DECK RAIL DESIGN WITH OWNER

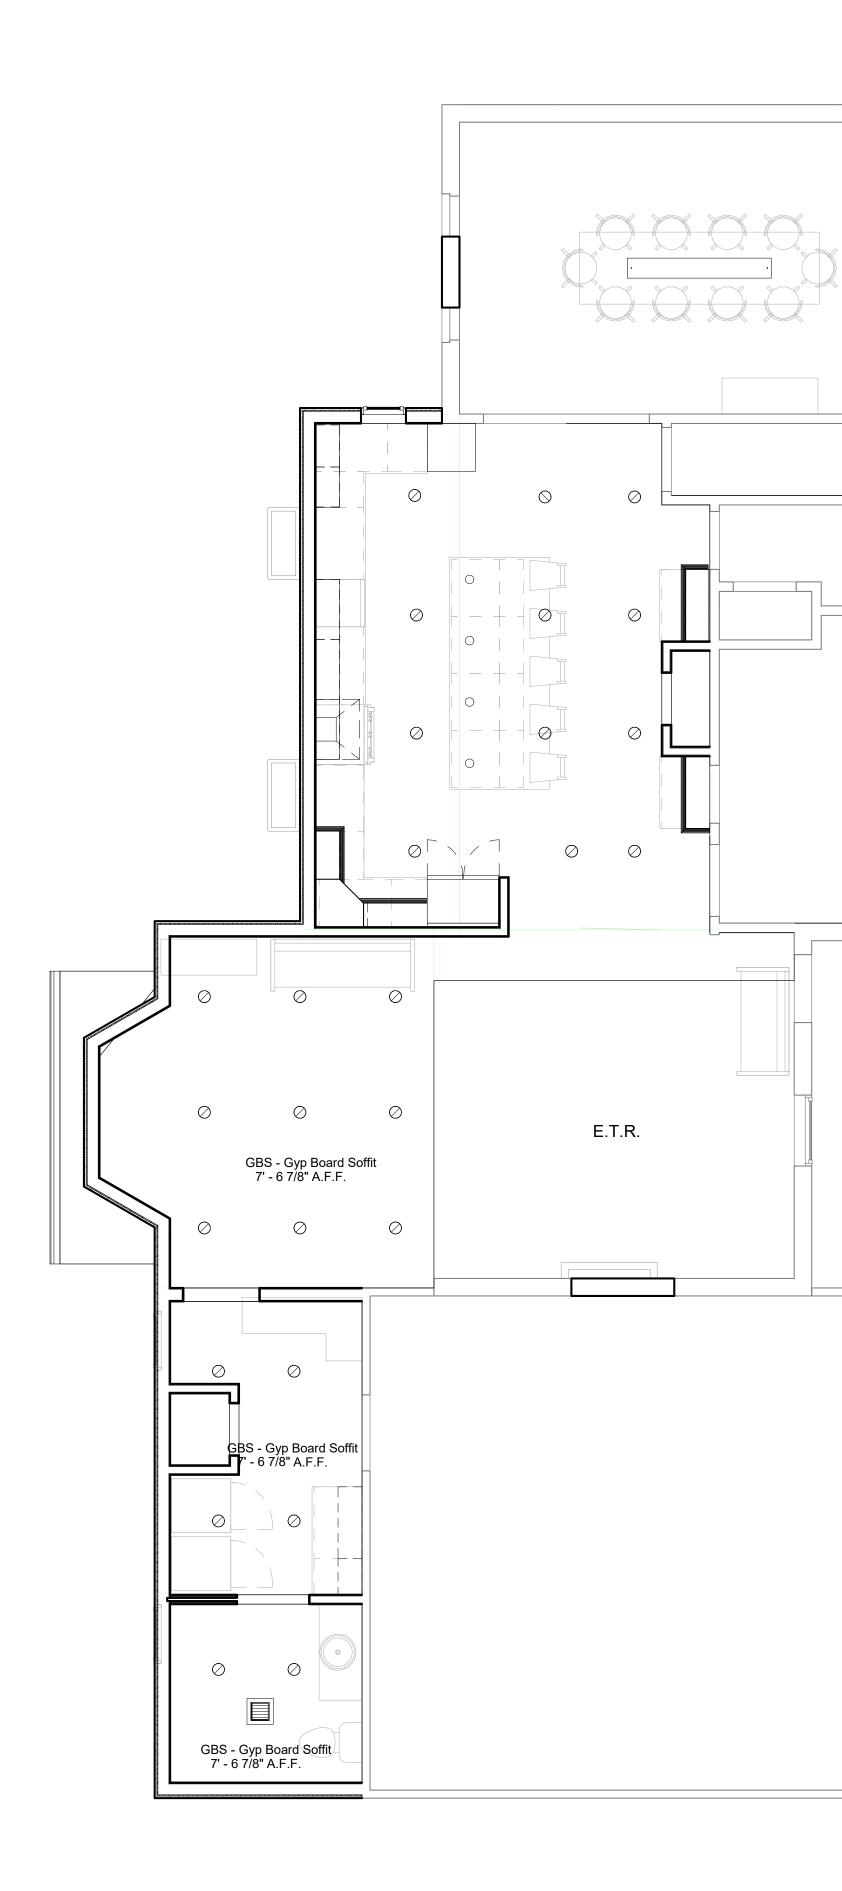3 STAIR RAILING DETAIL A304 1 1/2" = 1'-0"

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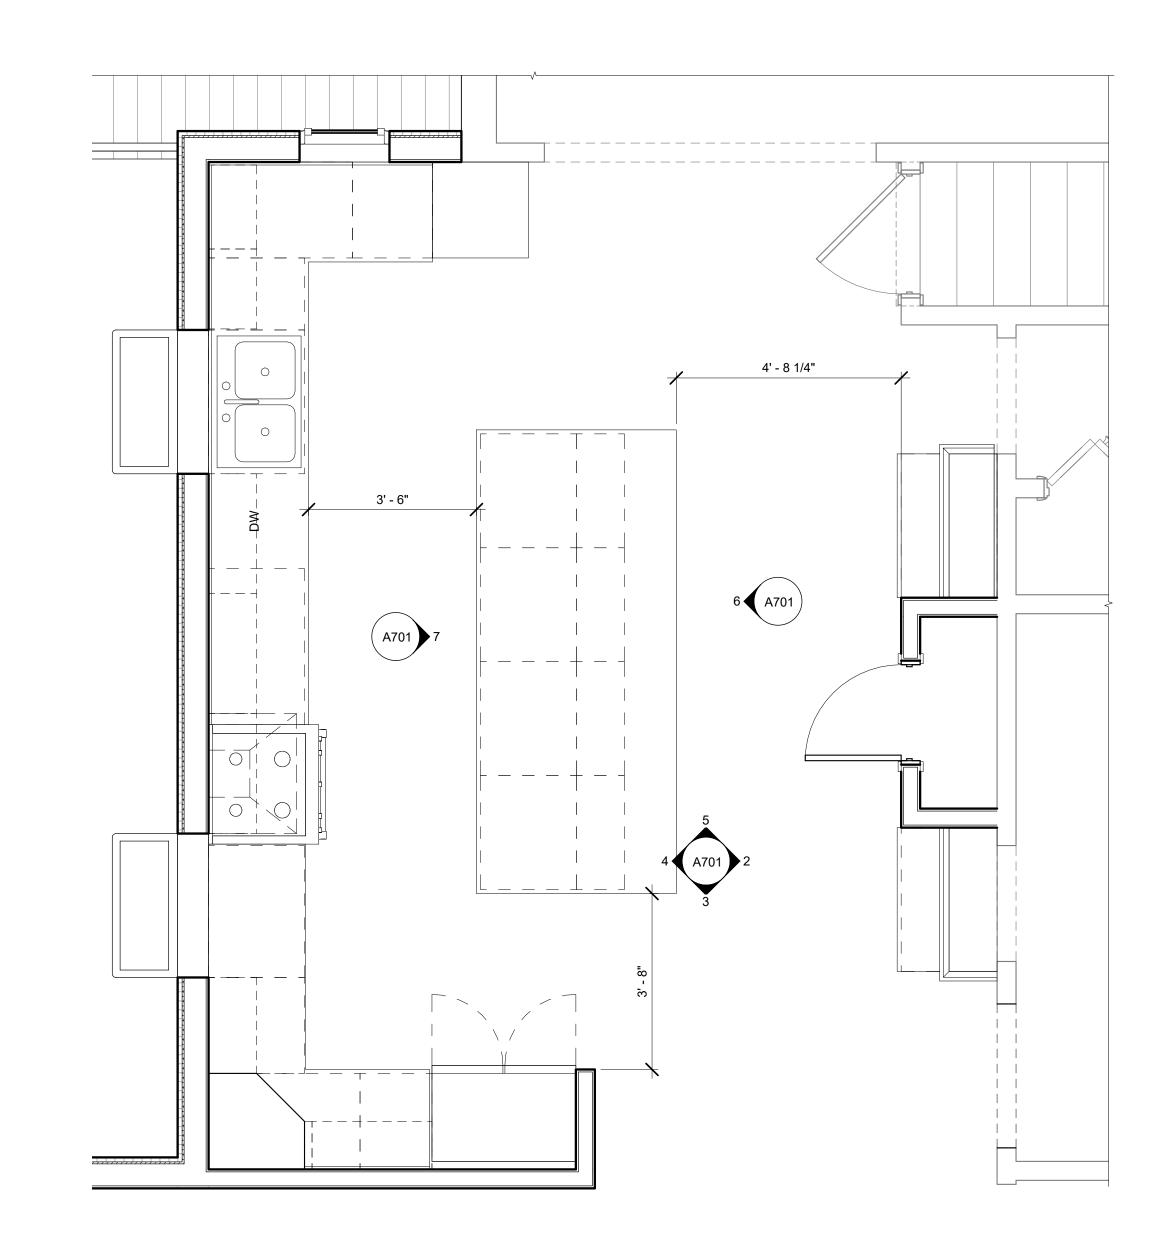
1 PROPOSED FIRST FLOOR REFLECTED CEILING PLAN A401 1/4" = 1'-0"

REFLECTED CEILING KEY

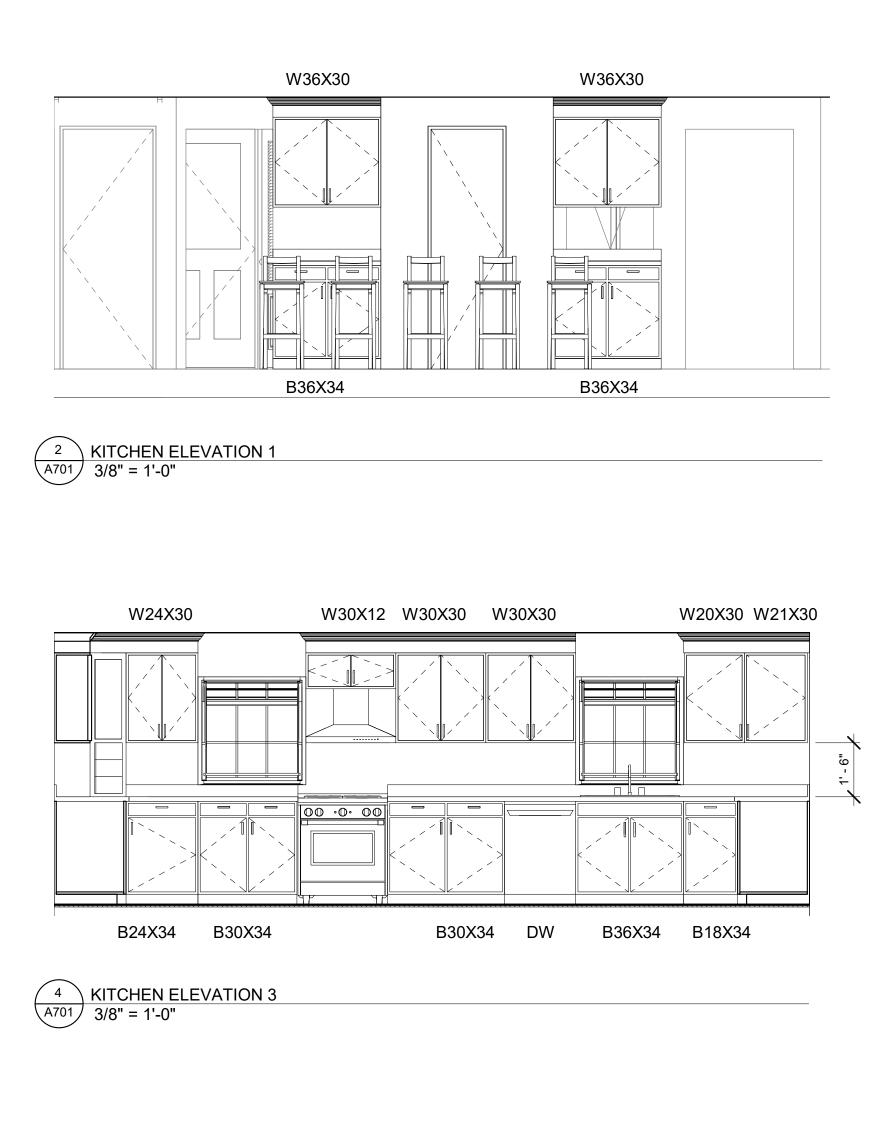
- ∅ = 6" RECESSED DOWN LIGHT
- = PENDENT LIGHT
- = EXHAUST FAN
- = LINEAR PENDENT

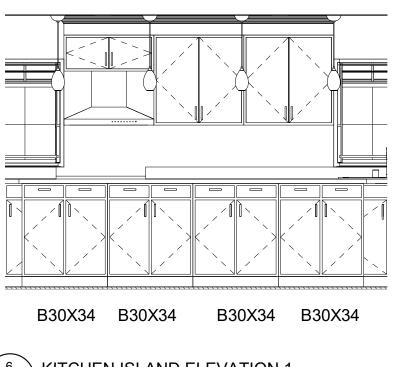
NOTE: COORDINATE LIGHTING WITH OWNER

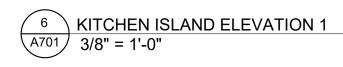
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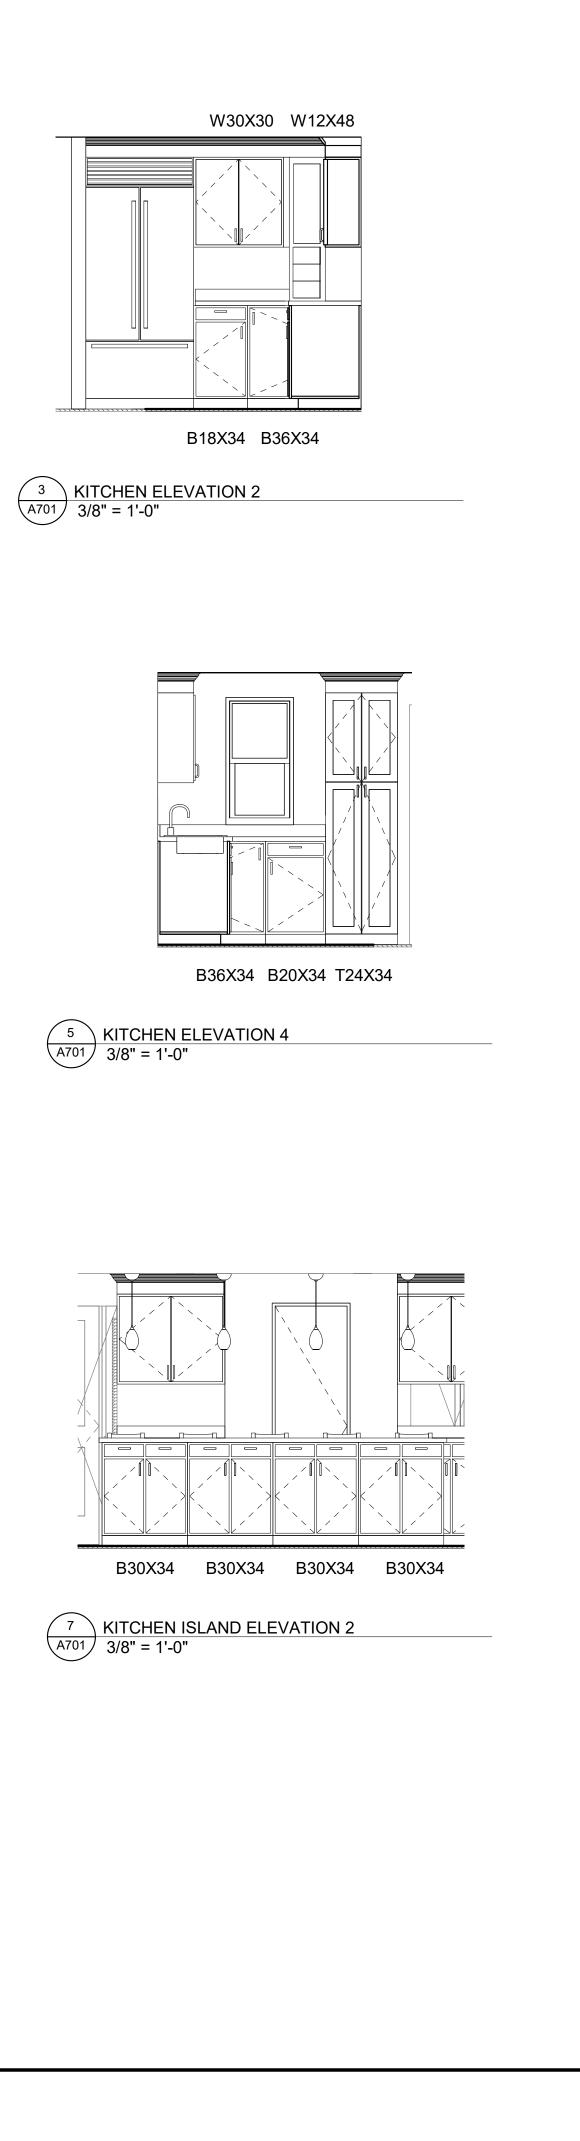















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FILE: W:\Projects\19-117 Hamann Residence\3 Drawings\20 07
DRAWING:
ENLARGED
PLANS AND
ELEVATIONS
SHEET NUMBER:
A701

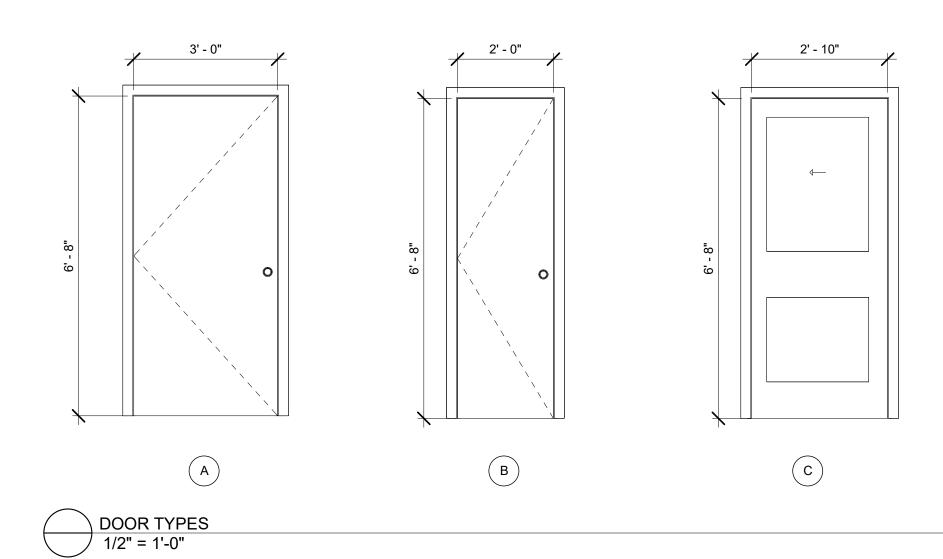

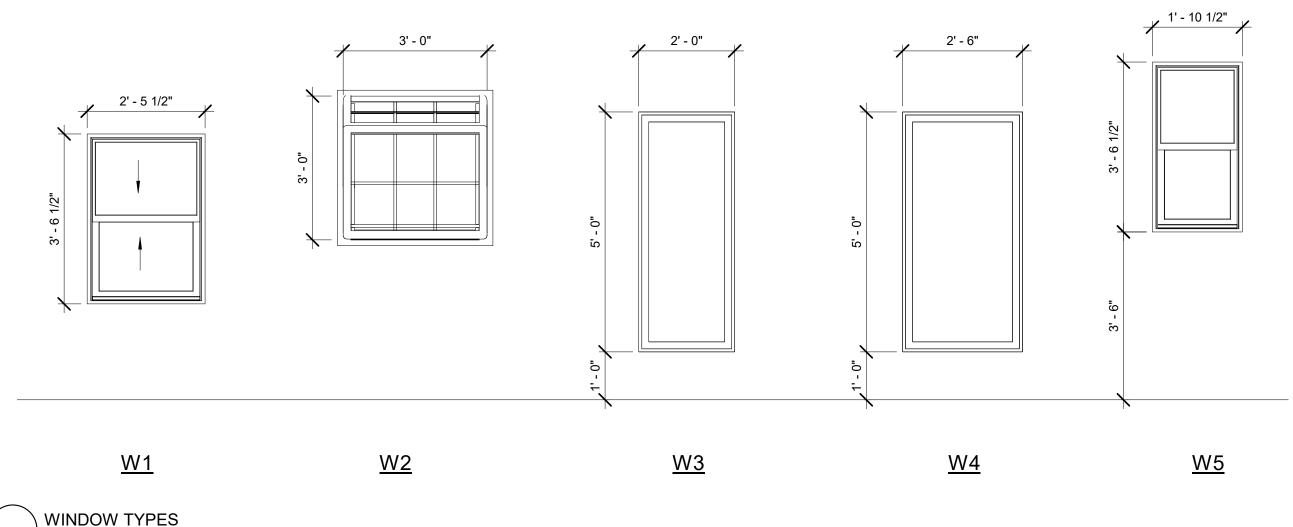

WINDOW TYPES 1/2" = 1'-0"

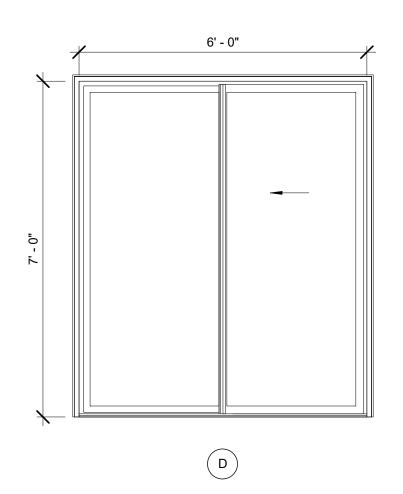

DOOR SCHEDULE					
MARK	ROOM NAME	WIDTH	HEIGHT	DOOR TYPE	REMARK
102	DINING ROOM	6' - 0"	7 '- 0"	D	
103	KITCHEN	2' - 0"	6' - 8"	В	
105	FAMILY ROOM	3' - 0"	6' - 8"	A	
106	GARAGE	3' - 0"	6' - 8"	A	
107	MUD ROOM	2' - 0"	6' - 8"	В	
108	BATHROOM	2' - 10"	6' - 8"	С	Pocket Door

	V	V	•

		WIND	OW SCH	IEDULE	
MARK	WINDOW TYPE	WIDTH	HEIGHT	QUANTITY	REMARK
W1	DOUBLE HUNG	2' - 5 1/2"	3' - 6 1/2"	3	
W2	GARDEN BOX	3' - 0"	3' - 0"	2	
W3	PICTURE	2' - 0"	5' - 0"	2	
W4	PICTURE	2' - 6"	5' - 0"	2	

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DRAWING ALTERATION	
THE FOLLOWING IS AN EXCERPT FROM	
THE NEW YORK EDUCATION LAW, ARTICLE 145, SECTION 7209, SPECIAL PROVISIONS.	
AND APPLIES TO THIS DRAWING. "IT IS A VIOLATION OF THIS LAW FOR ANY	
PERSON, UNLESS HE OR SHE IS ACTING UNDER THE DIRECTION OF A LICENSED	
PROFESSIONAL ARCHITECT, TO ALTER AN ITEM IN ANY WAY. IF AN ITEM BEARING THE SEAL OF AN ARCHITECT IS ALTERED	
THE ALTERING ENGINEER SHALL AFFIX TO THE ITEM HIS OR HER SEAL AND THE	
NOTATION "ALTERED BY" FOLLOWED BY HIS OR HER SIGNATURE AND THE DATE OF	
SUCH ALTERATION, AND A SPECIFIC DESCRIPTION OF THE ALTERATION".	
WOLFE ARCHITECTURE	
ALL RIGHTS RESERVED	
REVISIONS:	
MARK DESCRIPTION DATE	
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Wolfe Architecture	
3 N. Main St, Suite #2 Honeoye Falls, NY 14472	
Phone: (585) 582-6277 www.WolfeArchitecture.com	
SEAL	
SEAL	
OWNER:	
OWNER: MR & MRS HAMANN	
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Town of Pittsford

Department of Public Works 11 South Main Street Pittsford, New York 14534

Permit # B20-000092

Phone: 585-248-6250 FAX: 585-248-6262

DESIGN REVIEW AND HISTORIC PRESERVATION BOARD REFERRAL OF APPLICATION

Property Address: 355 East Street PITTSFORD, NY 14534 Tax ID Number: 178.16-2-23 Zoning District: RN Residential Neighborhood Owner: Sashittal, Hemant C Applicant: Sashittal, Hemant C

Application Type:

- Residential Design Review §185-205 (B)
- Commercial Design Review §185-205 (B)
- Signage
- §185-205 (C)
- Certificate of Áppropriateness §185-197
- Landmark Designation
- §185-195 (2)
- Informal Review

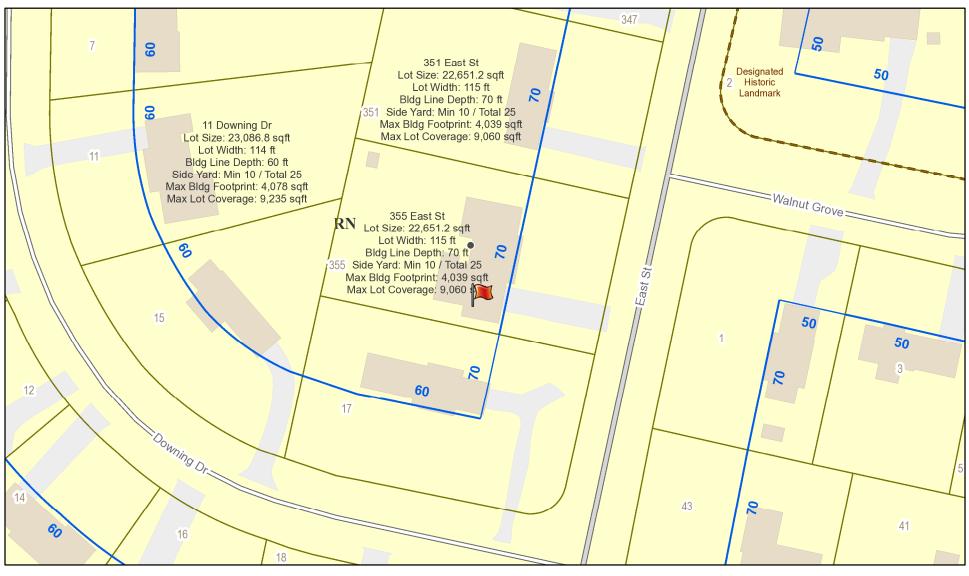
- Build to Line Adjustment §185-17 (B) (2)
- Building Height Above 30 Feet §185-17 (M)
- Corner Lot Orientation
- §185-17 (K) (3)
- Flag Lot Building Line Location §185-17 (L) (1) (c)
- Undeveloped Flag Lot Requirements
- §185-17 (L) (2)

Project Description: Applicant is requesting design review for the garage extension. The extension will be approximately 72 sq. ft. and will be located behind the 3rd bay of the garage.


Meeting Date: July 23, 2020



RN Residential Neighborhood Zoning




Printed July 16, 2020

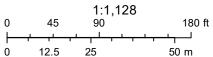

Town of Pittsford GIS

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- From: Hemant C. Sashittal 355 East Street, Pittsford NY 14534 Tel: 585 218 0692 Email: <u>sashi@sjfc.edu</u>
- To: Town of Pittsford Application for Building Permit

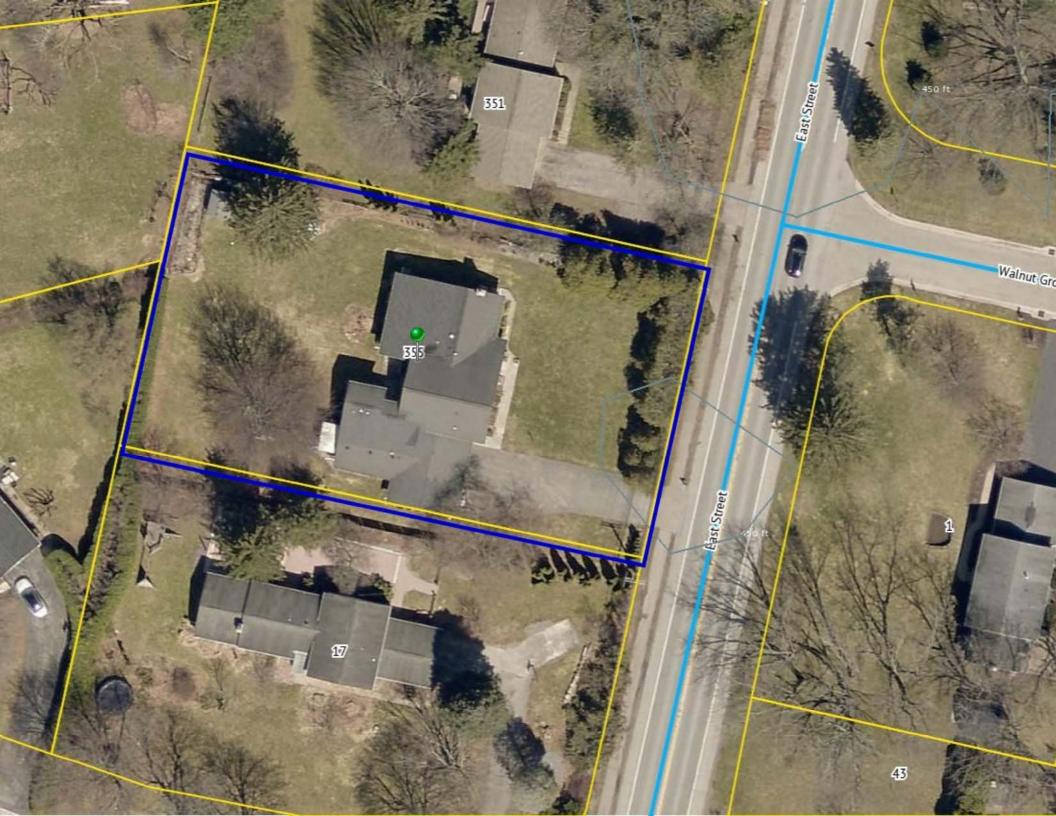Please consider this letter and the attached form as my application for a building permit.

I want to extend my garage; the best way to explain that is to show you the site map, and a few drawings.

Exhibit 1

Please see the hand drawn section. The extension will be *behind* the third car garage (to the left of the drawing, at the south end of the map). The garage wall is 9 feet broad; the extension will be 9 feet broad and will be flush with the south facing garage wall.

The drawing below shows the proposed footprint of the extension. There will be no outside access to the structure, it will be accessible from inside the garage. The floor will be poured concrete to integrate with current floor. The side walls will be framed by lumber, and covered with siding to integrate with siding outside (white color).

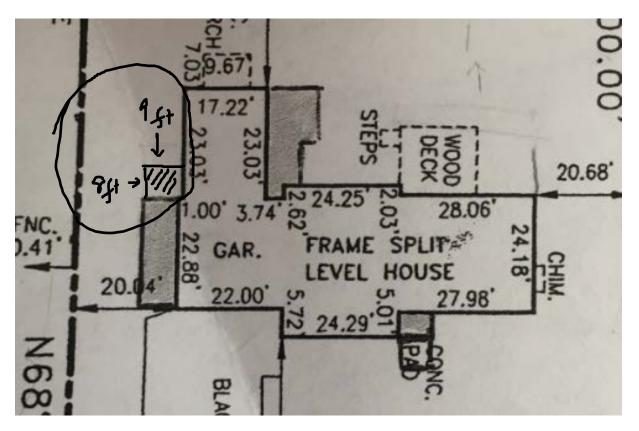


Exhibit 2

This is what it would look life if seen from the back.


The curved lines at the bottom and right are meant to signify gravel. The perimeter, shown later, is gravel, then two tiers of cinderblocks (placed partly in a trench along perimeter).



Exhibit 3: Back view


As can be seen, there is a privacy fence between our property and the immediate neighbor.

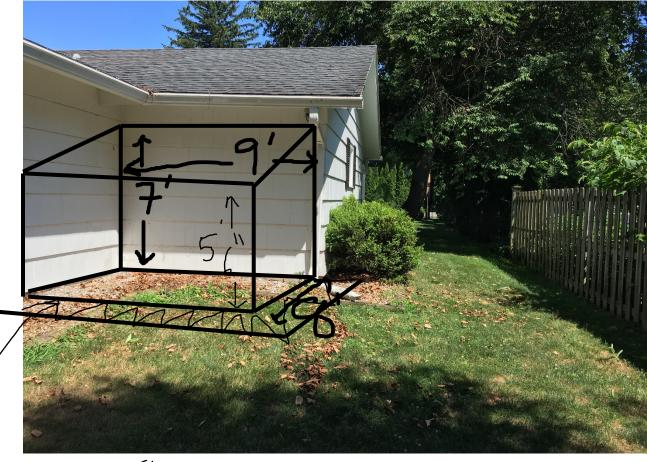I am showing the footprint below.



GRAVEL

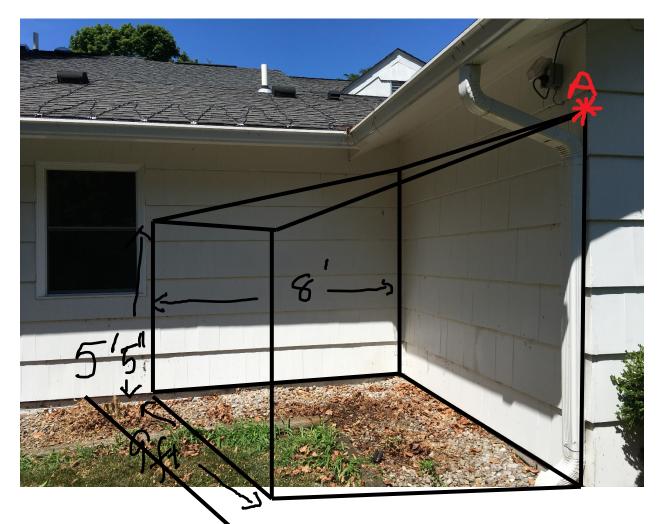Exhibit 4



Note:

The roof line is not integrated with that of the main structure

The footprint is 9 feet by 8 feet.

Roof touching the existing structure at point A, is 7 feet high.

The roof at the other end is 5 feet 6 inches.

There are no windows. The siding shingles removed from the walls will be reused on the side, others added to match the finish and paint (I have shingles in stock).

All fire codes will be followed.


Exhibit 5

Ground Prep.

At the perimeter, a trench will be dug, cinder blocks placed.

Inside the perimeter, earth will be excavated, graveled, and cement poured to be flush with the floor of the garage.

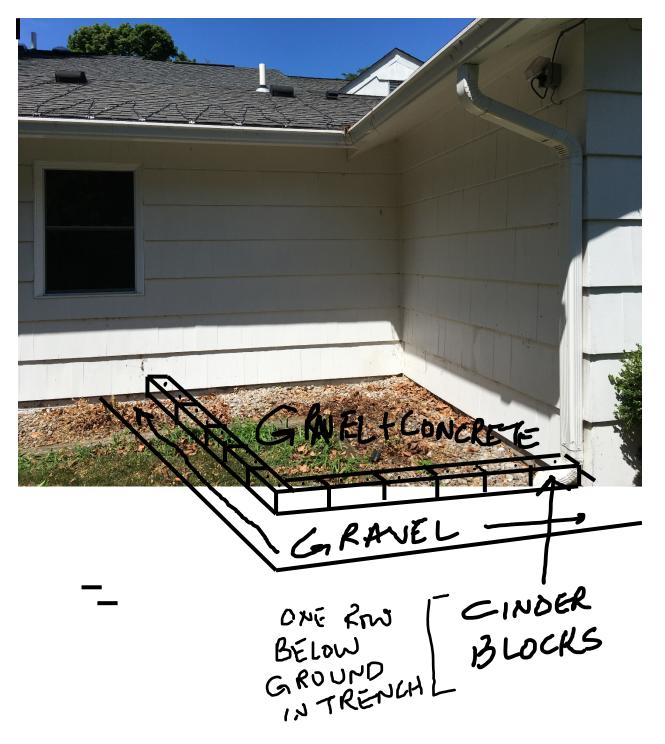The right end wall will be gone. A header (3 2x6s across on pillars of three 2X6s).











Town of Pittsford

Department of Public Works 11 South Main Street Pittsford, New York 14534

Permit # B20-000093

Phone: 585-248-6250 FAX: 585-248-6262

DESIGN REVIEW AND HISTORIC PRESERVATION BOARD REFERRAL OF APPLICATION

Property Address: 16 Ravenna PITTSFORD, NY 14534 Tax ID Number: 177.03-5-29 Zoning District: IZ Incentive Zoning Owner: Clover Street Development Applicant: Clover Street Development


Application Type:

- Residential Design Review §185-205 (B)
- Commercial Design Review §185-205 (B)
- Signage
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- Build to Line Adjustment §185-17 (B) (2)
- Building Height Above 30 Feet §185-17 (M)
- Corner Lot Orientation
- §185-17 (K) (3)
- Flag Lot Building Line Location §185-17 (L) (1) (c)
- Undeveloped Flag Lot Requirements §185-17 (L) (2)

Project Description: Applicant is requesting design review for the construction of a two story single family home. The home will be approximately 2800 sq. ft. and will be located in the Coventry Ridge Subdivision.

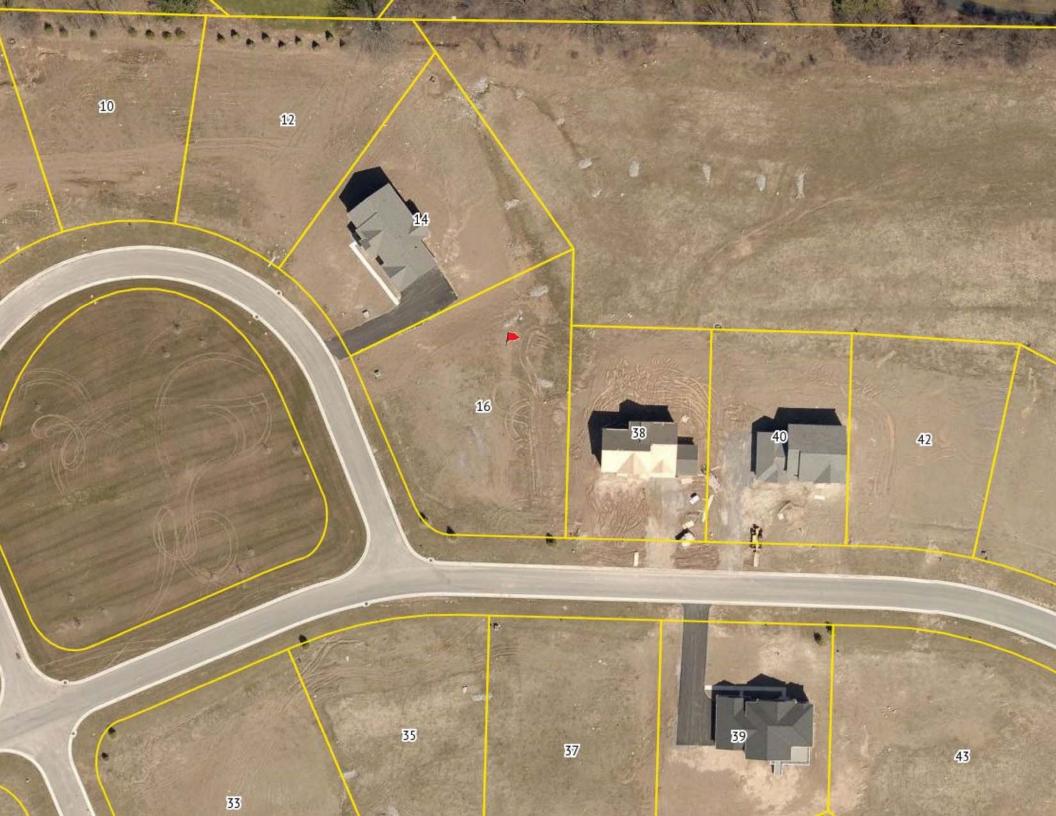
Meeting Date: July 23, 2020



RN Residential Neighborhood Zoning




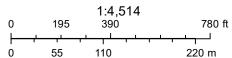Printed July 16, 2020



Town of Pittsford GIS

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GENERAL NOTES:

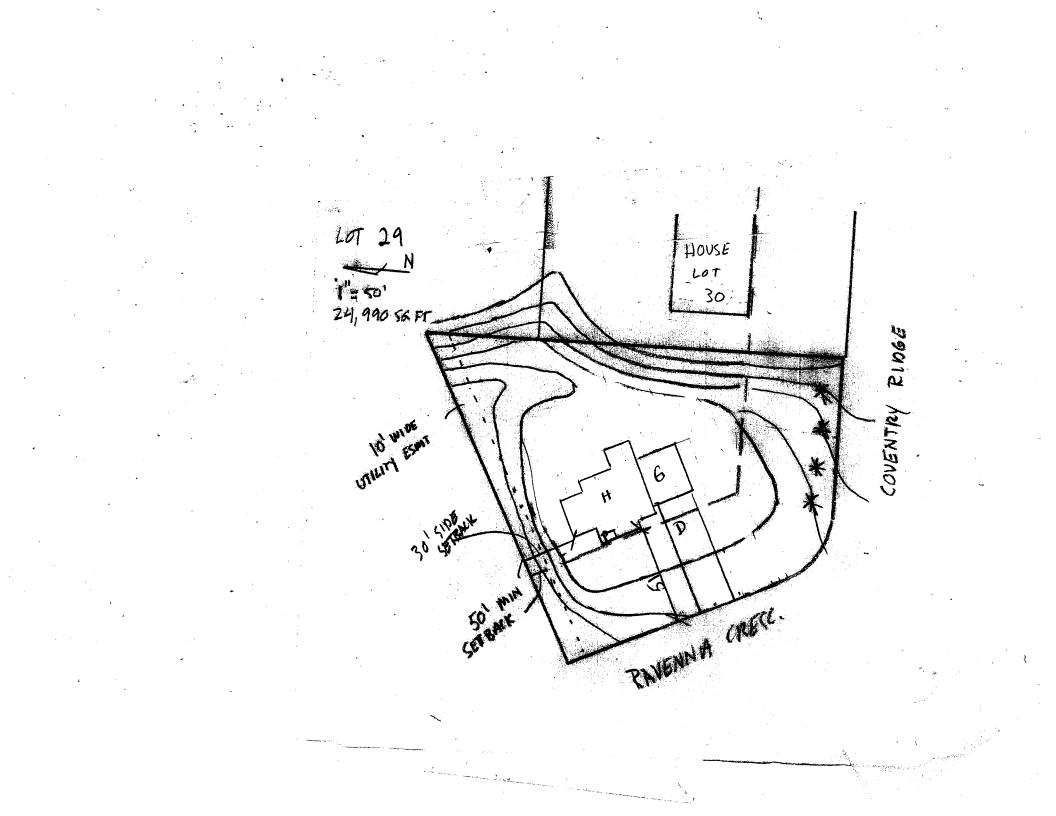THESE PLANS COMPLY WITH THE 2020 RESIDENTIAL CODE OF NEW YORK STATE (RCNYS) AND THE 2020 ENERGY CONSERVATION CONSTRUCTION CODE OF NEW YORK STATE (ECCCNYS).

COMPLIANCE METHOD: RESCHECK CERTIFICATE OR PRESCRIPTIVE

THESE PLANS ARE PROTECTED UNDER FEDERAL COPYRIGHT LAWS BY GREATER LIVING ARCHITECTURE. ANY UNAUTHORIZED REPRODUCTION OR MODIFICATION OF THESE PLANS IS A VIOLATION OF COPYRIGHT LAWS. CLIENT RIGHTS ARE LIMITED TO ONE-TIME USE FOR THE CONSTRUCTION OF THESE PLANS.

UNAUTHORIZED ALTERATIONS OR ADDITIONS TO THIS PLAN IS A VIOLATION OF THE NEW YORK STATE EDUCATION LAW, ARTICLE 145, SECTION 7209.

IT IS THE RESPONSIBILITY OF THE CONTRACTOR, BUILDER OR OWNER OF THIS BUILDING TO NOTIFY GREATER LIVING ARCHITECTURE OF ANY DEVIATION FROM THESE DRAWINGS.

CONTRACTOR TO BE RESPONSIBLE FOR COMPLIANCE WITH ALL APPLICABLE BUILDING/ ELECTRICAL/ MECHANICAL/ SANITARY AND ENERGY CONSERVATION CODES - STATE AND OR LOCAL.

CONTRACTOR TO BE RESPONSIBLE TO LOCAL BUILDING DEPARTMENT AND THAT DEPARTMENT'S INTERPRETATION OF THE BUILDING CODE SHOULD IT DIFFER FROM THESE PLANS.

CONTRACTOR TO BE RESPONSIBLE THAT BRAND NAME OF WINDOWS AND DOORS INSTALLED MEET NEW YORK STATE EXIT REQUIREMENTS.

IN THE EVENT OF ANY DISCREPANCIES BETWEEN PLANS, ELEVATIONS, AND/OR DETAILS, THE CONTRACTOR / SUB-CONTRACTOR SHALL CONTACT GREATER LIVING ARCHITECTURE BEFORE CONSTRUCTION FOR CLARIFICATION. IF GREATER LIVING ARCHITECTURE IS NOT CONTACTED, THE CONTRACTOR / SUB-CONTRACTOR WILL ASSUME FULL RESPONSIBILITY.

CONTRACTOR TO BE RESPONSIBLE FOR CONSTRUCTION MEANS, METHODS, TECHNIQUES, SEQUENCES, PROCEDURES AND SAFETY PRECATIONS/ PROGRAMS IN CONNECTION WITH THE WORK.

THESE DRAWINGS ARE NOT TO BE SCALED FOR DIMENSIONS - USE DIMENSIONS GIVEN. THE CONTRACTOR/ OWNER SHALL REQUEST LOCATION OF ALL UTILITIES PRIOR TO ANY DIGGING.

THE CONTRACTOR SHALL INDEMNIFY THE OWNER AND OWNER'S AGENTS THROUGH ADEQUATE INSURANCE COVERAGE AGAINST ANY CLAIMS ARISING FROM INJURIES DURING CONSTRUCTION, OR FAILURE TO MAINTAIN SAFE CONDITIONS ON THE SITE.

THESE DRAWINGS HAVE BEEN PREPARED FOR STUCTURAL REFERENCE ONLY. ELECTRICAL, MECHANICAL AND OTHER BUILDING SYSTEMS, IF REQUIRED, ARE TO BE DONE BY OTHERS

R806.2 MINIMUM VENT AREA. THE MINIMUM NET FREE VENTILATION AREA SHALL BE $\frac{1}{150}$ OF THE AREA OF THE VENTED SPACE. **ENERGY EFFICIENCY:**

R401.3 CERTIFICATE (MANDATORY) A PERMANENT CERTIFICATE COMPLETED BY OUR FIRM AND INCLUDED AS THE LAST PAGE OF THE RESCHECK SHALL BE POSTED ON A WALL IN THE SPACE WHERE THE FURNACE IS LOCATED, A UTILITY ROOM OR AN APPROVED LOCATION INSIDE THE BUILDING.

R402.2.4 ATTIC ACCESS SHALL BE INSULATED WITH THE SAME R- VALUE AS THE ATTIC, WEATHER STRIPPED & LATCHED R402.4 AIR LEAKAGE. THE BUILDING THERMAL ENVELOPE SHALL BE CONSTRUCTED TO LIMIT AIR LEAKAGE IN

ACCORDANCE WITH THE REQUIREMENTS OF SECTIONS R402.4.1 THROUGH R402.4.5.

R402.4.1 BUILDING THERMAL ENVELOPE . THE BUILDING THERMAL ENVELOPE SHALL COMPLY WITH SECTIONS R402.4.1.1 AND R402.4.1.2. THE SEALING METHODS BETWEEN DISSIMILAR MATERIALS SHALL ALLOW FOR DIFFERENTIAL EXPANSION AND CONTRACTION.

R402.4.1.1 INSTALLATION. THE COMPONENTS OF THE BUILDING THERMAL ENVELOPE AS LISTED IN TABLE 402.4.1.1 SHALL BE INSTALLED IN ACCORDANCE WITH THE MANUFACTURER'S INSTRUCTIONS AND THE CRITERIA LISTED IN TABLE R402.4.1.1, AS APPLICABLE TO THE METHOD OF CONSTRUCTION. WHERE REQUIRED BY THE CODE OFFICIAL, AN APPROVED THIRD PARTY SHALL INSPECT ALL COMPONENTS AND VERIFY COMPLIANCE. SEE PAGE N-2 FOR TABLE.

R402.4.1.2 TESTING.THE BUILDING OR DWELLING UNIT SHALL BE TESTED AND VERIFIED AS HAVING AN AIR LEAKAGE RATE NOT EXCEEDING THREE AIR CHANGES PER HOUR. TESTING SHALL BE CONDUCTED IN ACCORDANCE WITH RESNET/ICC 380, ASTM E779, OR ASTM E1827 AND REPORTED AT A PRESSURE OF 0.2 INCH w.g. (50 PASCALS). TESTING SHALL BE PERFORMED AT ANY TIME AFTER CREATION OF ALL PENETRATIONS OF THE BUILDING THERMAL ENVELOPE. DURING TESTING:

1. EXTERIOR WINDOWS AND DOORS, FIREPLACES AND STOVE DOORS SHALL BE CLOSED, BUT NOT SEALED, BEYOND THE INTENDED WEATHERSTRIPPING OR OTHER INFILTRATION CONTROL MEASURES.

- 2. DAMPERS INCLUDING EXHAUST, INTAKE, MAKEUP AIR, BACKDRAFT AND FLUE DAMPERS SHALL BE CLOSED, BUT NOT SEALED BEYOND INTENDED INFILTRATION CONTROL MEASURES.
- 3. INTERIOR DOORS, IF INSTALLED AT THE TIME OF THE TEST, SHALL BE OPEN.
- 4. EXTERIOR DOORS FOR CONTINUOUS VENTILATION SYSTEMS AND HEAT RECOVERY VENTILATORS SHALL BE CLOSED AND SEALED.
- 5. HEATING AND COOLING SYSTEMS, IF INSTALLED AT THE TIME OF REST, SHALL BE TURNED OFF.
- 6. SUPPLY AND RETURN REGISTERS, IF INSTALLED AT THE TIME OF REST, SHALL BE FULLY OPEN.

R402.4.5 RECESSED LIGHTING. RECESSED LUMINAIRES INSTALLED IN THE BUILDING THERMAL ENVELOPE SHALL BE SEALED TO LIMIT AIR LEAKAGE BETWEEN CONDITIONED AND UNCONDITIONED SPACES. RECESSED LUMINARIES SHALL BE IC-RATED AND LABELED AS HAVING AN AIR LEAKAGE RATE OF NOT GREATER THAN 2.0 c.f.m (0.944 L/s) WHEN TESTED IN ACCORDANCE WITH ASTM E283 AT A PRESSURE DIFFERENTIAL OF 1.57 p.s.f. (75 Pa.). RECESSED LUMINARIES SHALL BE SEALED WITH A GASKET OR CAULKED BETWEEN THE HOUSING AND THE INTERIOR WALL OR CEILIN COVERING.

R402.5 MAXIMUM FENESTRATION U-FACTOR & SHGC (MANDATORY) THE AREA-WEIGHTED AVERAGE MAXIMUM FENESTRATION U-FACTOR PERMITTED USING TRADEOFFS FROM SECT. R402.1.5 OR R405 SHALL BE .48 IN CLIMATE ZONES 4 & 5 AND 0.40 IN CLIMATE ZONES 6-8 FOR VERTICAL FENESTRATION, & 0.75 IN CLIMATE ZONES 4-8 FOR SKYLIGHTS. THE AREA-WEIGHTED AVERAGE MAXIMUM FENESTRATION SHGC PERMITTED USING TRADEOFFS FROM SECTION R405 IN CLIMATE ZONES 1-3 SHALL BE 0.50

R403.1.1 PROGRAMMABLE THERMOSTAT. THE THERMOSTAT CONTROLLING THE PRIMARY HEATING AND COOLING SYSTEM SHALL BE CAPABLE OF CONTROLLING THE HEATING AND COOLING SYSTEM ON A DAILY SCHEDULE TO MAINTAIN DIFFERENT TEMPERATURE SET POINTS AT DIFFERENT TIMES OF THE DAY. THIS THERMOSTAT SHALL INC. THE CAPABILITY TO SET BACK OR TEMP. OPERATE THE SYSTEM TO MAINTAIN ZONE TEMPERATURES DOWN TO 55 DEG OR UP TO 85 DEG.. THE THERMOSTAT SHALL INITIALLY BE PROGRAMMED BY THE MANF. WITH A HEATING TEMP. SET POINT NO HIGHER THAN 70 DEG. & A COOLING TEMP. SET POINT NO LOWER THAN 78 DEG.

R403.1.2 HEAT PUMP SUPPLEMENTARY HEAT (MANDATORY). HEAT PUMPS HAVING SUPPLEMENTARY ELECTRIC-RESISTANCE HEAT SHALL HAVE CONTROLS THAT, EXCEPT DURING DEFROST, PREVENT SUPPLEMENTAL HEAT OPERATION WHEN THE HEAT PUMP COMPRESSOR CAN MEET THE HEATING LOAD.

R403.3.1 INSULATION (PRESCIPTIVE) SUPPLY & RETURN DUCTS IN ATTICS SHALL BE INSULATED TO A MIN. OF R-6. WITH THE EXCEPTION OF DUCTS OR PORTIONS THEREOF LOCATED COMPLETELY INSIDE THE BUILDING THERMAL ENVELOPE

R403.3.2 SEALING (MANDATORY). DUCTS, AIR HANDLERS AND FILTER BOXES SHALL BE SEALED. JOINTS AND SEAMS SHALL COMPLY WITH EITHER THE MECHANICAL CODE OF NEW YORK STATE (MCONYS) OR RCNYS, AS APPLICABLE.

R403.3.3 DUCT TESTING (MANDATORY). DUCTS SHALL BE PRESSURE TESTED TO DETERMINE AIR LEAKAGE BY ONE OF HE FOLLOWING METHODS:

1. ROUGH IN TEST: TOTAL LEAKAGE SHALL BE MEASURED WITH A PRESSURE DIFFERENTIAL OF 0.1 INCH w.g. (25 Pg) ACCROSS THE SYSTEM, INCLUDING THE MANUFACTURER'S AIR HANDLER ENCLOSURE IF INSTALLED AT THE TIME OF THE TEST. ALL REGISTERS SHALL BE TAPED OR OTHERWISE SEALED DURING THE TEST.

2. POSTCONSTUCTION TEST: TOTAL LEAKAGE SHALL BE MEASURED WITH A PRESSURE DIFFERENTIAL OF 0.1 INCH w.g. (25 Pg) ACCROSS THE SYSTEM, INCLUDING THE MANUFACTURER'S AIR HANDLER ENCLOSURE. ALL REGISTERS SHALL BE TAPED OR OTHERWISE SEALED DURING THE TEST.

R403.3.5 BUILDING CAVITIES (MANDATORY). BUILDING FRAMING CAVITIES SHALL NOT BE USED AS DUCTS OR PLENUMS.

R403.4 MECHANICAL SYSTEM PIPING CAPABLE OF CARRYING FLUIDS ABOVE 105 DEGREES F OR BELOW 55 DEGREES F SHALL BE INSULATED TO A MINIMUM OF R-3.

R403.5.1 HEATED WATER CIRCULATION & TEMPERATURE MAINTENANCE SYSTEMS (MANDATORY). WOOD ROOF TRUSSES ARE TO BE METAL PLATE CONNECTED WOOD CHORD, WOOD WEB TRUSSES. TRUSS LAYOUT IS HEATED WATER CIRCULATION SYSTEMS SHALL BE IN ACCORDANCE WITH SECTION R403.5.1.1. HEAT TRACE TEMPERATURE SCHEMATIC ONLY. TRUSS MANUFACTURER SHALL BE RESPONSIBLE FOR THE DESIGN (INCLUDING SPACING) OF ALL TRUSSES. MAINTENANCE SYSTEMS SHALL BE IN ACCORDANCE WITH SECTION R403.5.1.2. AUTOMATIC CONTROLS, TEMPERATURE TRUSSES TO BE DESIGNED AND CERTIFIED BY AN ENGINEER LICENSED IN THE GOVERNING STATE. SENSORS & PUMPS SHALL BE ACCESSIBLE. MANUAL CONTROLS SHALL BE READILY ACCESSIBLE.

APPLIED TO THE FOLLOWING:

1. PIPING 3/4" AND LARGER IN NOMINAL DIAMETER. 2. PIPING SERVING MORE THAN ONE DWELLING UNIT.

- 3. PIPING LOCATED OUTSIDE THE CONDITIONED SPACE. 4. PIPING FROM THE WATER HEATER TO A DISTRIBUTION MANIFOLD.
- 5. PIPING LOCATED UNDER A FLOOR SLAB.

6. BURIED IN PIPING. 7. SUPPLY & RETURN PIPING IN RECIRCULATION SYSTEMS OTHER THAN DEMAND RECIRCULATION SYSTEMS

R403.6 MECHANICAL VENTILATION (MANDATORY). THE BUILDING SHALL BE PROVIDED WITH VENTILATION THAT MEETS THE REQUIREMENTS OF THE IRC OR IMC, AS APPLICABLE, OR WITH OTHER APPROVED MEANS OF VENTILATION. OUTDOOR AIR INTAKES AND EXHAUSTS SHALL HAVE AUTOMATIC OR GRAVITY DAMPERS THAT CLOSE WHEN THE VENTILATION SYSTEM IS NOT OPERATING

R403.6.1 WHOLE-HOUSE MECHANICAL VENTILATION SYSTEM FAN EFFICACY. MECHANICAL VENTILATION SYSTEM FANS SHALL MEET THE EFFICACY REQUIREMENTS OF TABLE R403.6.1.

R403.7 EQUIPMENT SIZING & EFFICIENCY RATING (MANDATORY). HEATING & COOLING EQUIPMENT SHALL BE SIZED IN ACCORDANCE W/ ACCA MANUAL S BASED ON BUILDING LOADS CALCULATED IN ACCORDANCE W/ ACCA MANUAL J OR OTHER APPROVED HEATING & COOLING CALCULATION METHODOLOGIES. NEW OR REPLACEMENT HEATING & COOLING EQUIPMENT SHALL HAVE A EFFICIENCY RATING EQUAL TO OR GREATER THAN THE MINIMUM REQUIRED BY FEDERAL LAW FOR THE GEOGRAPHIC LOCATION WHERE THE EQUIPMENT IS INSTALLED.

R404.1 LIGHTING EQUIPMENT (MANDATORY) A MINIMUM OF 90% OF THE LAMPS IN PERMANENTLY INSTALLED LIGHTING FIXTURES SHALL BE HIGH-EFFICACY LAMPS.

SITE WORK

THESE PLANS HAVE BEEN PREPARED ACCORDING TO THE 2020 RCNYS AND IECC REQUIREMENTS TO SUIT A GENERAL RANGE OF CONDITIONS THAT MAY BE AFFECTED BY A PARTICULAR BUILDING SITE OR BUILDER/ OWNER CONTRACTUAL AGREEMENT. CONTRACTOR TO BE RESPONSIBLE TO ADAPT THESE PLANS TO SUIT THE NEEDS OF THE BUILDING ON SITE AS REQUIRED, PROVIDED THAT SUCH ADJUSTMENTS DO NOT VIOLATE THE CODE OR ALTER THE STRUCTURAL INTEGRITY OF THE BUILDING.

CONTRACTOR/ OWNER SHALL PERFORM EXPLORATORY EXCAVATION TO DETERMINE ACTUAL FIELD CONDITIONS AND NOTIFY THIS OFFICE OF THE FINDINGS TO ALLOW FOR DESIGN CHANGES PRIOR TO ACTUAL CONSTRUCTION. IT SHALL BE THE RESPONSIBILITY OF THE CONTRACTOR/ OWNER TO DEVELOP THE NECESSARY FOUNDATION SOIL TO SUSTAIN THE LOAD DESIGNS OF 2500 P.S.F. AND TO HIRE, IF NECESSARY, A SOILS ENGINEER TO INSPECT AND VERIFY SOIL CONDITIONS PRIOR TO POURING OF FOUNDATIONS.

THE CONTRACTOR, BUILDER OR OWNER SHALL NOTIFY GREATER LIVING ARCHITECTURE OF ANY UNUSUAL SITE CONDITIONS WHICH MAY EFFECT THE FOUNDATION, DRAINAGE OR STRUCTURAL MEMBERS INCLUDING REQUIREMENTS FOR ADDITIONAL DEPTH OF FOOTINGS, UNSTABLE SOIL CONDITIONS AND HIGH GROUND WATER TABLE.

NO SITE INSPECTIONS ARE TO BE MADE BY THIS OFFICE. CONTRACTOR TO BE RESPONSIBLE FOR MATERIALS AND WORKMANSHIP. SUBSTITUTIONS FOR MATERIALS SPECIFIED TO BE MADE WITH THE PERMISSION OF THE LOCAL BUILDING DEPT.

R403.5.3 HOT WATER PIPE INSULATION (PRESCRIPTIVE). INSULATION FOR HOT WATER PIPE WITH A MIN. R-3 SHALL BE

FOUNDATION

ALL FOOTINGS TO REST ON (ORIGINAL) UNDISTURBED SOIL, ASSUMED MINIMUM SOIL BEARING PRESSURE TO BE 2500 P.S.F. CONTRACTOR TO BE RESPONSIBLE FOR ALL SUBGRADE CONDITIONS.

BASEMENT/CELLAR WALLS AND FOOTING DESIGNS ASSUMED PARTIALLY SATURATED SOIL CONDITIONS TO TO THE FULL WALL DEPTH. SHOULD SATURATED CONDITIONS BE ENCOUNTERED, OUR OFFICE SHOULD BE CONTACTED FOR REVIEW AND POSSIBLE REVISIONS TO THE PLANS.

CONTRACTOR ASSUMES FULL RESPONSIBILITY FOR PROVIDING PROPER DRAINAGE SHOULD INTERMITTENT SPRINGS OR PERCHED WATER BE ENCOUNTERED.

POSITIVE DRAINAGE SHALL BE PROVIDED SO THAT FINISHED GRADE SLOPES AWAY FROM PERIMETER WALLS & FOOTINGS.

CONTINUOUS 4" DIAM. PERFORATED DRAIN PIPE SHALL BE PLACED ALONG THE PERIMETER OF THE BASEMENT WALLS WHICH DRAINS TO THE SUMP PUMP. A MINIMUM OF 6" GRANULAR BASE SHALL BE PLACED OVER THE DRAIN TILE AND MINIMUM OF 2" UNDER THE TILE.

CONCRETE AND MASONRY FOUNDATION WALLS SHALL BE CONSTRUCTED AS SET FORTH AS PER TABLES ON N-2.

FIREPLACES

DIRECT VENT GAS FIREPLACE UNIT TO BE SELECTED BY OWNER AND INSTALLED ACCORDING TO MANUFACTURER'S SPECIFICATIONS.

NEW WOOD-BURNING FIREPLACES SHALL HAVE TIGHT-FITTING FLUE DAMPERS OR DOORS, AND OUTDOOR COMBUSTION AIR. WHERE USING TIGHT-FITTING DOORS ON FACTORY BUILT FIREPLACES LISTED AND LABELED IN ACCORDANCE WITH UL 127, THE DOORS SHALL BE TESTED AND LISTED FOR THE FIREPLACE. WHERE USING TIGHT FITTING DOORS ON MASONRY FIREPLACES, THE DOORS SHALL BE LISTED AND LABELED IN ACCORDANCE WITH UL 907.

FRAMING :

PROVIDE ALL TEMPORARY BRACING AND SHORING TO AVOID EXCESSIVE STRESSES AND HOLD STRUCTURAL ELEMENTS IN PLACE DURING CONSTRUCTION.

UNDER ALL CONCEALED WOOD BEARING POSTS, PROVIDE ADDITIONAL WOOD BLOCKING AS REQUIRED IN FLOOR JOIST SPACE UNDER POST, TO ENSURE SOLID BEARING FROM HEADER OR BEAM DOWN TO FOUNDATION WALL.

ALL WINDOWS AND DOORS ARE TO BE FRAMED WITH MINIMUM 3-2X6 OR 2-2X8 HEADER UNLESS NOTED OTHERWISE. BUILDER ASSUMES FULL RESPONSIBILITY FOR MAINTAINING THE STRUCTURAL INTEGRITY OF JOISTS, BEAMS OR STUDS WHICH ARE NOTCHED OR DRILLED TO ACCOMMODATE MECHANICAL OR ELECTRICAL LINES. SEE DETAILS ON PG. N-1 FOR

ALLOWABLE DRILLING LOCATION ON BEAMS AND JOISTS. ALL STRESS GRADE LUMBER CONSTRUCTION SHALL COMPLY WITH AITC TIMBER CONSTRUCTION STANDARDS LATEST EDITION. EACH PIECE SHALL BEAR THE STAMP OF A GRADING RULES AGENCY, APPROVED BY THE AMERICAN LUMBER STANDARDS COMMITTEE . GRADE LOSS RESULTING FROM EFFECTS OF WEATHER, HANDLING, STORAGE, RESAWING, OR DIVIDING LENGTHS WILL BE CAUSE FOR REJECTION.

STAIRWAY GUARD REQUIREMENTS:

GUARDS SHALL BE LOCATED ALONG AN OPEN SIDED WALKING SURFACE, THAT ARE LOCATED MORE THAN 30 INCHES MEASURED VERTICALLY TO THE FLOOR OR GRADE BELOW AT ANY POINT WITHIN 36 INCHES HORIZONTALLY TO THE EDGE OF THE OPEN SIDE. AS PER SECTION 312.1.1 OF THE 2020 RCNYS.

REQUIRED GUARDS SHALL NOT BE LESS THAN 36 INCHES IN HEIGHT AS MEASURED VERTICALLY ABOVE THE ADJACENT WALKING SURFACE. AS PER SECTION 312.1.2 OF THE 2020 RCNYS.

GUARDS ON THE OPEN SIDES OF STAIRS SHALL HAVE A HEIGHT NOT LESS THAN 34 INCHES. AS PER SECTION 312.1.2 OF THE 2020 RCNYS.

WHERE THE TOP OF THE GUARD SERVES AS A HANDRAIL ON THE OPEN SIDES OF THE STAIRS, THE TOP OF THE GUARD SHALL BE NO LOESS THAN 34 INCHES AND NOT MORE THAN 38 INCHES. AS PER SECTION 312.1.2 OF THE 2020 RCNYS.

REQUIRED GUARDS SHALL NOT HAVE OPENINGS FROM THE WALKING SURFACE TO THE REQUIRED GUARD HEIGHT THAT ALLOW THE PASSAGE OF A SPHERE 4 INCHES IN DIAMETER. AS PER SECTION 312.1.3 OF THE 2020 RCNYS.

GARAGE FIREPROOFING

3/4 HOUR FIRE RESISTANCE RATING REQUIRED BETWEEN HOUSE & GARAGE CAN BE ACHIEVED WITH ONE LAYER 5/8" TYPE X DRYWALL ON GARAGE SIDE AND ONE LAYER 1/2" TYPE X DRYWALL ON THE HOUSE SIDE.

IF HORIZONTAL CONSTRUCTION IS USED TO SEPARATE THE GARAGE FROM LIVING AREA OR BONUS AREAS ABOVE, THEN ONE LAYER OF 5/8" TYPE X DRYWALL ON THE CEILING IS REQUIRED. WHERE THE HORIZONTAL CONSTRUCTION IS A FLOOR-CEILING ASSEMBLY, THE STRUCTURE SUPPORTING THE SEPARATION SHALL ALSO PROTECTED BY 5/8" TYPE X DRYWALL.

SPEC HOUSE LOT 29 COVENTRY RIDGE PITTSFORD, NY COVENTRY RIDGE BUILDING CORP. PLAN 2800 / PROJECT 15420

SHEET INDEX

C-1 COVER SHEET

1/6 FRONT & LEFT ELEVATIONS

2/6 RIGHT & REAR ELEVATIONS

3/6 BASEMENT & FOUNDATION PLAN

4/6 FIRST FLOOR PLAN

5/6 SECOND FLOOR & ROOF PLAN

6/6 SECTIONS

N-1 DETAILS

N-2 REINFORCING NOTES

STRUCTURAL MATERIAL SPECIFICATIONS:

ASTM A-36, Fy = 36 ksi

ASTM A-615, Fy = 40 ksi

UNLESS NOTED OTHERWISE

CDX, PANEL INDEX

ASTM C270, TYPE S

Fc = 2000 PSI ASTM C476

ASTM A307, Fy - 33 KSI

Fb = 2600

Fc[⊥] = 750

40 P.S.F.

30 P.S.F.

15 P.S.F.

40 P.S.F.

10 P.S.F.

CATEGORY B

42 INCHES

1 DEGREE

FIRM - 2008

ROOF DÉSIGN

SEVERE

2500 P.S.F. AT MINIMUM

115 MPH, EXPOSURE B

SLIGHT TO MODERATE

REQUIRED 24" INSIDE OF

R802.11, BASED UPON SPECIFIC

EXTERIOR WALL LINE

NONE TO SLIGHT

42" BELOW FINISHED GRADE

Fv = 285E x 10⁶ - 1.9

ASTM A-185, 6 x 6 - 10/10 W.W.M.

WITH A MIN. FIBER STRESS OF 850 P.S.I.

ASTM C90, GRADE N-1, Fm = 1350 PSI

ALL STUCTURAL MEMBERS, JOISTS, RAFTERS, ETC

HEM-FIR, SOUTHERN PINE OR SPRUCE PINE-FIR)

TO BE #2 GRADE LUMBER (DOUGLAS FIR-LARCH,

Fc = 2500 PSI MIN. (FOOTINGS, BASEMENT SLAB)

Fc = 3500 PSI MIN. (GARAGE SLAB, PORCH SLAB, &

POURED FOUNDATION WALLS)

STRUCTURAL STEEL REINFORCED STEEL WIRE MESH LUMBER

PLYWOOD LVL, PSL, LSL

MASONRY MORTAR GROUT CONCRETE

BOLTS

DESIGN CRITERIA: (FOR GREATER ROCHESTER AREA & ADJACENT COUNTIES)

LOCAL JURISDICTION DESIGN CRITERIA MAY VARY AND SHALL BE STRICTLY ADHERED TO **1ST FLOOR** LIVING AREA LIVE LOAD 2ND FLOOR LIVING AREA LIVE LOAD 1ST & 2ND FLOOR DEAD LOAD GROUND SNOW LOAD ROOF DEAD LOAD ALLOWABLE SOIL BEARING WIND SPEED SEISMIC DESIGN WEATHERING FROST LINE DEPTH TERMITE DAMAGE

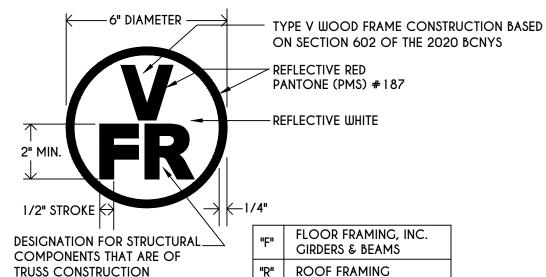
DECAY DAMAGE WINTER DESIGN TEMPERATURE ICE SHEILD UNDERLAYMENT

FLOOD HAZARD ROOF TIE DOWN REQUIREMENTS

TRUSS IDENTIFICATION:

IDENTIFICATION OF FLOOR AND ROOF TRUSS CONSTRUCTION SHALL BE PROVIDED BY SIGN OR SYMBOL & SHALL BE AFFIXED TO THE EXTERIOR WALL OF THE RESIDENTIAL

WITH TRUSS TYPE CONSTRUCTION, PRE-ENGINEERED WOOD CONSTRUCTION AND / OR TIMBER CONSTRUCTION.



"FR" | FLOOR & ROOF FRAMING

3033 BRIGHTON-HENRIETTA TOWNLINE RD ROCHESTER, NY 14623 CALL:(585) 272-9170 FAX: (585) 292-1262 www.greaterliving.com

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DATE	ΒY	DESCRIPTION
L		

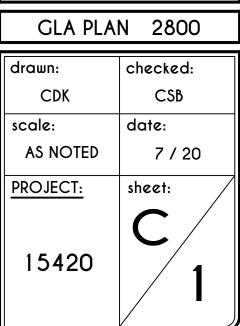
CLIENT/LOCATION:

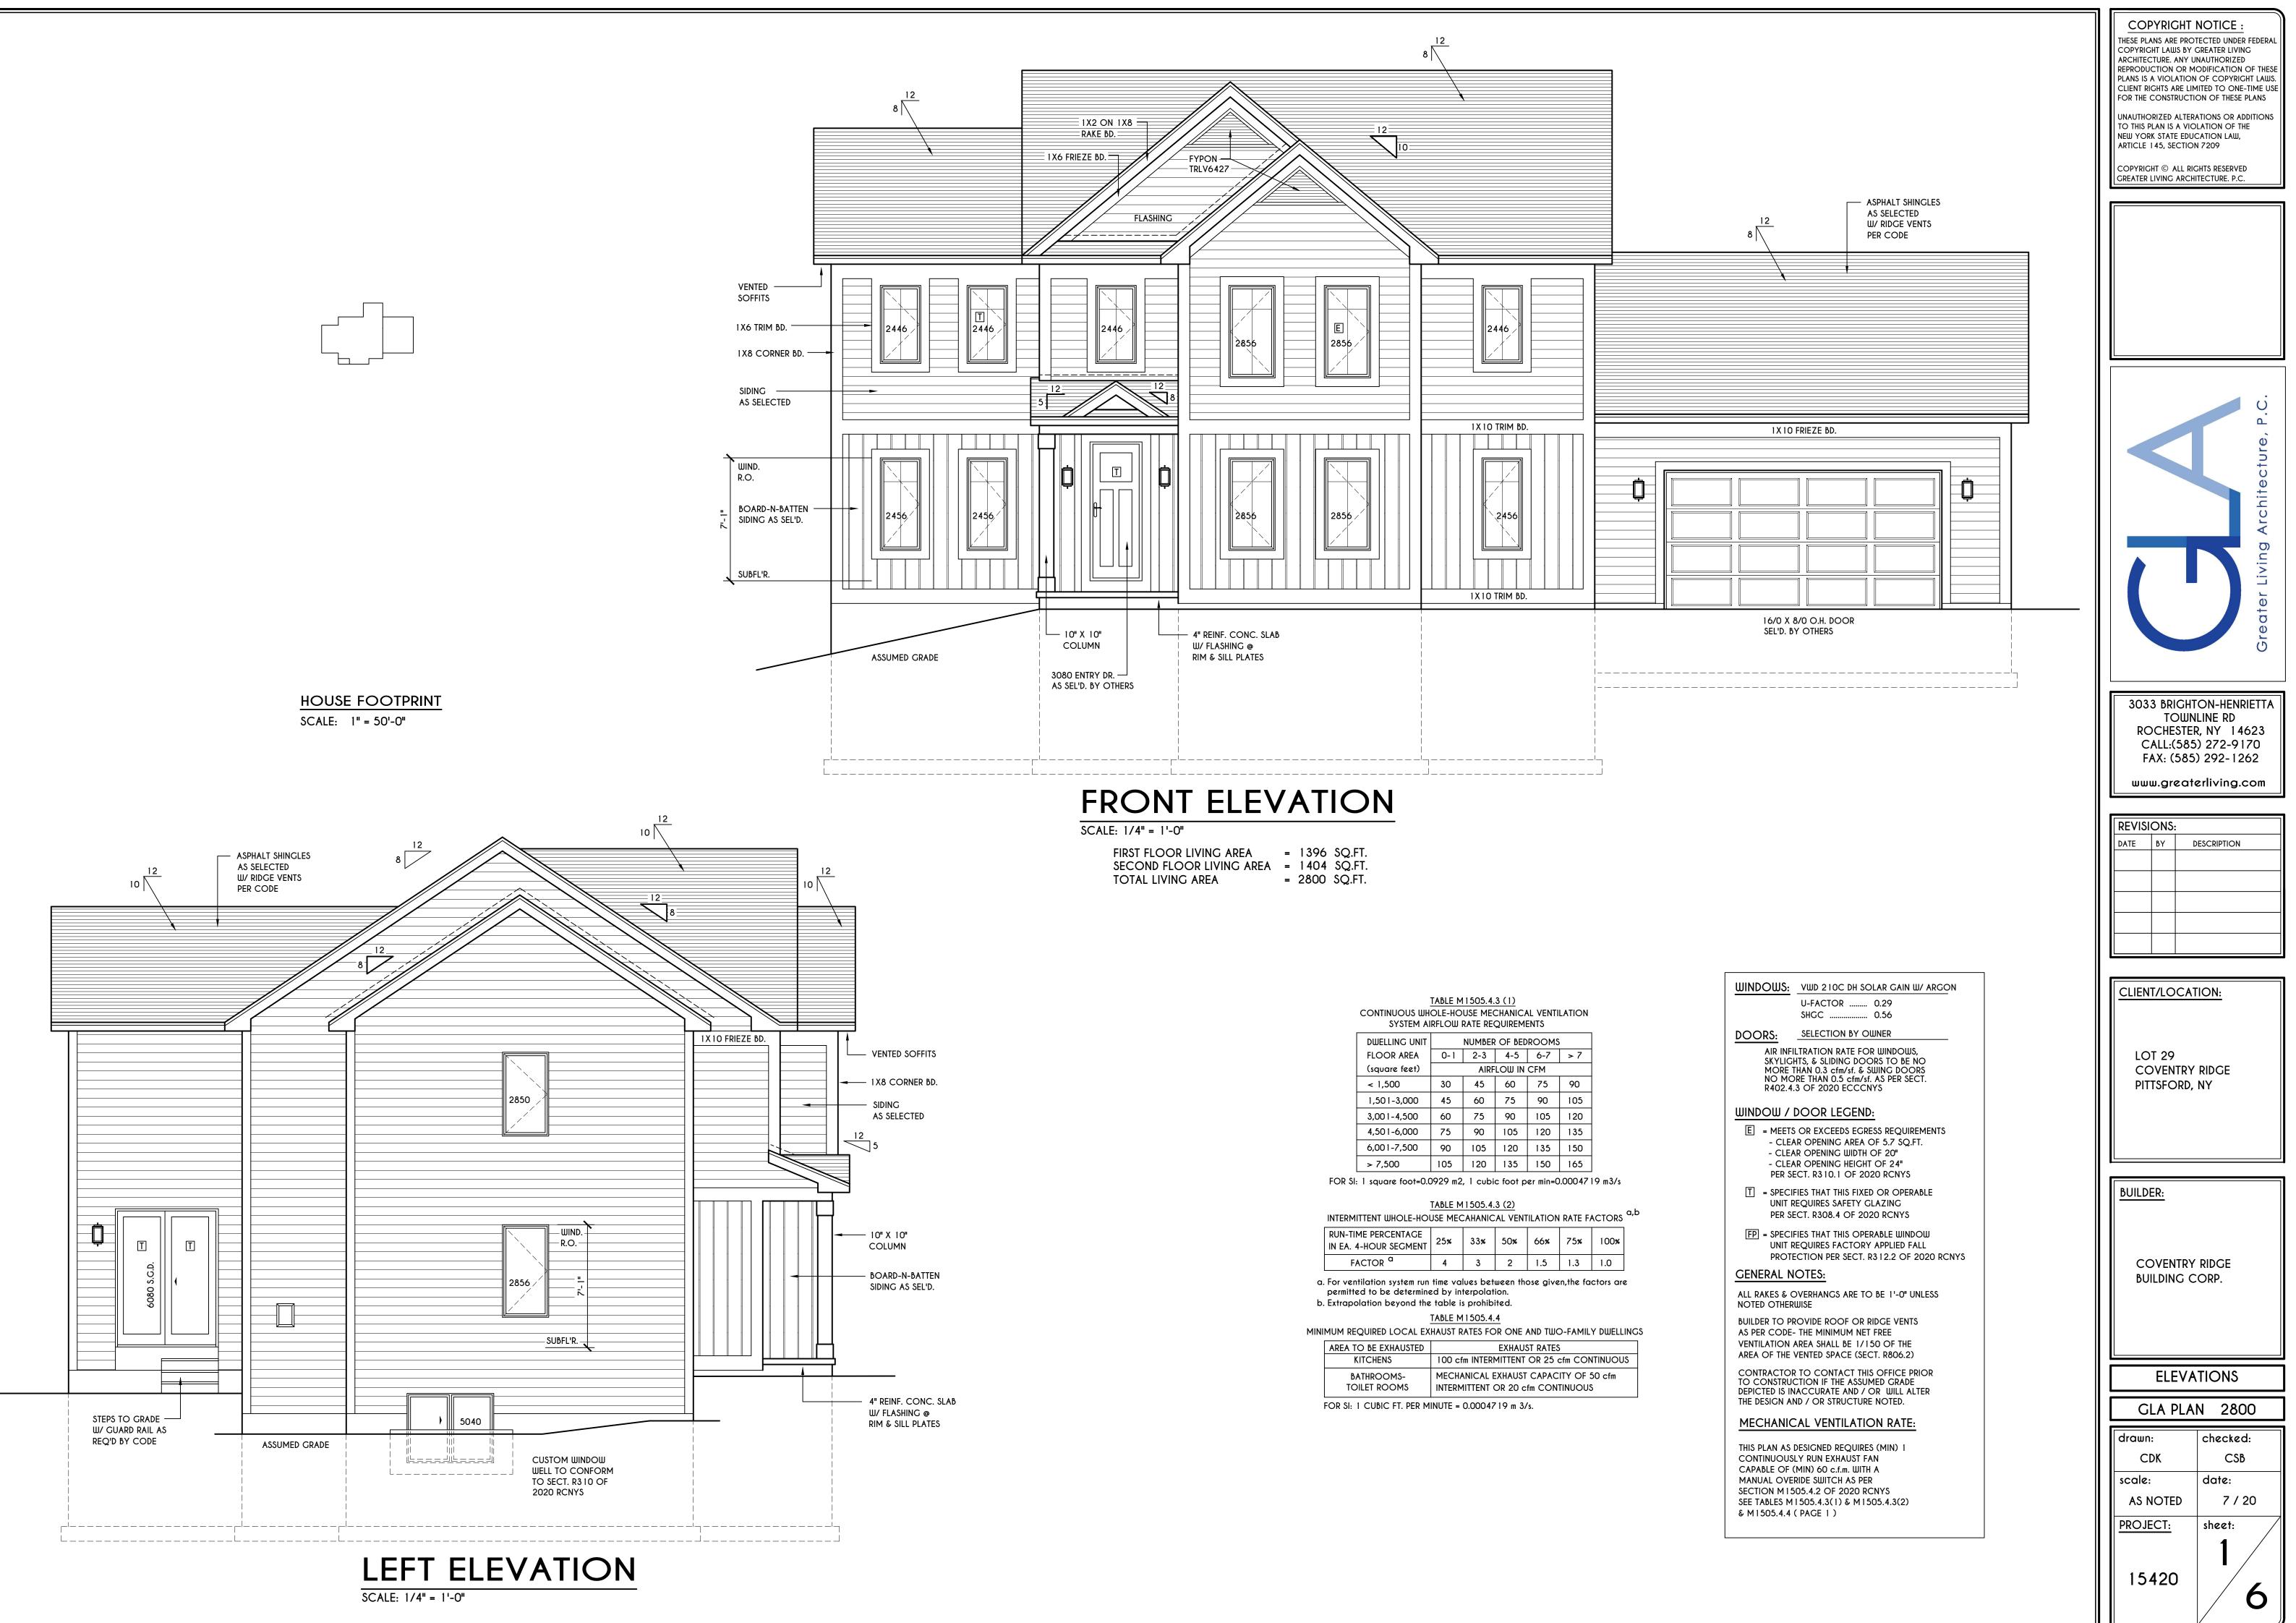
LOT 29 COVENTRY RIDGE PITTSFORD, NY

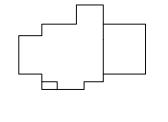
BUILDER:

COVENTRY RIDGE BUILDING CORP.

COVER PAGE







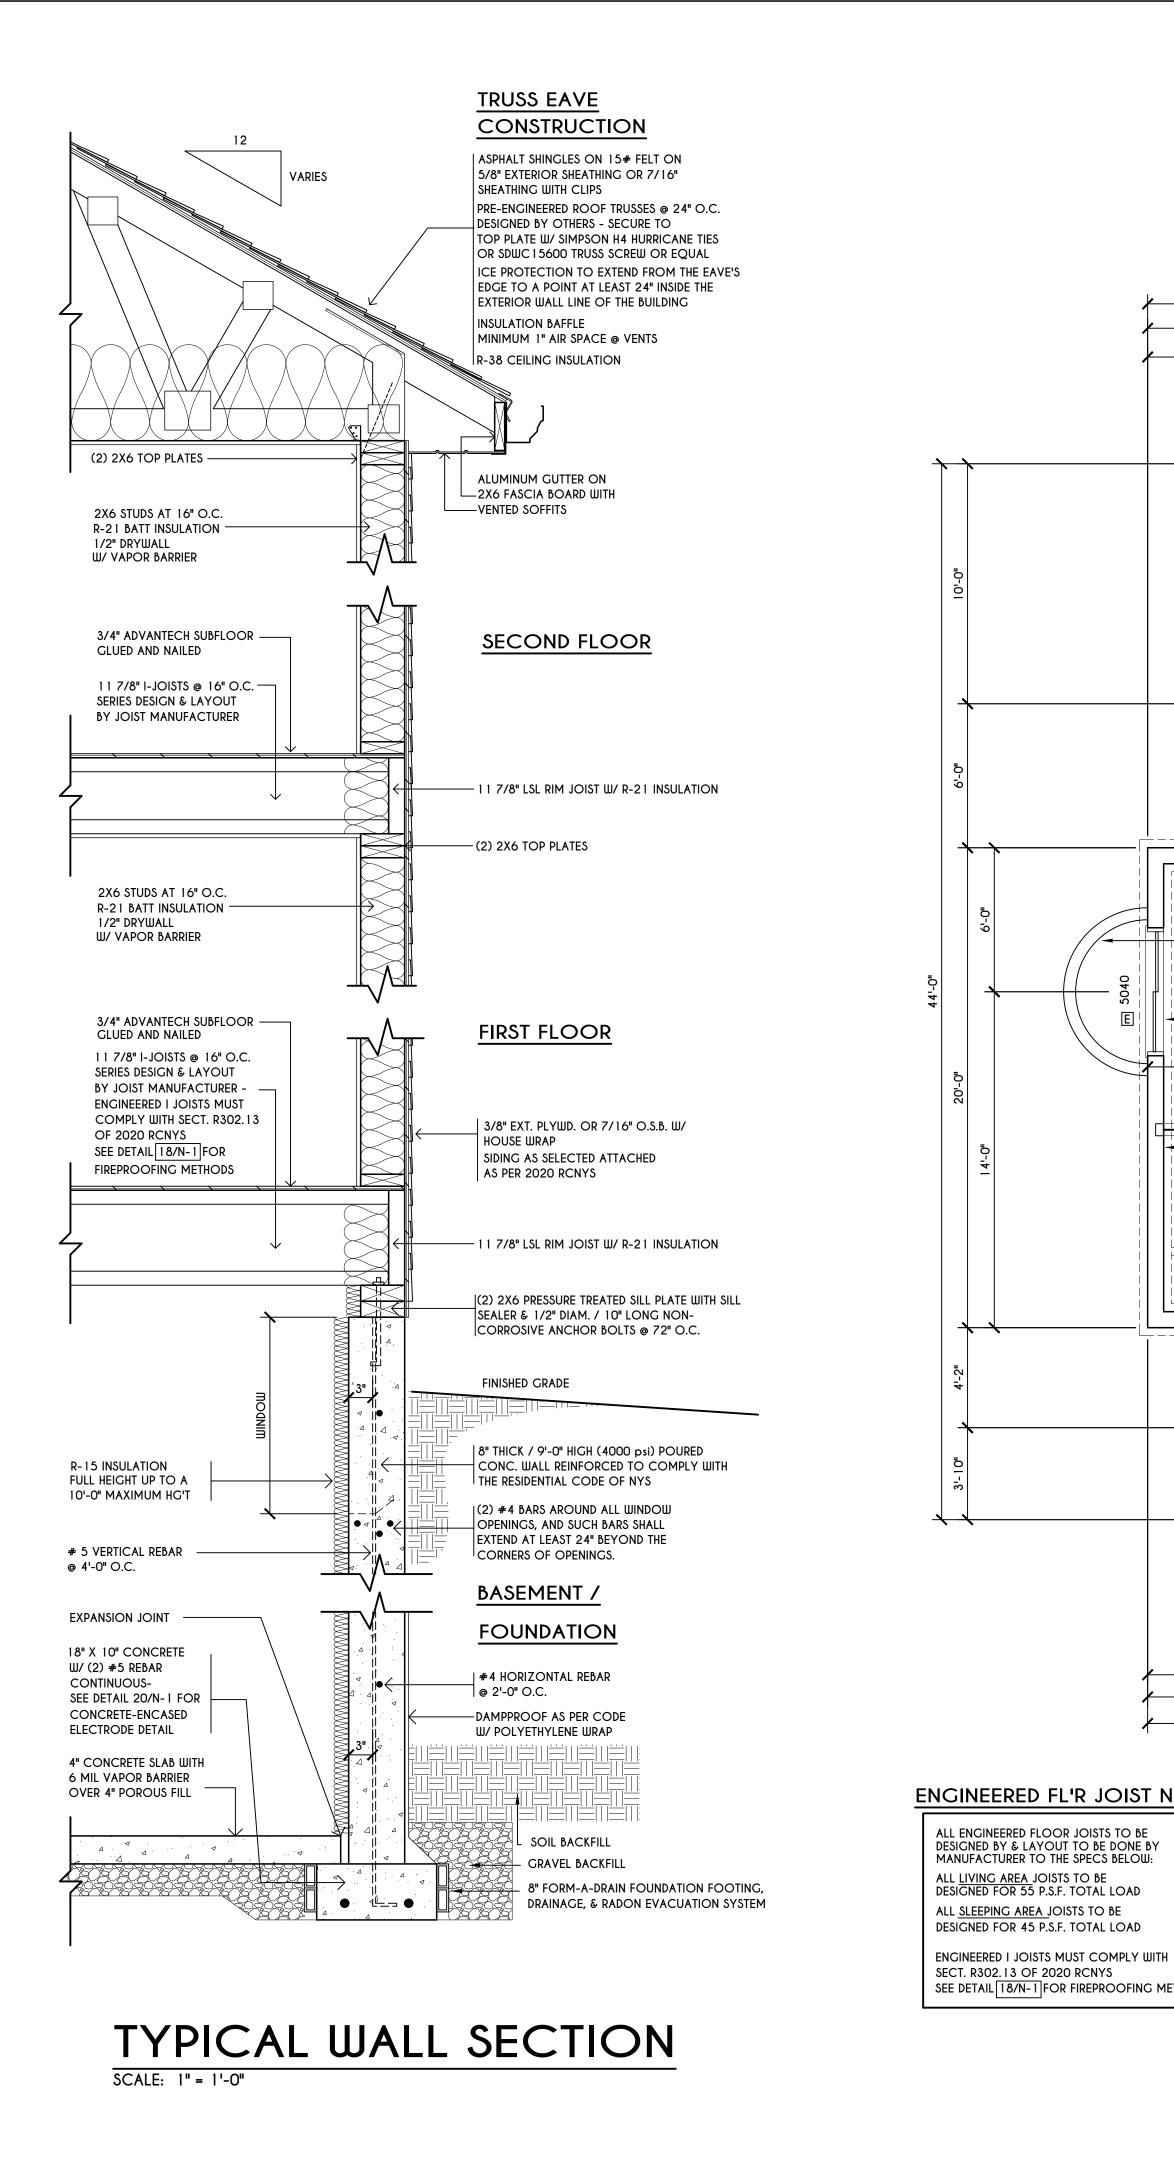


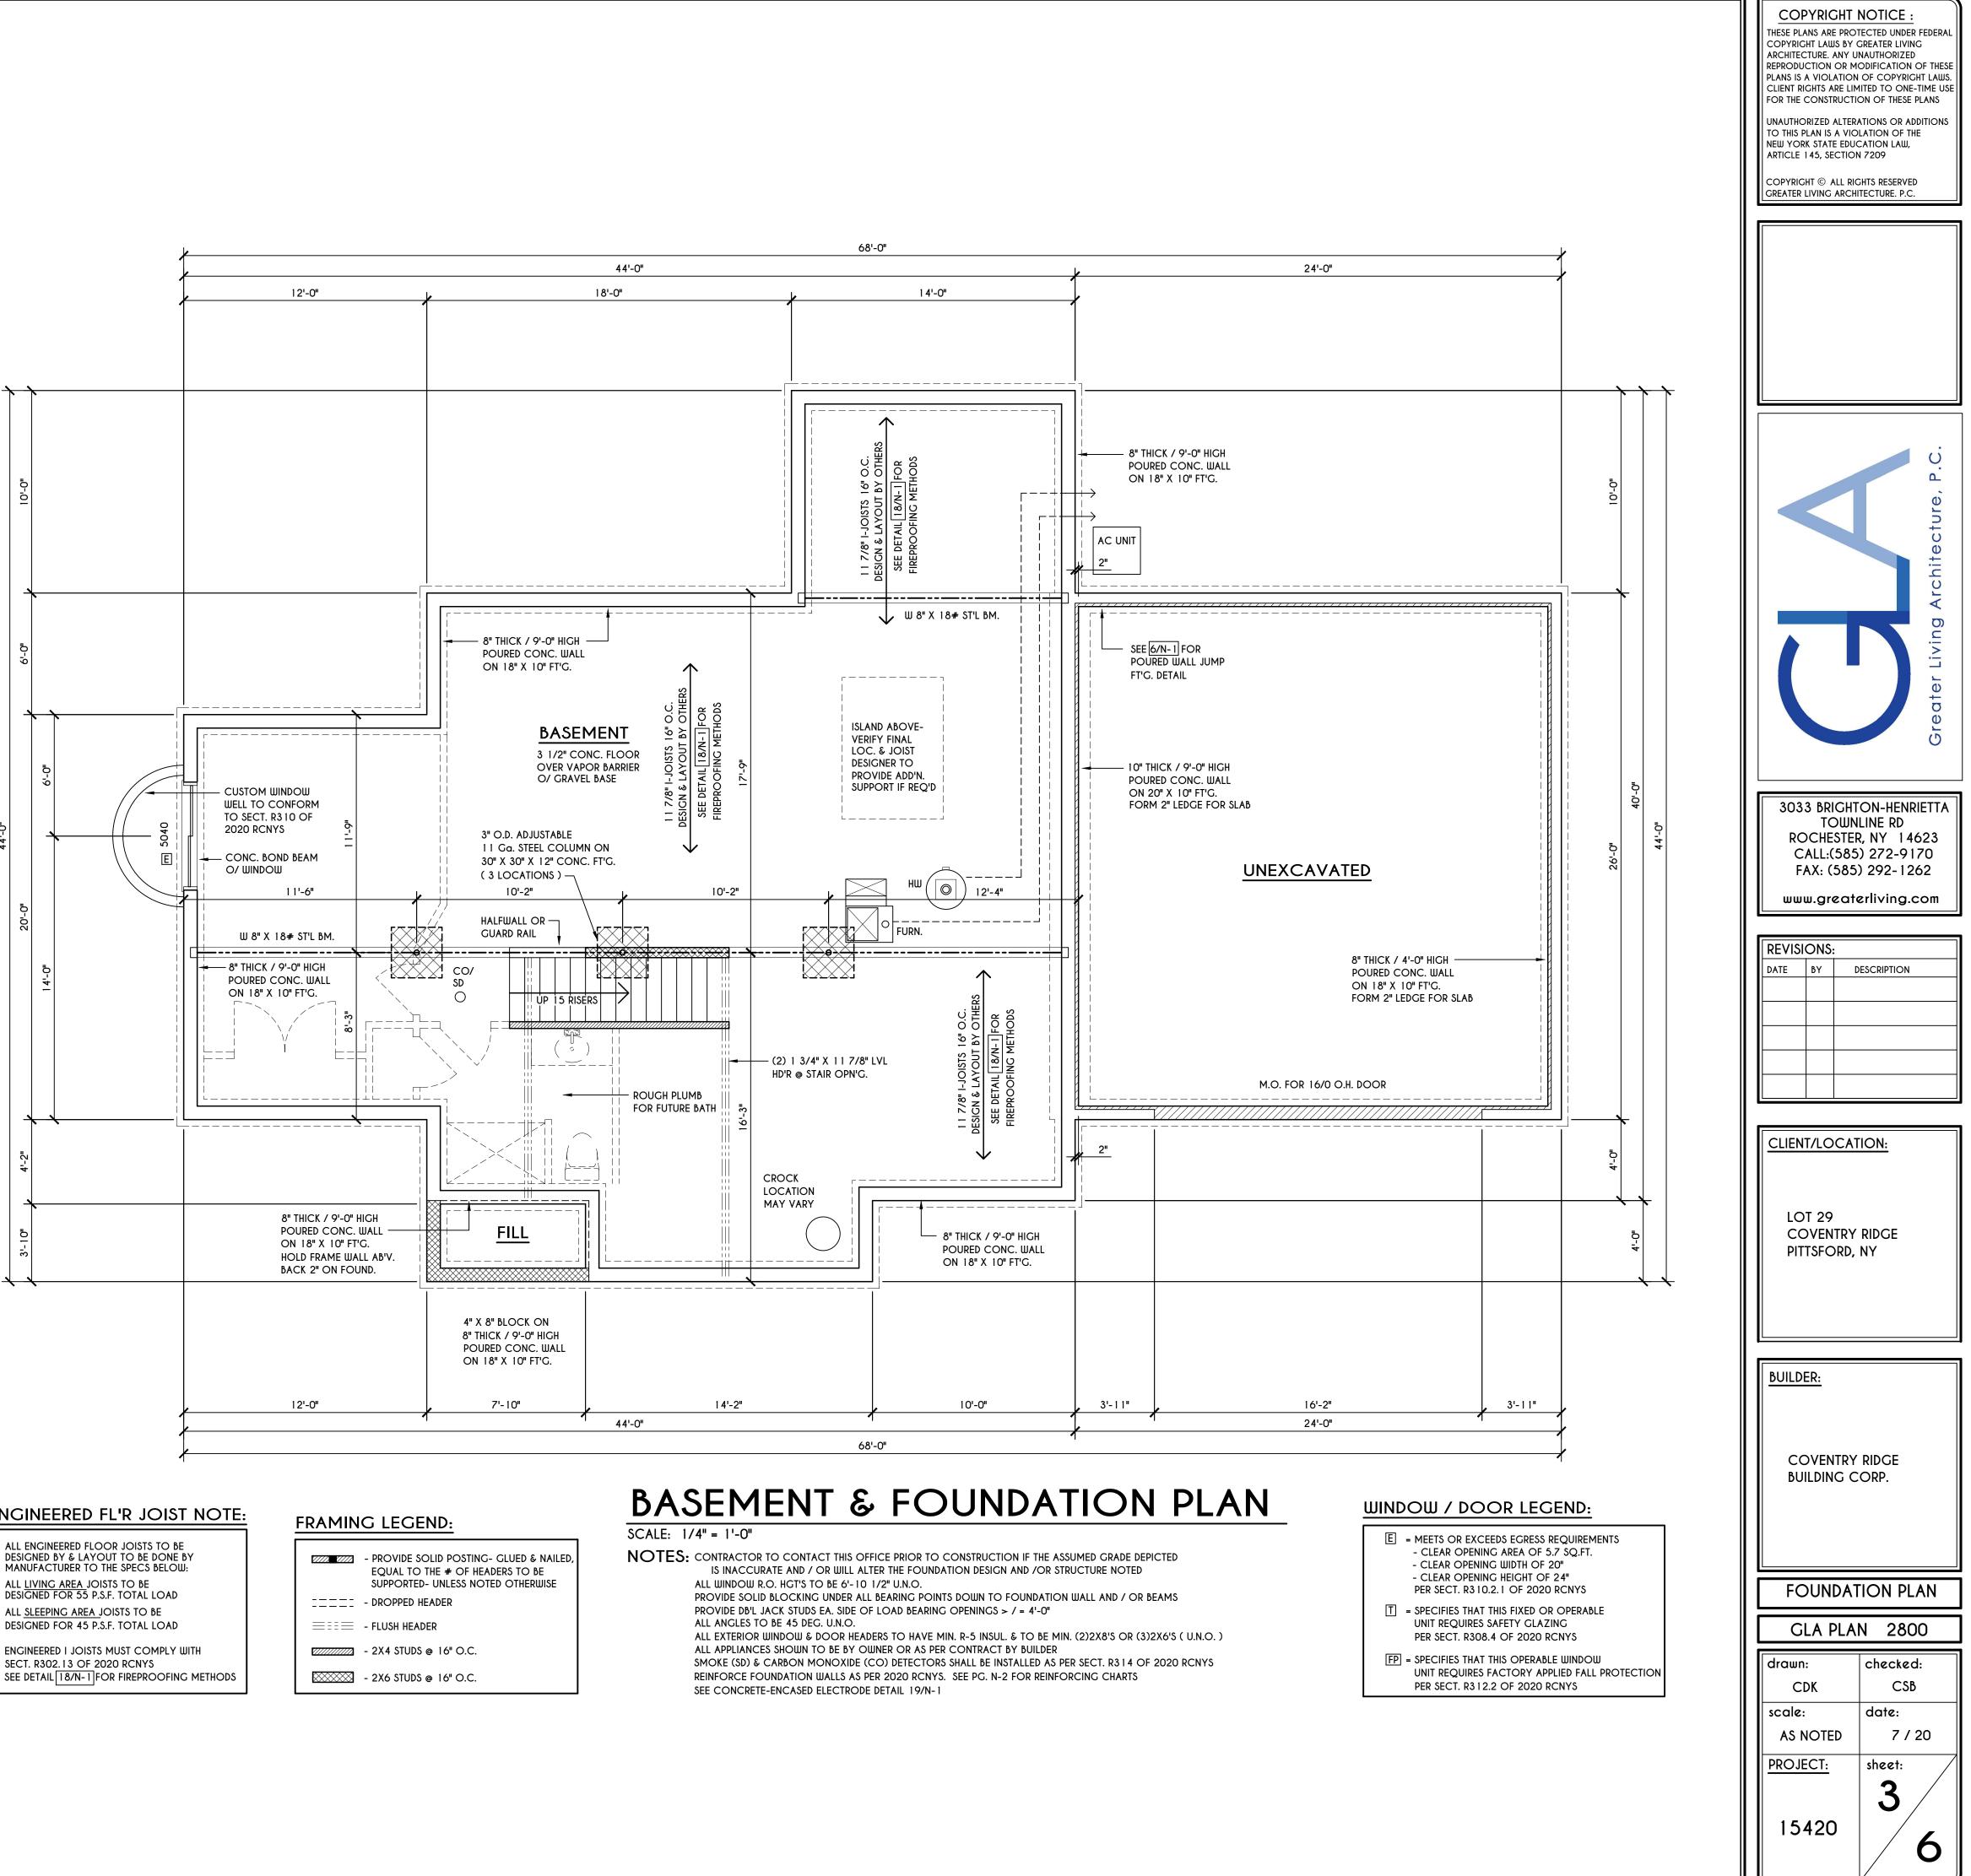


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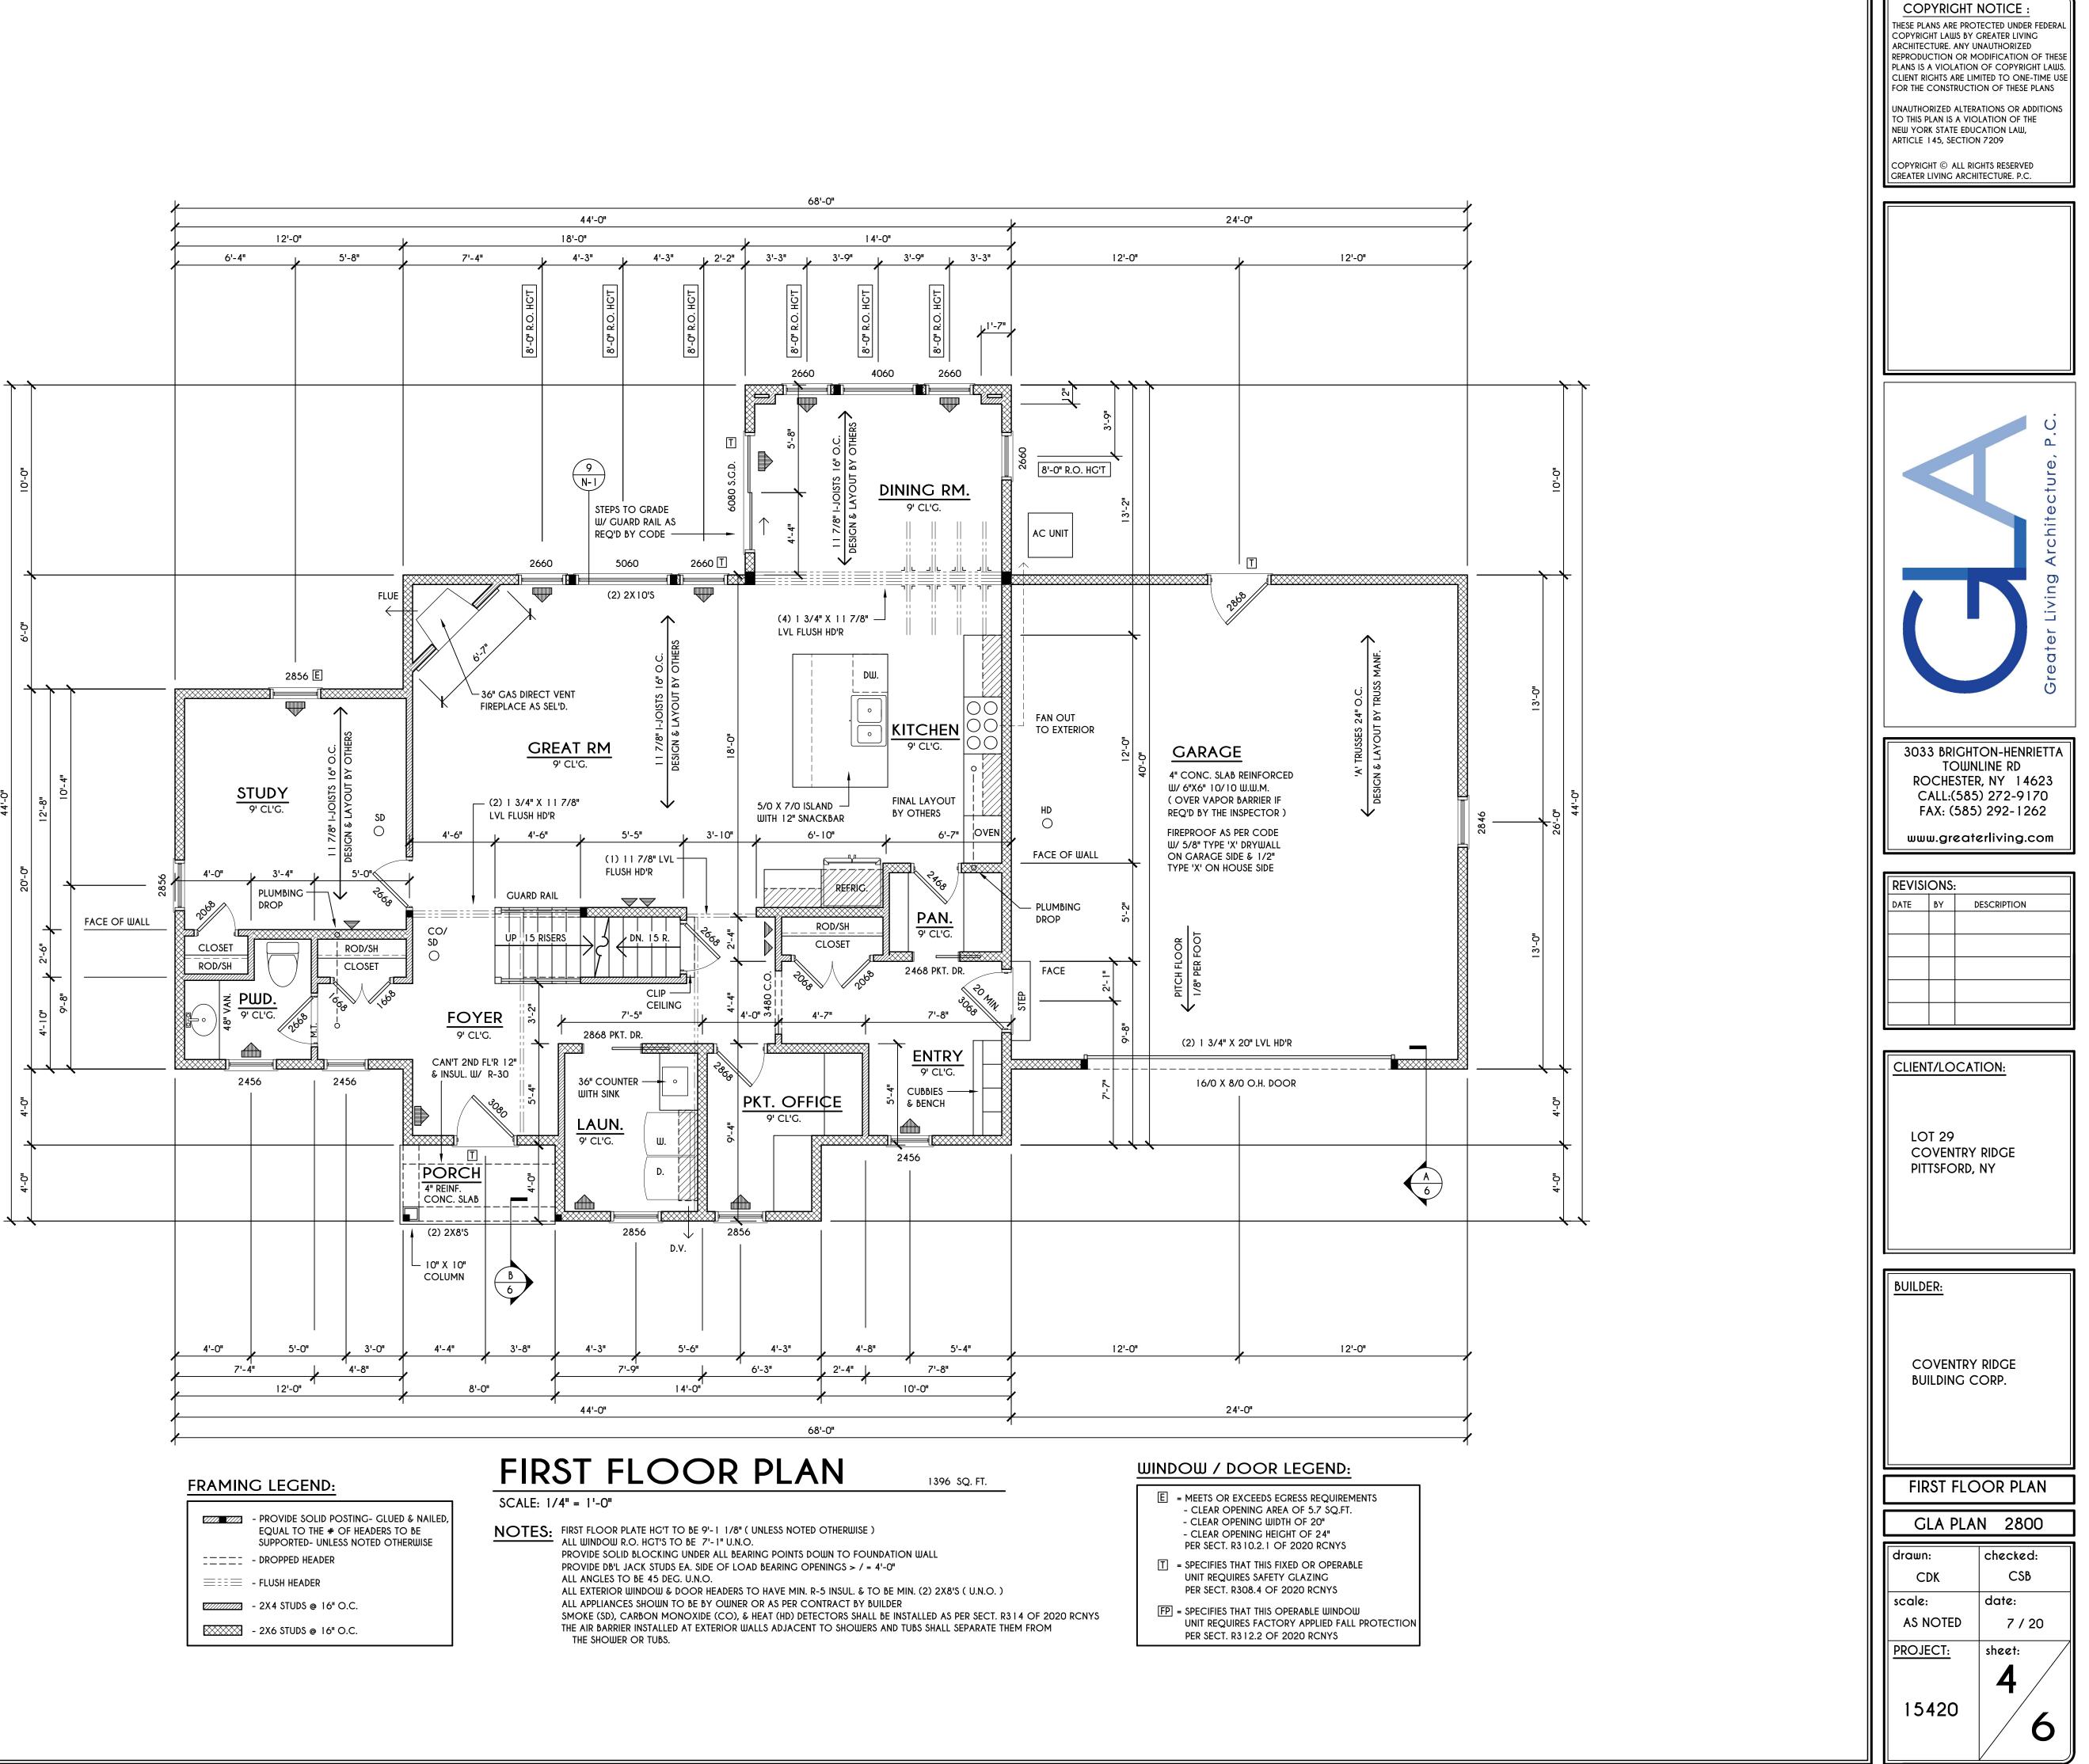
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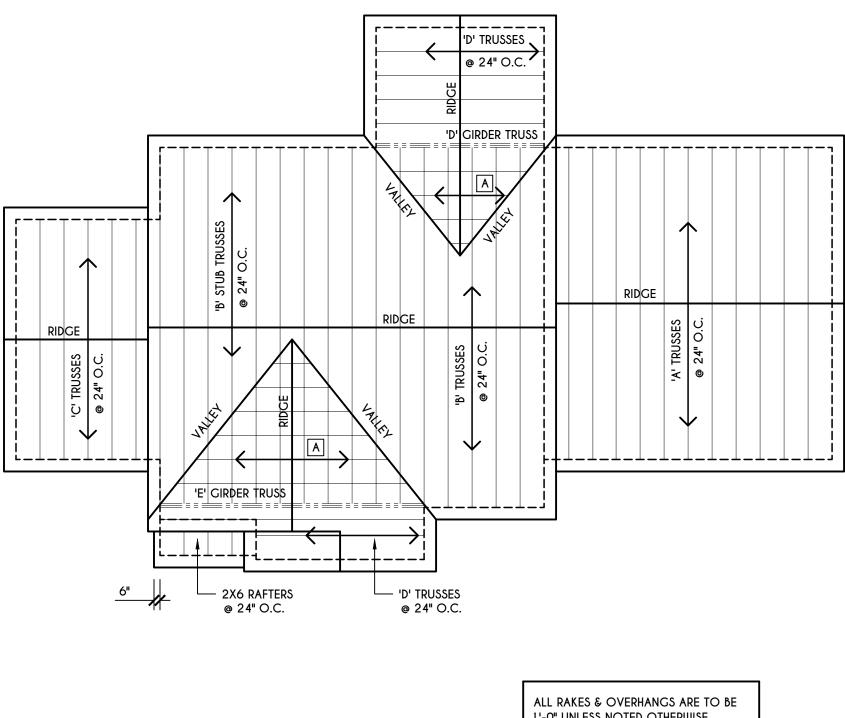




ENGINEERED FL'R JOIST NOTE:



	- PROVIDE SOLID EQUAL TO THE SUPPORTED- UN
:===:	- DROPPED HEADE
	- FLUSH HEADER
	- 2X4 STUDS @ 10
	- 2X6 STUDS @ 10







A – 2X8 LAYOVER RAFTERS 24" O.C.


1'-0" UNLESS NOTED OTHERWISE


ALL NON-STRUCTURAL VALLEYS TO HAVE 2X12 SLEEPER ATTACHED TO PLYWOOD ROOF SHEATHING

THIS FRAMING DIAGRAM IS INTENDED TO BE SCHEMATIC AND POSITION OF MEMBERS MAY BE ALTERED TO SUIT ACTUAL FIELD CONDITIONS

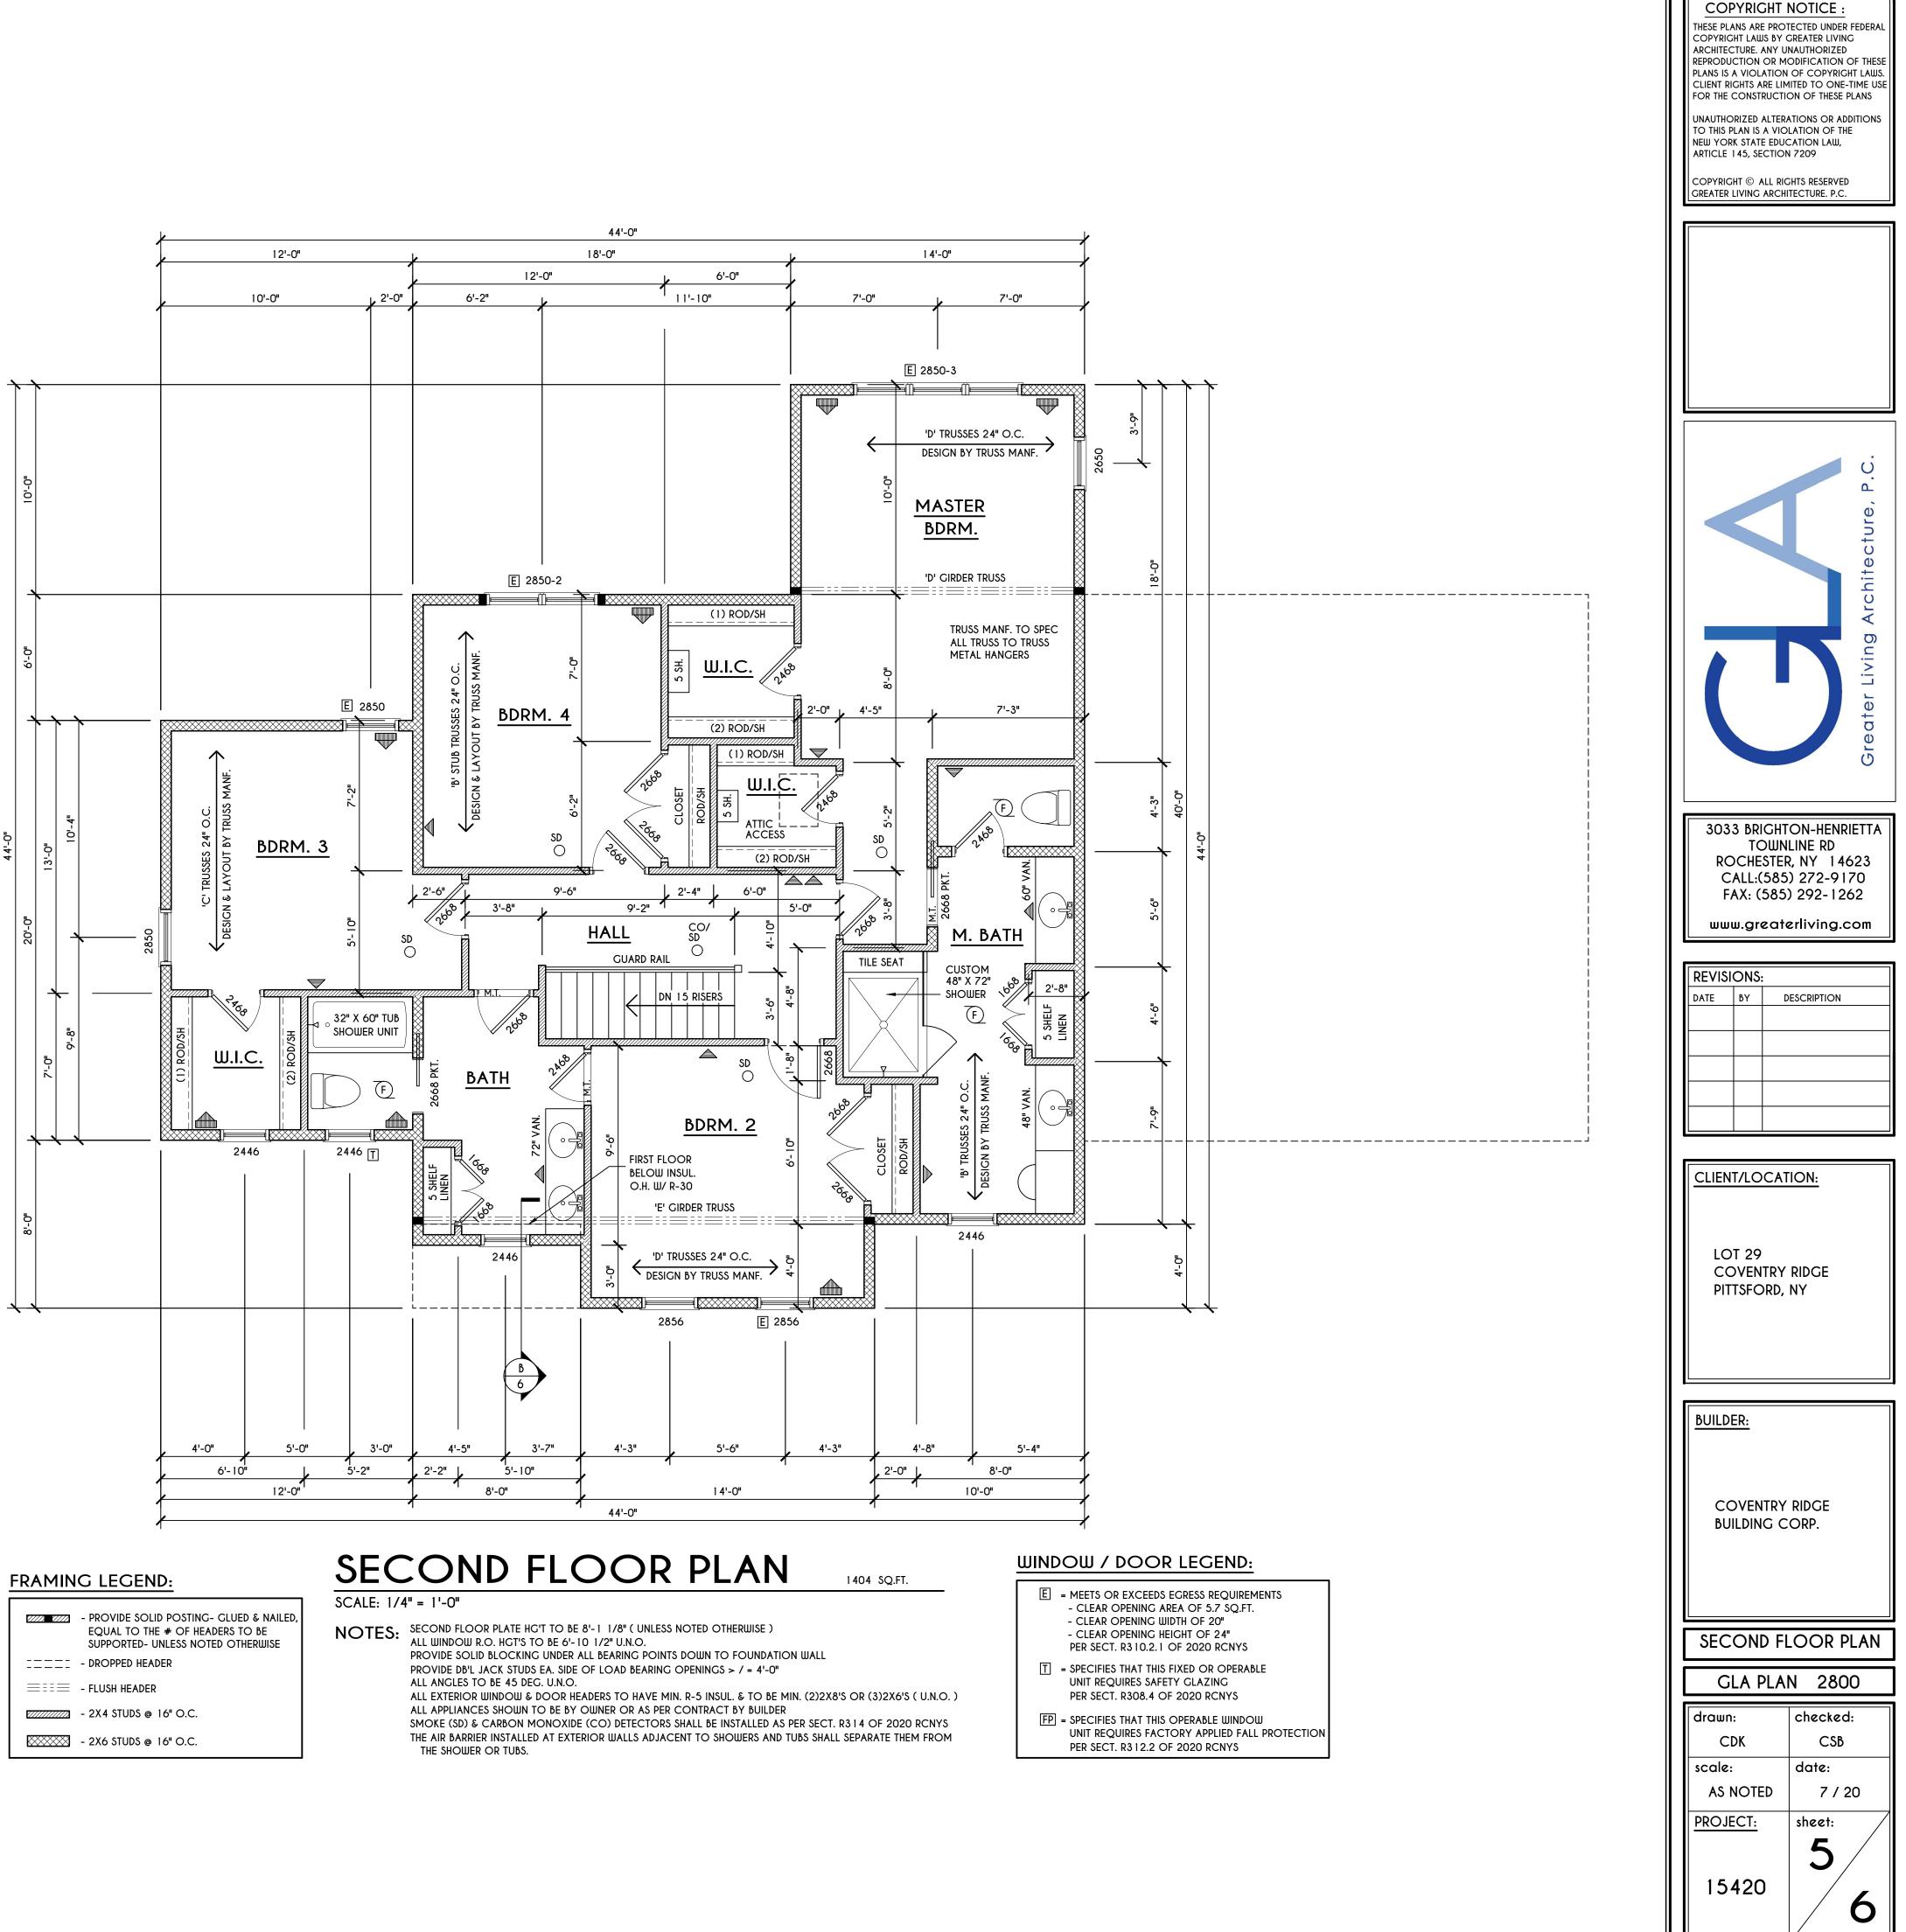

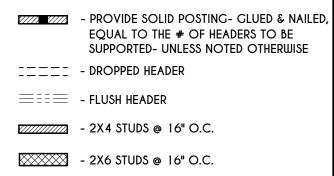

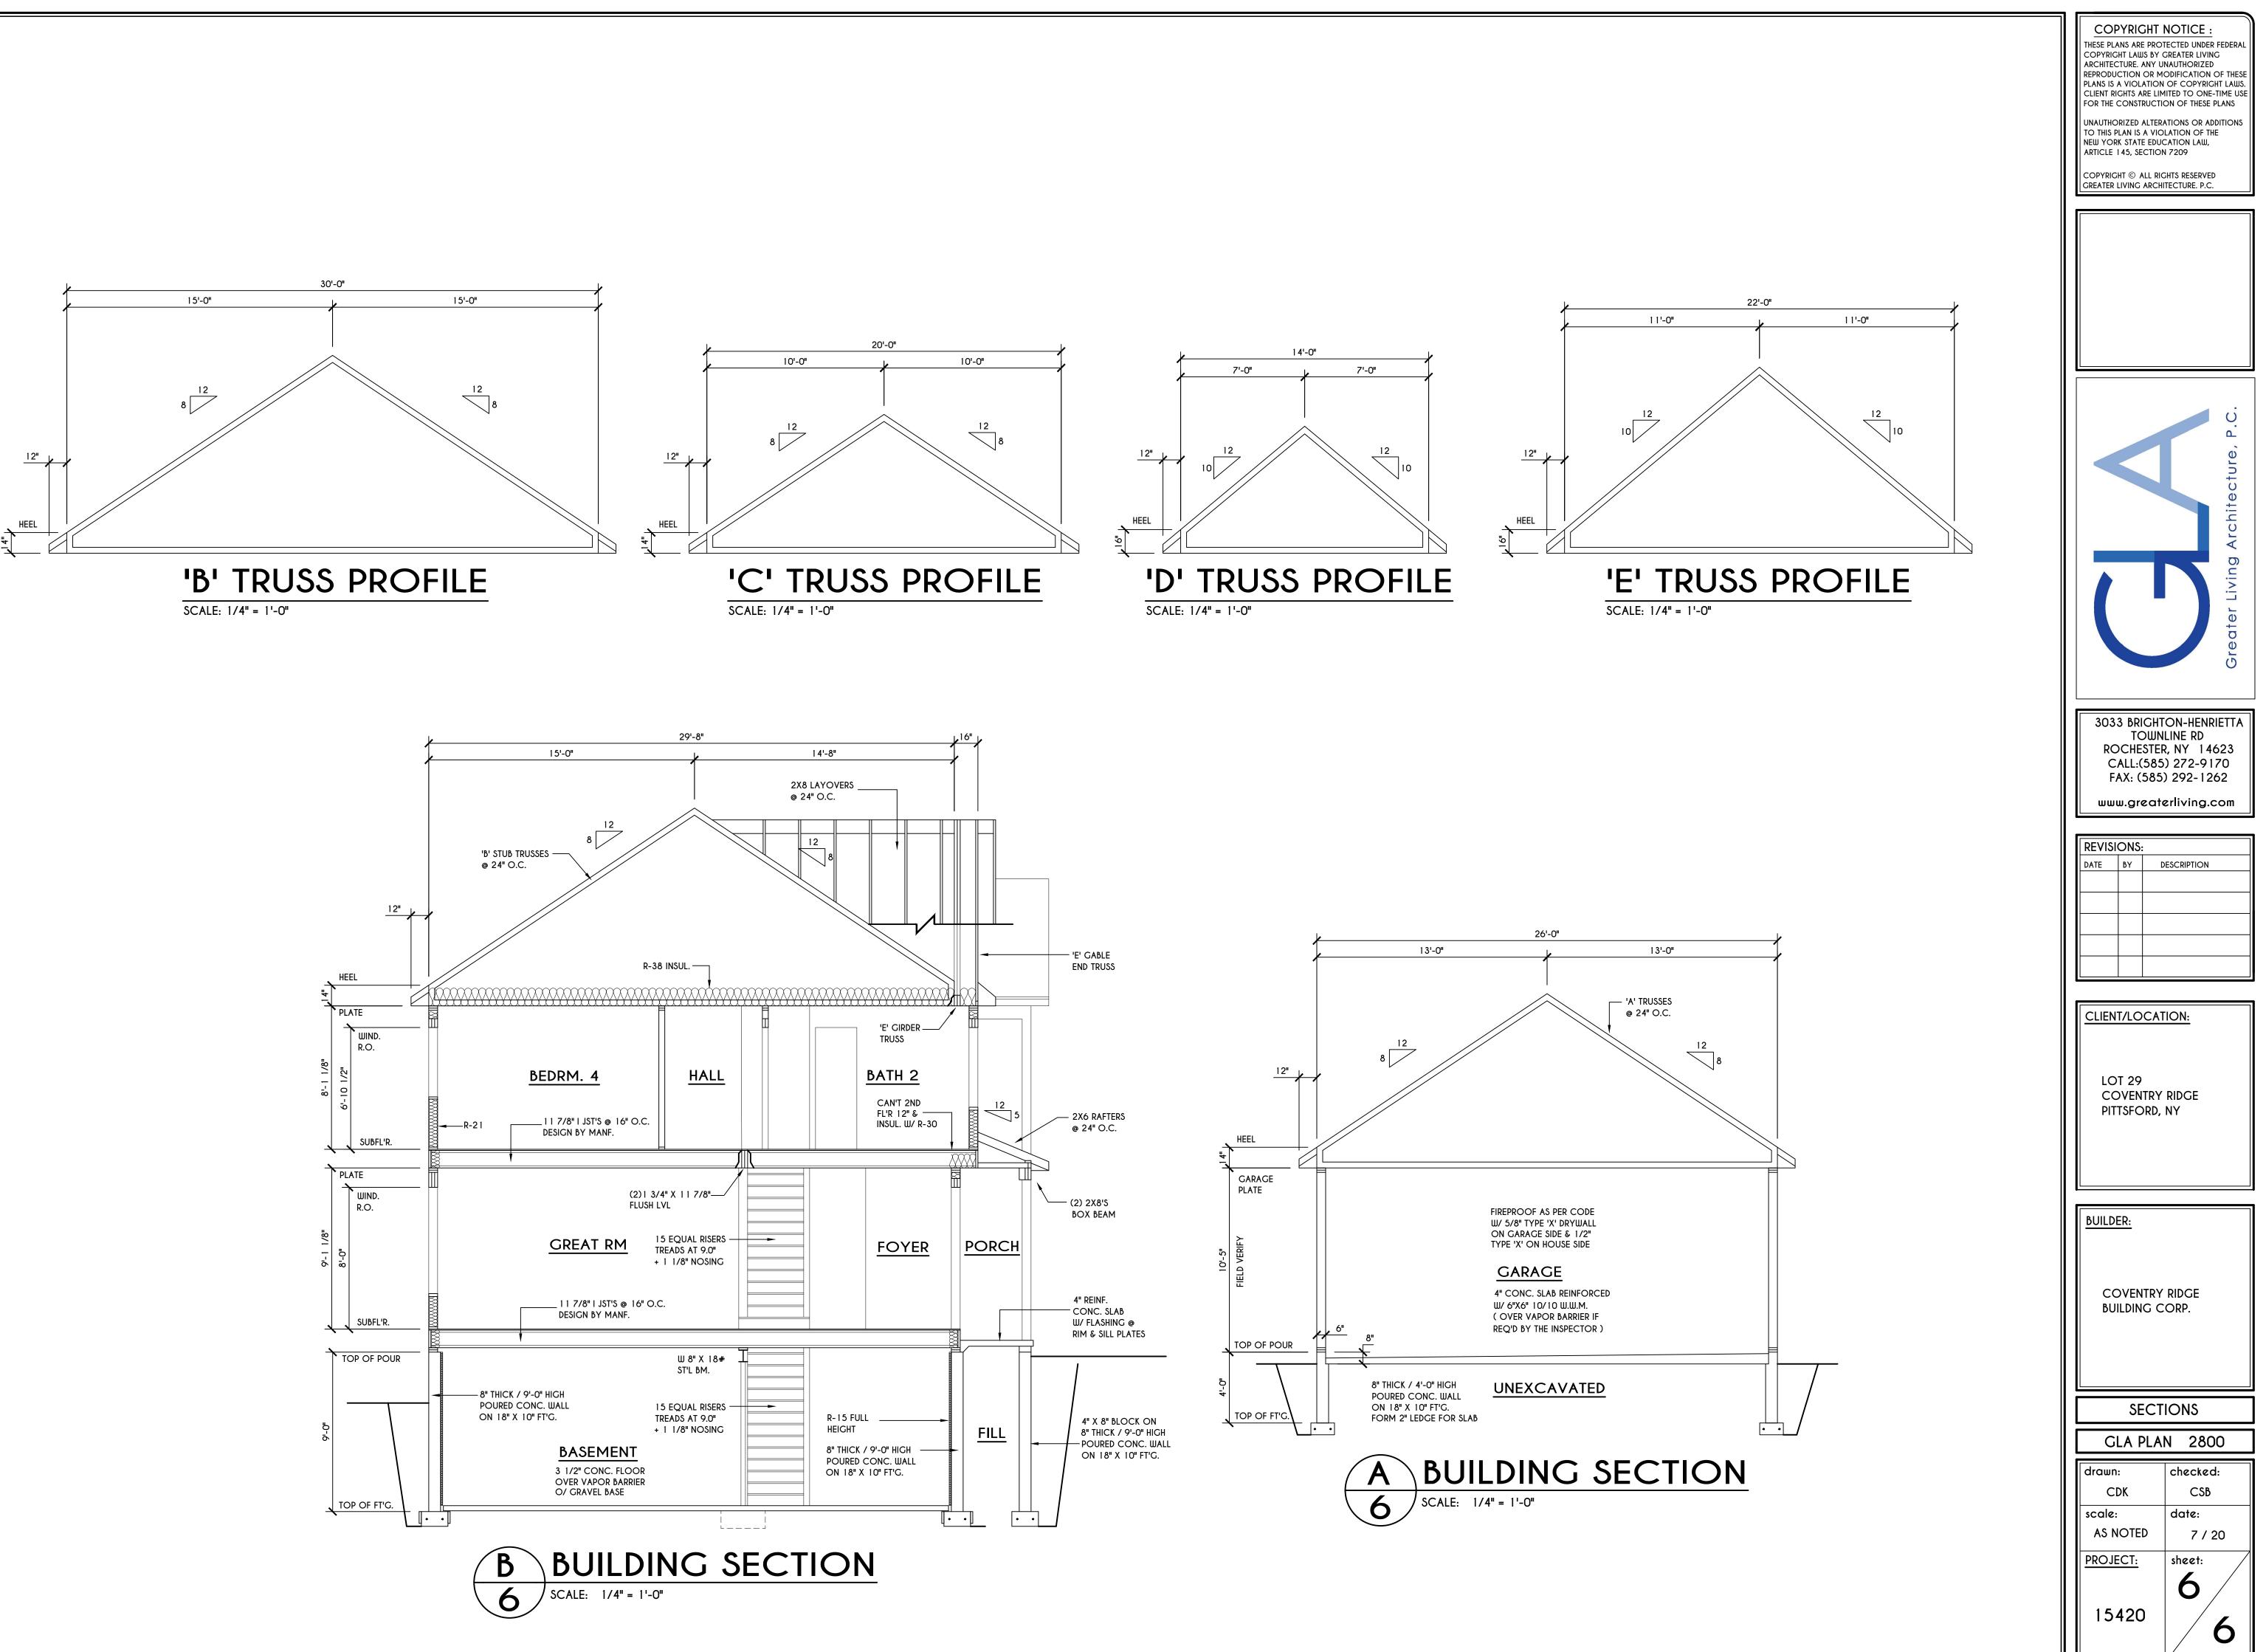

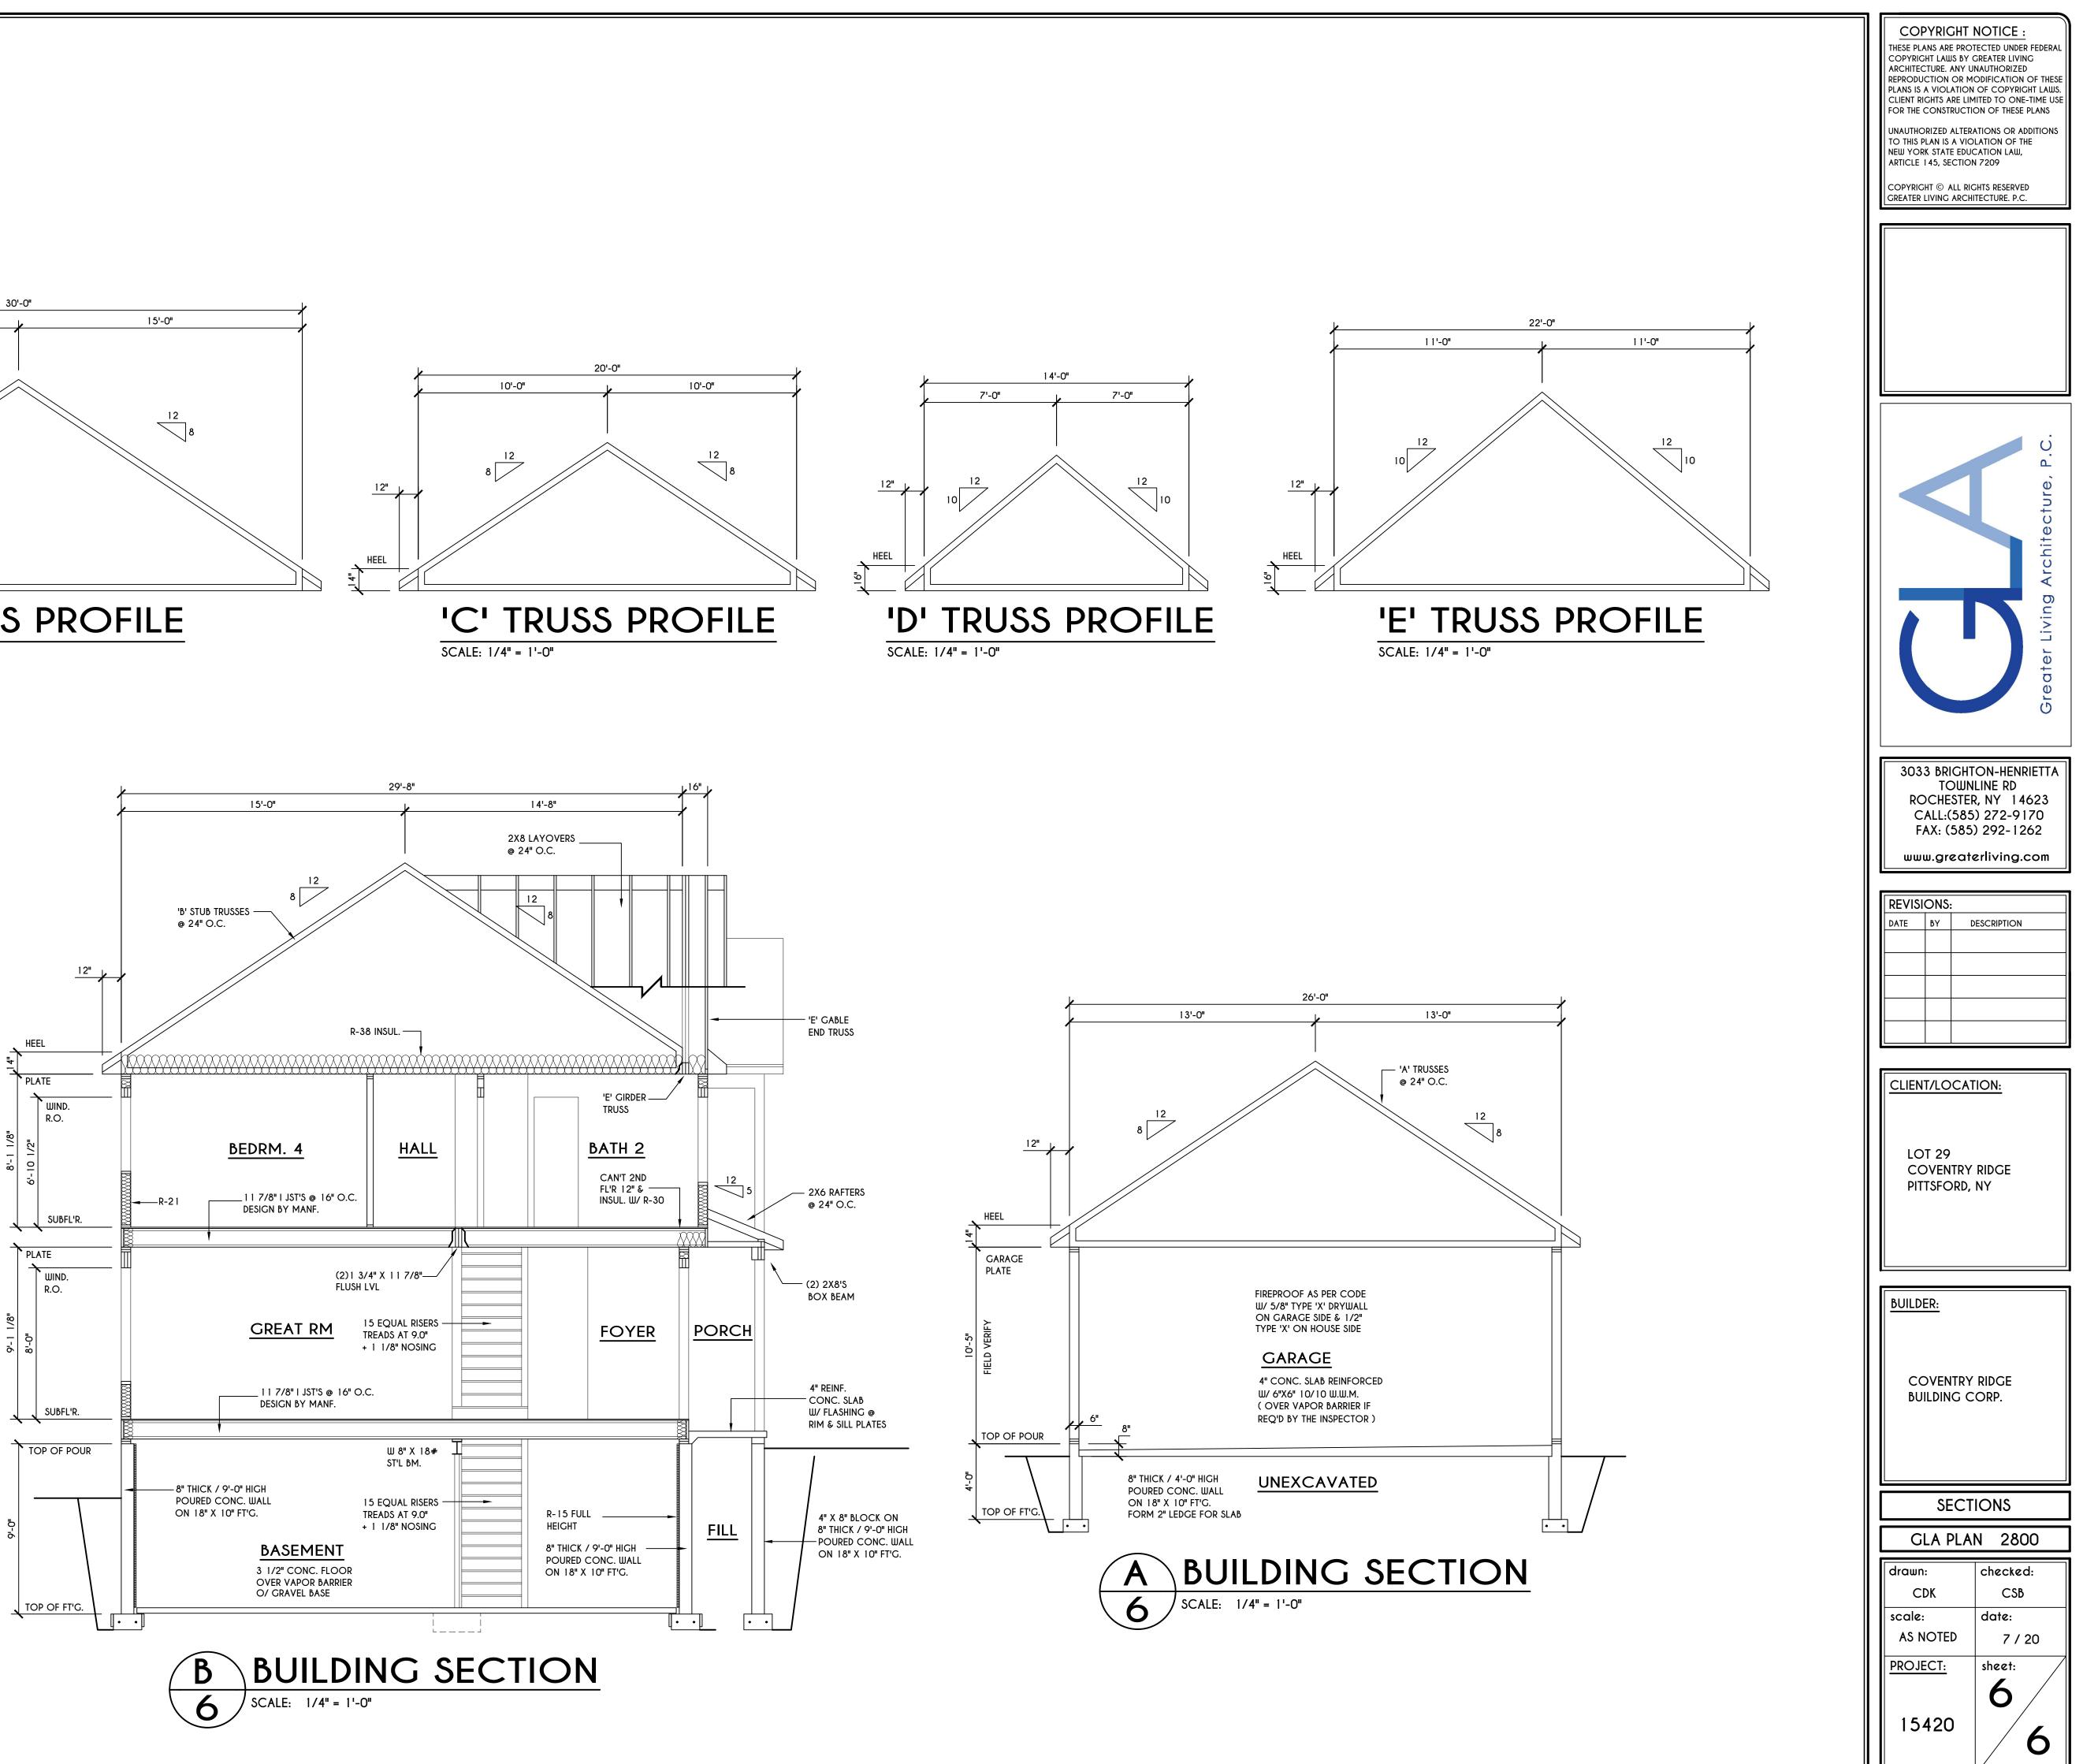

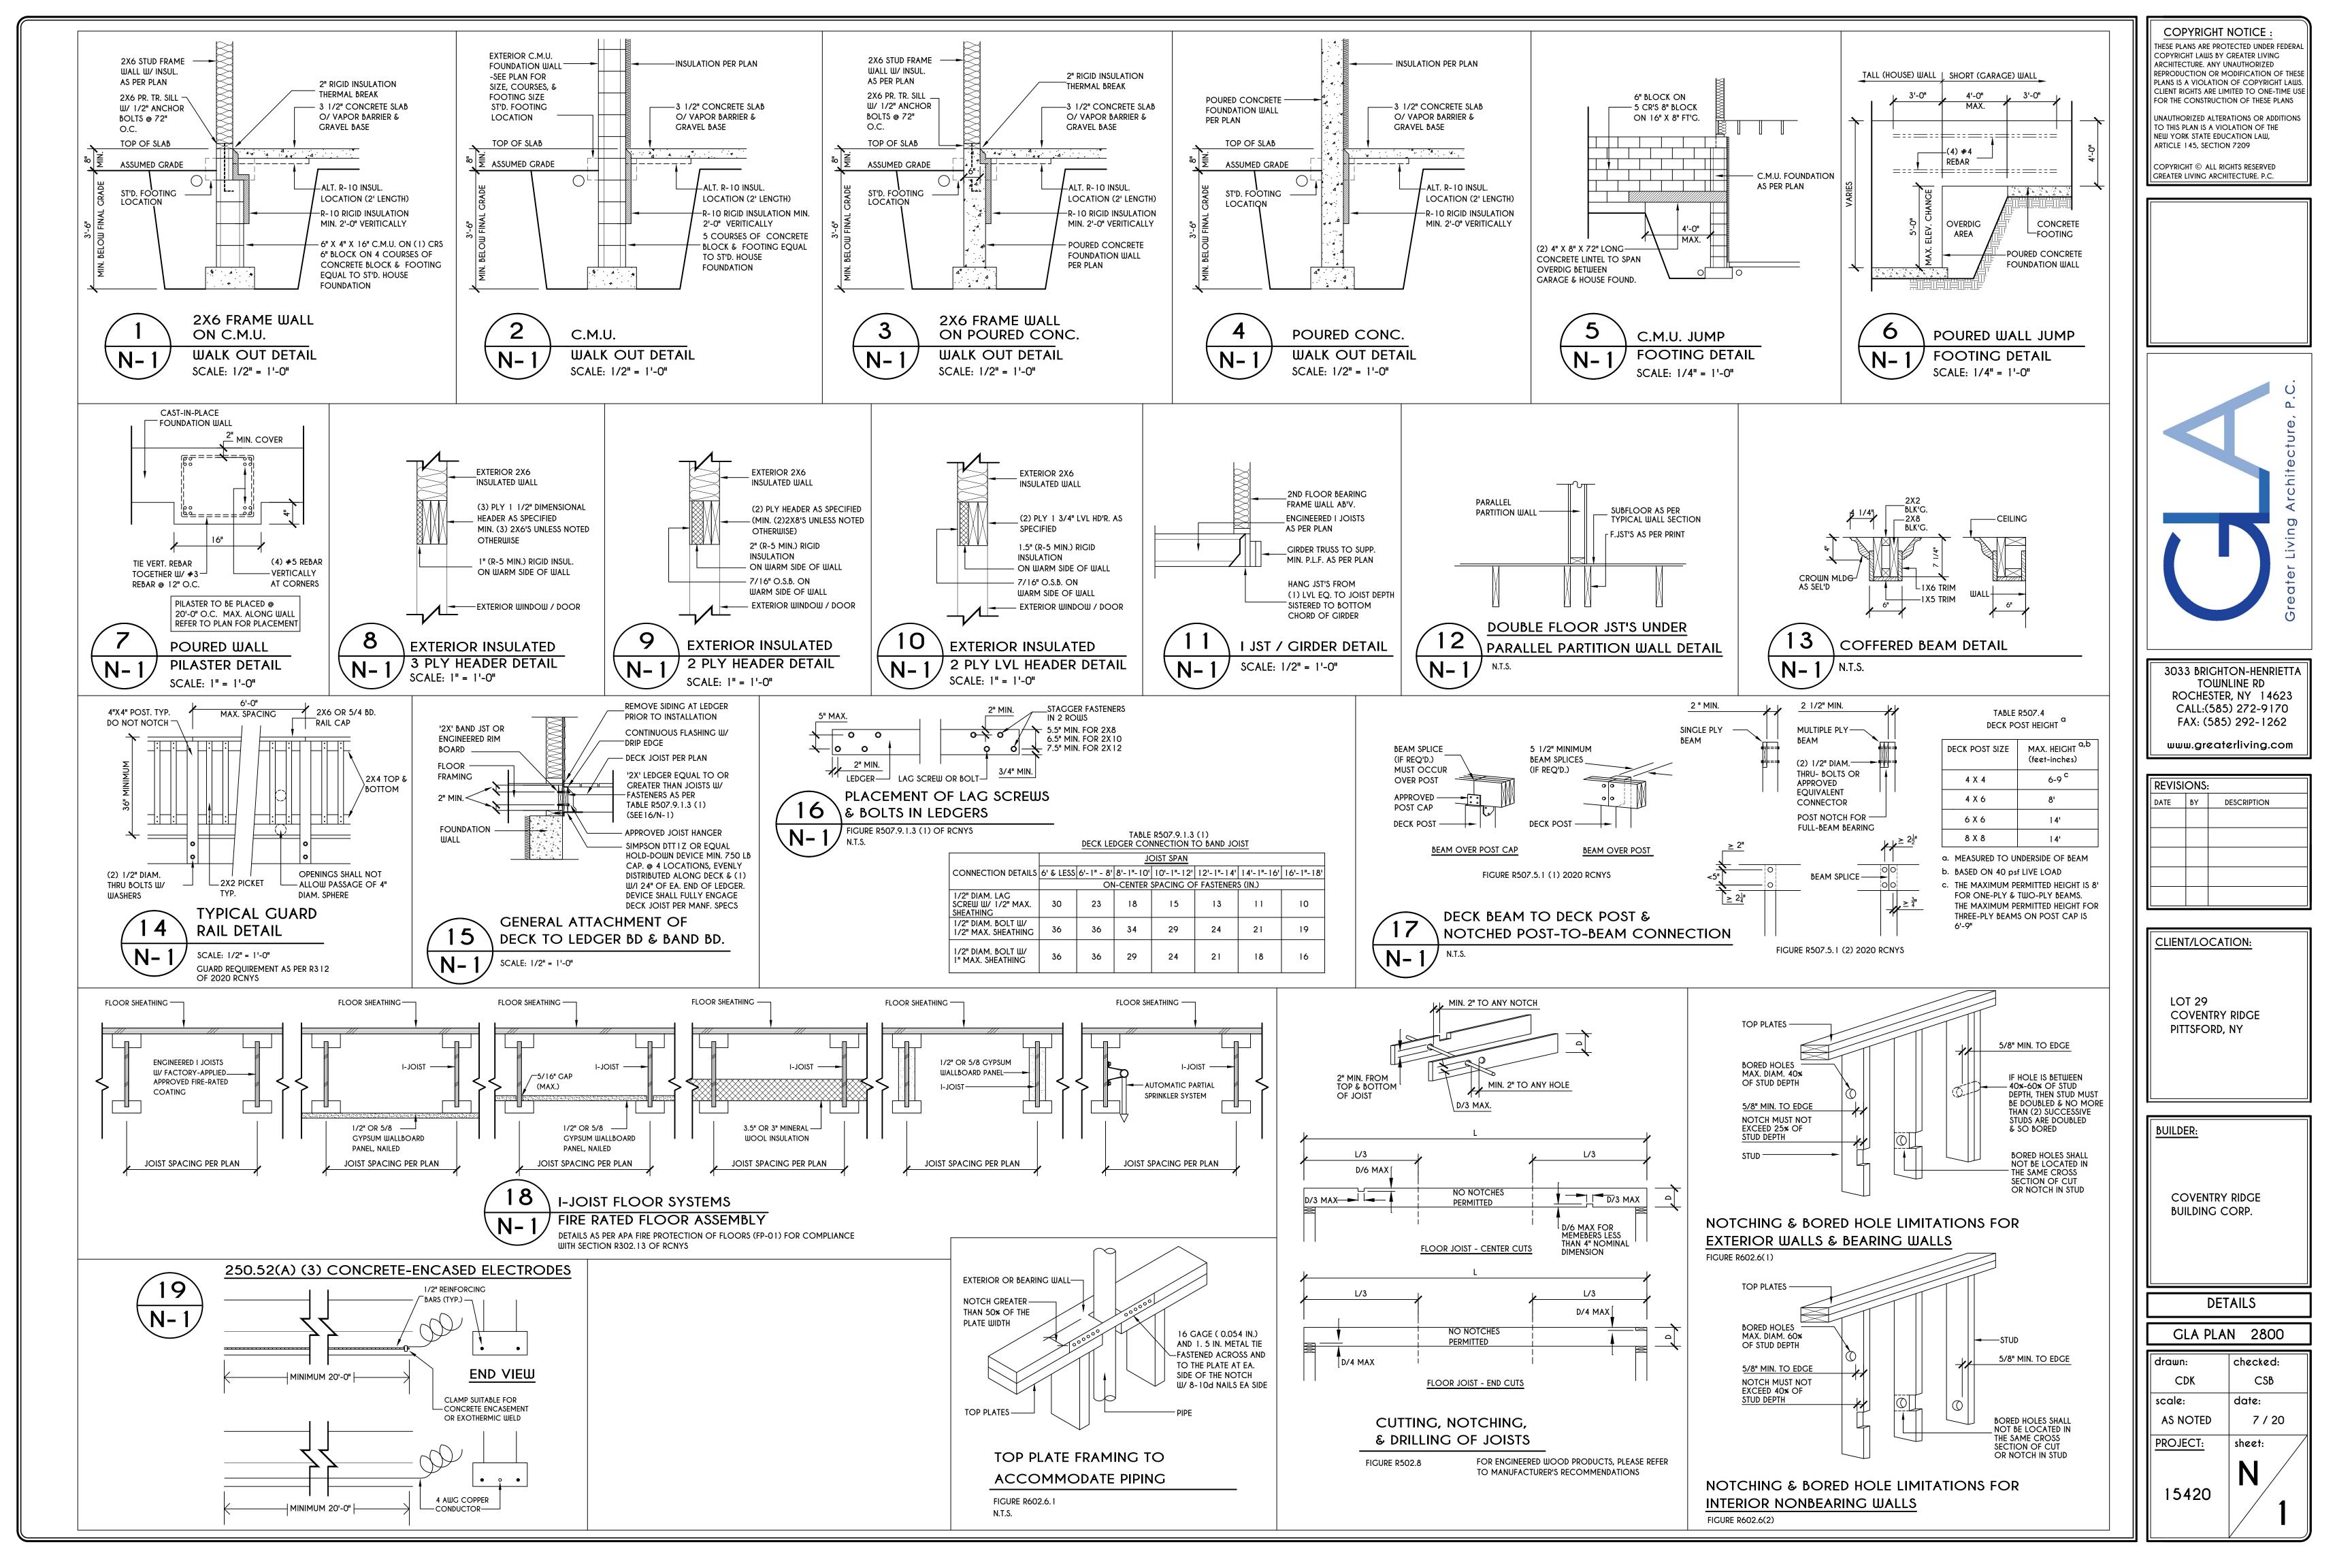


TABLE R404.1.1(2)

	8-INCH			> 5 INCHES a, c, f					
		8-INCH MASONRY FOUNDATION WALLS WITH REINFORCING WHERE d > 5 INCHES ^{a, c, f}							
			SOIL CLASSES AND LATERAL SOIL LOAD ^d (psf PER FOOT BELOW GRADE)						
WALL HEIGHT	HEIGHT OF UNBALANCED BACKFILL [©]			SC, MH, ML-CL AND INORGANIC CL SOILS 60					
6'-8"	4' (OR LESS)	#4 @ 48" O.C.	#4 @ 48" O.C.	#4 @ 48" O.C.					
	5'	#4 @ 48" O.C.	#4 @ 48" O.C.	#4 @ 48" O.C.					
	6'-8"	#4 @ 48" O.C.	#5 @ 48" O.C.	#6 @ 48" O.C.					
7'-4"	4' (OR LESS)	#4 @ 48" O.C.	#4 @ 48" O.C.	#4 @ 48" O.C.					
	5'	#4 @ 48" O.C.	#4 @ 48" O.C.	#4 @ 48" O.C.					
	6'	#4 @ 48" O.C.	#5 @ 48" O.C.	#5 @ 48" O.C.					
	7'-4"	#5 @ 48" O.C.	#6 @ 48" O.C.	#6 @ 40" O.C.					
8'-0"	4' (OR LESS)	#4 @ 48" O.C.	#4 @ 48" O.C.	#4 @ 48" O.C.					
	5'	#4 @ 48" O.C.	#4 @ 48" O.C.	#4 @ 48" O.C.					
	6'	#4 @ 48" O.C.	#5 @ 48" O.C.	#5 @ 48" O.C.					
	7'	#5 @ 48" O.C.	#6 @ 48" O.C.	#6 @ 40" O.C.					
	8'	#5 @ 48" O.C.	#6 @ 48" O.C.	#6 @ 32" O.C.					
8'-8"	4' (OR LESS)	#4 @ 48" O.C.	#4 @ 48" O.C.	#4 @ 48" O.C.					
	5'	#4 @ 48" O.C.	#4 @ 48" O.C.	#5 @ 48" O.C.					
	6'	#4 @ 48" O.C.	#5 @ 48" O.C.	#6 @ 48" O.C.					
	7'	#5 @ 48" O.C.	#6 @ 48" O.C.	#6 @ 40" O.C.					
	8'-8"	#6 @ 48" O.C.	#6 @ 32" O.C.	#6 @ 24" O.C.					
9'-4"	4' (OR LESS)	#4 @ 48" O.C.	#4 @ 48" O.C.	#4 @ 48" O.C.					
	5'	#4 @ 48" O.C.	#4 @ 48" O.C.	#5 @ 48" O.C.					
	6'	#4 @ 48" O.C.	#5 @ 48" O.C.	#6 @ 48" O.C.					
	7'	#5 @ 48" O.C.	#6 @ 48" O.C.	#6 @ 40" O.C.					
	8'	#6 @ 48" O.C.	#6 @ 40" O.C.	#6 @ 24" O.C.					
	9'-4"	#6 @ 40" O.C.	#6 @ 24" O.C.	#6 @ 16" O.C.					
10'-0"	4' (OR LESS)	#4 @ 48" O.C.	#4 @ 48" O.C.	#4 @ 48" O.C.					
	5'	#4 @ 48" O.C.	#4 @ 48" O.C.	#5 @ 48" O.C.					
	6'	#4 @ 48" O.C.	#5 @ 48" O.C.	#6 @ 48" O.C.					
	7'	#5 @ 48" O.C.	#6 @ 48" O.C.	#6 @ 32" O.C.					
	8'	#6 @ 48" O.C.	#6 @ 32" O.C.	#6 @ 24" O.C.					
	9'	#6 @ 40" O.C.	#6 @ 24" O.C.	#6 @ 16" O.C.					
	10'	#6 @ 32" O.C.	#6 @ 16" O.C.	#6 @ 16" O.C.					

a. MORTAR SHALL BE TYPE M OR S AND MASONRY SHALL BE LAID IN RUNNING BOND.

b. ALTERNATIVE REINFORCING BAR SIZES AND SPACING'S SHALL HAVE AN EQUIVALENT CROSS-SECTIONAL AREA OF REINFORCEMENT PER LINEAL FOOT OF WALL SHALL BE PERMITTED PROVIDED THE SPACING OF THE REINFORCEMENT DOES NOT EXCEED 72" IN SEISMIC DESIGN CATEGORIES A, B AND C, AND 48 INCHES IN SEISMIC DESIGN CATEGORIES DO, D 1 AND D2

c. VERTICAL REINFORCEMENT SHALL BE GRADE 60 MINIMUM. THE DISTANCE FROM THE FACE OF THE SOIL SIDE OF THE WALL TO THE CENTER OF VERTICAL REINFORCEMENT SHALL BE NOT LESS THAN 5 INCHES. d. SOIL CLASSES ARE IN ACCORDANCE WITH THE UNIFIED SOIL CLASSIFICATION SYSTEM AND DESIGN LATERAL SOIL LOADS ARE FOR

MOIST CONDITIONS WITHOUT HYDROSTATIC PRESSURE. REFER TO TABLE R405.1. e. UNBALANCED BACKFILL HEIGHT IS THE DIFFERENCE IN HEIGHT BETWEEN THE EXTERIOR FINISH GROUND LEVEL AND THE LOWER OF THE TOP OF THE CONCRETE FOOTING THAT SUPPORTS THE FOUNDATION WALL OR THE INTERIOR FINISH GROUND LEVEL. WHERE AN

INTERIOR CONCRETE SLAB-ON-GRADE IS PROVIDED AND IS IN CONTACT WITH THE INTERIOR SURFACE OF THE FOUNDATION WALL, MEASUREMENT OF THE UNBALANCED BACKFILL HEIGHT FROM THE EXTERIOR FINISH GROUND LEVEL TO THE TOP OF THE INTERIOR CONCRETE SLAB IS PERMITTED. f. THE USE OF THIS TABLE SHALL BE PROHIBITED FOR SOIL CLASSIFICATIONS NOT SHOWN.

TABLE R404.1.1(3)

	10-INC	MASONRY FOUNDATION W	ALLS WITH REINFORCING
		MINIMUN	1 VERTICAL REINFORCE
		SOIL CLASSE	ES AND LATERAL SOIL LO
WALL HEIGHT	HEIGHT OF UNBALANCED BACKFILL [©]	GW, GP, SW, AND SP SOILS 30	GM, GS, SM-SC AND M 45
6'-8"	4' (OR LESS)	#4 @ 56" O.C.	#4 @ 56" O.C.
	5'	#4 @ 56" O.C.	#4 @ 56" O.C.
	6'-8"	#4 @ 56" O.C.	#5 @ 56" O.C.
7'-4"	4' (OR LESS)	#4 @ 56" O.C.	#4 @ 56" O.C.
	5'	#4 @ 56" O.C.	#4 @ 56" O.C.
	6'	#4 @ 56" O.C.	#4 @ 56" O.C.
	7'-4"	#4 @ 56" O.C.	#5 @ 56" O.C.
8'-0"	4' (OR LESS)	#4 @ 56" O.C.	#4 @ 56" O.C.
	5'	#4 @ 56" O.C.	#4 @ 56" O.C.
	6'	#4 @ 56" O.C.	#4 @ 56" O.C.
	7'	#4 @ 56" O.C.	#5 @ 56" O.C.
	8'	#5 @ 56" O.C.	#6 @ 56" O.C.
8'-8"	4' (OR LESS)	#4 @ 56" O.C.	#4 @ 56" O.C.
	5'	#4 @ 56" O.C.	#4 @ 56" O.C.
	6'	#4 @ 56" O.C.	#4 @ 56" O.C.
	7'	#4 @ 56" O.C.	#5 @ 56" O.C.
	8'-8"	#5 @ 56" O.C.	#6 @ 56" O.C.
9'-4"	4' (OR LESS)	#4 @ 56" O.C.	#4 @ 56" O.C.
	5'	#4 @ 56" O.C.	#4 @ 56" O.C.
	6'	#4 @ 56" O.C.	#5 @ 56" O.C.
	7'	#4 @ 56" O.C.	#5 @ 56" O.C.
	8'	#5 @ 56" O.C.	#6 @ 56" O.C.
	9'-4"	#6 @ 56" O.C.	#6 @ 40" O.C.
10'-0"	4' (OR LESS)	#4 @ 56" O.C.	#4 @ 56" O.C.
	5'	#4 @ 56" O.C.	#4 @ 56" O.C.
	6'	#4 @ 56" O.C.	#5 @ 56" O.C.
	7'	#5 @ 56" O.C.	#6 @ 56" O.C.
	8'	#5 @ 56" O.C.	#6 @ 48" O.C.
	9'	#6 @ 56" O.C.	#6 @ 40" O.C.
	10'	#6 @ 48" O.C.	#6 @ 32" O.C.

a. MORTAR SHALL BE TYPE M OR S AND MASONRY SHALL BE LAID IN RUNNING BOND. b. ALTERNATIVE REINFORCING BAR SIZES AND SPACINGS SHALL HAVE AN EQUIVALENT CROSS-SECTIONAL AREA OF REINFORCEMENT PER LINEAL FOOT OF WALL SHALL BE PERMITTED PROVIDED THE SPACING OF THE REINFORCEMENTDOES NOT EXCEED 72" IN SEISMIC DESIGN CATEGORIES A, B AND C, AND 48 INCHES IN SEISMIC DESIGN CATEGORIES DO, D1 AND D2. c. VERTICAL REINFORCEMENT SHALL BE GRADE 60 MINIMUM. THE DISTANCE FROM THE FACE OF THE SOIL SIDE OF THE WALL TO THE CENTER OF VERTICAL REINFORCEMENT SHALL BE NOT LESS THAN 6.75 INCHES. d. SOIL CLASSES ARE IN ACCORDANCE WITH THE UNIFIED SOIL CLASSIFICATION SYSTEM AND DESIGN LATERAL SOIL LOADS ARE FOR MOIST CONDITIONS WITHOUT HYDROSTATIC PRESSURE. REFER TO TABLE R405.1. e. UNBALANCED BACKFILL HEIGHT IS THE DIFFERENCE IN HEIGHT BETWEEN THE EXTERIOR FINISH GROUND LEVEL AND THE LOWER OF THE TOP OF THE CONCRETE FOOTING THAT SUPPORTS THE FOUNDATION WALL OR THE INTERIOR FINISH GROUND LEVEL. WHERE AN INTERIOR CONCRETE SLAB-ON-GRADE IS PROVIDED AND IS IN CONTACT WITH THE INTERIOR SURFACE OF THE FOUNDATION WALL, MEASUREMENT OF THE UNBALANCED BACKFILL HEIGHT FROM THE EXTERIOR FINISH GROUND LEVEL TO THE TOP OF THE INTERIOR

CONCRETE SLAB IS PERMITTED. f. THE USE OF THIS TABLE SHALL BE PROHIBITED FOR SOIL CLASSIFICATIONS NOT SHOWN.

	TABLE	ER 40	2.4.1.1		
AIR BARRIER	AND	INSUL	ATION	INSTAL	LATIC

COMPONENT	AIR BARRIER CRITERIA	INSULATION INSTALLATION CRI
	A CONTINUOUS AIR BARRIER SHALL BE INSTALLED IN THE BUILDING ENVELOPE.	
GENERAL REQUIREMENTS	THE EXTERIOR THERMAL ENVELOPE CONTAINS A CONTINUOUS AIR BARRIER.	AIR-PERMEABLE INSULATION SHALL NOT BE USED AS A SEALING MATERIAL.
	BREAKS OR JOINTS IN THE AIR BARRIER SHALL BE SEALED.	
CEILING / ATTIC	THE AIR BARRIER IN ANY DROPPED CEILING / SOFFIT SHALL BE ALIGNED WITH THE INSULATION AND ANY GAPS IN THE AIR BARRIER SHALL BE SEALED.	THE INSULATION IN ANY DROPPED CEILING / SOFFIT SHALL BE ALIGNED WITH THE AIR BARRIER.
	ACCESS OPENINGS, DROP DOWN STAIRS, OR KNEE WALL DOORS TO UNCONDITIONED ATTIC SPACES SHALL BE SEALED.	SOTTI SHALL DE ALIONED WITH THE AIR DARRIER.
	THE JUNCTION OF THE FOUNDATION AND SILL PLATE SHALL BE SEALED.	CAVITIES WITH CORNERS AND HEADERS OF FRAME WALLS SHALL BE INSULATED BY COMPLETELY FILLING THE
WALLS	THE JUNCTION OF THE TOP PLATE AND THE TOP OF EXTERIOR WALLS SHE BE SEALED.	CAVITY WITH A MATERIAL HAVING A THERMAL RESISTANCE OF R-3 PER INCH MINIMUM.
	KNEE WALLS SHALL BE SEALED.	EXTERIOR THERMAL ENVELOPE INSULATION FOR FRAMED WALLS SHALL BE INSTALLED IN SUBSTANTIAL CONTACT AND CONTINUOUS ALIGNMENT WITH THE AIR BARRIER.
WINDOWS, SKYLIGHTS AND DOORS	THE SPACE BETWEEN WINDOW / DOOR JAMBS AND FRAMING, AND SKYLIGHTS AND FRAMING SHALL BE SEALED.	
RIM JOISTS	RIM JOISTS SHALL INCLUDE THE AIR BARRIER.	RIM JOISTS SHALL BE INSULATED.
FLOORS (INCLUDING ABOVE GARAGE AND CANTILEVERED FLOORS)	THE AIR BARRIER SHALL BE INSTALLED AT ANY EXPOSED EDGE OF INSULATION.	FLOOR FRAMING CAVITY INSULATION SHALL BE INSTALLED TO MAINTAIN PERMANENT CONTACT WITH THE UNDERSIDE OF SUBFLOOR DECKING, OR FLOOR FRAMING CAVITY INSULATION SHALL BE PERMITTED TO BE IN CONTACT WITH THE TOP SIDE OF SHEATHING, OR CONTINUOUS INSULATION INSTALLED ON THE UNDERSIDE OF FLOOR FRAMING AND EXTENDS FROM THE BOTTOM TO THE TOP OF ALL PERIMETER FLOOR FRAMING MEMBERS.
CRAWL SPACE WALLS	EXPOSED EARTH IN UNVENTED CRAWL SPACES SHALL BE COVERED WITH A CLASS I VAPOR RETARDER WITH OVERLAPPING JOINTS TAPED.	WHERE PROVIDED INSTEAD OF FLOOR INSULATION, INSULATION SHALL BE PERMANENTLY ATTACHED TO THE CRAWLSPACE WALLS.
SHAFTS, PENETRATIONS	DUCT SHAFTS, UTILITY PENETRATIONS, AND FLUE SHAFTS OPENING THE EXTERIOR OR UNCONDITIONED SPACE SHALL BE SEALED.	
NARROW CAVITIES		BATTS IN NARROW CAVITIES SHALL BE CUT TO FIT, OR NARROW CAVITIES SHALL BE FILLED BY INSULATION THAT ON INSTALLATION READILY CONFORMS TO THE AVAILABLE CAVITY SPACE.
GARAGE SEPARATION	AIR SEALING SHALL BE PROVIDED BETWEEN THE GARAGE AND CONDITIONED SPACES.	
RECESSED LIGHTING	RECESSED LIGHT FIXTURES INSTALLED IN THE BUILDING THERMAL ENVELOPE SHALL BE SEALED TO THE DRYWALL.	RECESSED LIGHT FIXTURES INSTALLED IN THE BUILDING THERMAL ENVELOPE SHALL BE AIR TIGHT AND IC RATED.
PLUMBING AND WIRING		BATT INSULATION SHALL BE CUT NEATLY TO FIT AROUND I AND PLUMBING IN EXTERIOR WALLS, OR INSULATION THAT INSTALLATION READILY CONFORMS TO AVAILABLE SPACE EXTEND BEHIND PIPING AND WIRING.
SHOWER / TUB ON EXTERIOR WALL	THE AIR BARRIER INSTALLED AT EXTERIOR WALLS ADJACENT TO SHOWERS AND TUBS SHALL SEPARATE THEM FROM THE SHOWERS AND TUBS.	EXTERIOR WALLS ADJACENT TO SHOWERS AND TUBS SHALL BE INSULATED.
ELECTRICAL / PHONE BOX ON EXTERIOR WALLS	THE AIR BARRIER SHALL BE INSTALLED BEHIND ELECTRICAL OR COMMUNICATION BOXES OR AIR-SEALED BOXES SHALL BE INSTALLED.	
HVAC REGISTER BOOTS	HVAC REGISTER BOOTS THAT PENETRATE BUILDING THERMAL ENVELOPE SHALL BE SEALED TO THE SUBFLOOR OR DRYWALL.	
CONCEALED SPRINKLERS	WHEN REQUIRED TO BE SEALED, CONCEALED FIRE SPRINKLERS SHALL ONLY BE SEALED IN A MANNER THAT IS RECOMMENDED BY THE MANUFACTURER. CAULKING OR OTHER ADHESIVE SEALANTS SHALL NOT BE USED TO FILL VOIDS BETWEEN FIRE SPRINKLER COVER PLATES AND WALL OR CEILINGS.	

a. IN ADDITION, INSPECTION OF LOG WALLS SHALL BE IN ACCORDANCE WITH THE PROVISIONS OF ICC-400.

10-INCH MASONRY FOUNDATION WALLS WITH REINFORCING WHERE d > 6.75 INCHES a, c, fORCEMENT AND SPACING (INCHES)^{b, c} SOIL LOAD ^d (psf PER FOOT BELOW GRADE) AND ML SOILS SC, MH, ML-CL AND INORGANIC CL SOILS #4 @ 56" O.C #4 @ 56" O.0 #5 @ 56" O.0 0.C. #4 @ 56" O.C. #4 @ 56" O.C #5 @ 56" O.C #6 @ 56" O.C #4 @ 56" O.C. 0.C. O.C. #4 @ 56" O.C. O.C. #5 @ 56" O.C. #6 @ 56" O.C. #6 @ 48" O.C O.C. #4 @ 56" O.C. #4 @ 56" O.C #5 @ 56" O.C #6 @ 56" O.C #6 @ 32" O.C #4 @ 56" O.C. 0.C. #4 @ 56" O.C. #5 @ 56" O.C. #6 @ 56" O.C. #6 @ 40" O.C #6 @ 24" 0.0

#4 @ 56" O.C. O.C. #4 @ 56" O.C. #5 @ 56" O.C #6 @ 48" O.C #6 @ 40" O.C #6 @ 24" O.C #6 @ 24" O.C

	12-INCI	H MASONRY FOUNDATION W		d > 8.75 INCHES ^{a, c, f}			
		MINIMUM VERTICAL REINFORCEMENT AND SPACING (INCHES) ^{b, c}					
			psf PER FOOT BELOW GRADE)				
WALL HEIGHT	HEIGHT OF UNBALANCED BACKFILL [©]	GW, GP, SW, AND SP SOILS 30	GM, GS, SM-SC AND ML SOILS 45	SC, MH, ML-CL AND INORGANIC CL SOILS 60			
6'-8"	4' (OR LESS)	#4 @ 72" O.C.	#4 @ 72" O.C.	#4 @ 72" O.C.			
	5'	#4 @ 72" O.C.	#4 @ 72" O.C.	#4 @ 72" O.C.			
	6'-8"	#4 @ 72" O.C.	#4 @ 72" O.C.	#5 @ 72" O.C.			
7'-4"	4' (OR LESS) 5' 6' 7'-4"	#4 @ 72" O.C. #4 @ 72" O.C. #4 @ 72" O.C. #4 @ 72" O.C. #4 @ 72" O.C.	#4 @ 72" O.C. #4 @ 72" O.C. #4 @ 72" O.C. #5 @ 72" O.C.	#4 @ 72" O.C. #4 @ 72" O.C. #5 @ 72" O.C. #6 @ 72" O.C.			
8'-0"	4' (OR LESS)	#4 @ 72" O.C.	#4 @ 72" O.C.	#4 @ 72" O.C.			
	5'	#4 @ 72" O.C.	#4 @ 72" O.C.	#4 @ 72" O.C.			
	6'	#4 @ 72" O.C.	#4 @ 72" O.C.	#5 @ 72" O.C.			
	7'	#4 @ 72" O.C.	#5 @ 72" O.C.	#6 @ 72" O.C.			
	8'	#5 @ 72" O.C.	#6 @ 72" O.C.	#6 @ 64" O.C.			
8'-8"	4' (OR LESS)	#4 @ 72" O.C.	#4 @ 72" O.C.	#4 @ 72" O.C.			
	5'	#4 @ 72" O.C.	#4 @ 72" O.C.	#4 @ 72" O.C.			
	6'	#4 @ 72" O.C.	#4 @ 72" O.C.	#5 @ 72" O.C.			
	7'	#4 @ 72" O.C.	#5 @ 72" O.C.	#6 @ 72" O.C.			
	8'-8"	#5 @ 72" O.C.	#7 @ 72" O.C.	#6 @ 48" O.C.			
9'-4"	4' (OR LESS)	#4 @ 72" O.C.	#4 @ 72" O.C.	#4 @ 72" O.C.			
	5'	#4 @ 72" O.C.	#4 @ 72" O.C.	#4 @ 72" O.C.			
	6'	#4 @ 72" O.C.	#5 @ 72" O.C.	#5 @ 72" O.C.			
	7'	#4 @ 72" O.C.	#5 @ 72" O.C.	#6 @ 72" O.C.			
	8'	#5 @ 72" O.C.	#6 @ 72" O.C.	#6 @ 56" O.C.			
	9'-4"	#6 @ 72" O.C.	#6 @ 48" O.C.	#6 @ 40" O.C.			
10'-0"	4' (OR LESS)	#4 @ 72" O.C.	#4 @ 72" O.C.	#4 @ 72" O.C.			
	5'	#4 @ 72" O.C.	#4 @ 72" O.C.	#4 @ 72" O.C.			
	6'	#4 @ 72" O.C.	#5 @ 72" O.C.	#5 @ 72" O.C.			
	7'	#4 @ 72" O.C.	#6 @ 72" O.C.	#6 @ 72" O.C.			
	8'	#5 @ 72" O.C.	#6 @ 72" O.C.	#6 @ 48" O.C.			
	9'	#6 @ 72" O.C.	#6 @ 56" O.C.	#6 @ 40" O.C.			
	10'	#6 @ 64" O.C.	#6 @ 40" O.C.	#6 @ 32" O.C.			

a. MORTAR SHALL BE TYPE M OR S AND MASONRY SHALL BE LAID IN RUNNING BOND. b. ALTERNATIVE REINFORCING BAR SIZES AND SPACINGS SHALL HAVE AN EQUIVALENT CROSS-SECTIONAL AREA OF REINFORCEMENT PER LINEAL FOOT OF WALL SHALL BE PERMITTED PROVIDED THE SPACING OF THE REINFORCEMENTDOES NOT EXCEED 72" IN SEISMIC DESIGN

CATEGORIES A, B AND C, AND 48 INCHES IN SEISMIC DESIGN CATEGORIES DO, D1 AND D2. c. VERTICAL REINFORCEMENT SHALL BE GRADE 60 MINIMUM. THE DISTANCE FROM THE FACE OF THE SOIL SIDE OF THE WALL TO THE CENTER OF VERTICAL REINFORCEMENT SHALL BE NOT LESS THAN 8.75 INCHES.

d. SOIL CLASSES ARE IN ACCORDANCE WITH THE UNIFIED SOIL CLASSIFICATION SYSTEM AND DESIGN LATERAL SOIL LOADS ARE FOR MOIST CONDITIONS WITHOUT HYDROSTATIC PRESSURE. REFER TO TABLE R405.1. e. UNBALANCED BACKFILL HEIGHT IS THE DIFFERENCE IN HEIGHT BETWEEN THE EXTERIOR FINISH GROUND LEVEL AND THE LOWER OF THE

TOP OF THE CONCRETE FOOTING THAT SUPPORTS THE FOUNDATION WALL OR THE INTERIOR FINISH GROUND LEVEL, WHERE AN INTERIOR CONCRETE SLAB-ON-GRADE IS PROVIDED AND IS IN CONTACT WITH THE INTERIOR SURFACE OF THE FOUNDATION WALL, MEASUREMENT OF THE UNBALANCED BACKFILL HEIGHT FROM THE EXTERIOR FINISH GROUND LEVEL TO THE TOP OF THE INTERIOR CONCRETE SLAB IS PERMITTED.

f. THE USE OF THIS TABLE SHALL BE PROHIBITED FOR SOIL CLASSIFICATIONS NOT SHOWN.

MAXIMUM UNBALANCED MAXIMUM WALL HEIGHT (FEET) (FEET) 4 NR 5 NR 4 NR 6 4 5 6 #4@ 6 #5 @ 8 #6@ 4 NR 5 NR 6 #4@ 7 #5 @ 8 #6@ 9 #6@ #5 @ #6 @ #6@ #6@ #6 @ 28" #6 @ 33" #6 @ 45" NR DR ^j #6 @ 23" #6 @ 29" #6 @ 38" DR #6 @ 22" #6 @ 22" #6 @ 22" #6 @ 22" #6 @ 28"

a. SOIL CLASSES ARE IN ACCORDANCE WITH THE UNIFIED SOIL CLASSIFICATION SYSTEM. REFER TO TABLE R405.1. b. TABLE VALUES ARE BASED ON REINFORCING BARS WITH A MINIMUM YEID STRENGTH OF 60,000 PSI c. VERTICAL REINFOREMENT WITH A YIELD STRENGTH OF LESS THAN 60,000 PSI AND / OR BARS OF A DIFFERENT SIZE THAN SPECIFIED IN THE TABLE ARE PERMITTED IN ACCORDANCE WITH SECTION R404.1.3.3.7.6 AND TABLE R404.1.2 (9) d. NR INDICATES NO VERTICAL WALL REINFORCEMENT IS REQUIRED, EXCEPT FOR 6-INCH NOMINAL WALLS FORMED WITH STAY-IN-PLACE FORMING SYSTEMS IN WHICH CASE VERTICAL REINFORCEMENT SHALL BE NO. 4 @ 48 INCHES ON CENTER. e. ALLOWABLE DEFLECTION CRITERION IS L/240, WHERE L IS THE UNSUPPORTED HEIGHT OF THE BASEMENT WALL IN INCHES. f. INTERPOLATION IS NOT PERMITTED.

g. WHERE WALLS WIL REMAIN 4 FEET OR MORE OF UNBALANCED BACKFILL, THEY SHALL BE LATERALLY SUPPORTED AT THE TOP AND BOTTOM BEFORE BACKFILLING. h. VERTICAL REINFORCEMENT SHALL BE LOCATED TO PROVIDE A COVER OF 1 1/4 INCHES MEASURED FROM THE INSIDE FACE OF THE WALL. THE CENTER OF THE STEEL SHALL NOT VARY FROM THE SPECIFIED LOCATION BY MORE THAN THE GREATER OF 10 PERCENT OF THE WALL THICKNESS OR 3/8 INCH. i. CONCRETE COVER FOR THE REINFORCEMENT MEASURE FROM THE INSIDE FACE OF THE WALL SHALL BE NOT LESS THAN 3/4 INCH. CONCRETE COVER FOR REINFORCEMENT MEASURED FROM THE OUTSIDE FACE OF THE WALL SHALL BE NOT LESS THAN 1 1/2 INCHES FOR NO. 5 BARS AND SMALLER, AND NOT LESS THAN 2 INCHES FOR LARGER BARS. j. DR MEANS DESIGN IS REQUIRED IN ACCORDANCE WITH THE APPLICABLE BUILDING CODE, OR WHERE THERE IS NO CODE, IN ACCORDANCE WITH ACI 318. K. CONCRETE SHALL HAVE A SPECIFIED COMPRESSIVE STRENGTH, fc OF NOT LESS THAN 2,500 PSI AT 28 DAYS, UNLESS A HIGHER STRENGTH IS REQUIRED BY FOOTNOTE 1 OR m. I. THE MINIMUM THICKNESS IS PERMITTED TO BE REDUCED 2 INCHES, PROVIDED THE MINIMUM SPECIFIED COMPRESSIVE STRENGTH OF CONCRETE, fc IS 4,000 PSI. m. A PLAIN CONCRETE WALL WITH A MINIMUM NOMINAL THICKNESS OF 12 INCHES IS PERMITTED, PROVIDED MINIMUM SPECIFIED COMPRESSIVE STRENGTH OF CONCRETE, fc IS 3,500 PSI.

ON

N CRITERIA 1E WALLS ≷ FRAMED NTACT ARRIER. INSTALLED JNDERSIDE CAVITY NTACT WITH **SINSULATION**

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R401.4 SOIL TESTS

WHERE QUANTIFIABLE DATA CREATED BY ACCEPTED SOIL SCIENCE METHODOLOGIES INDICATE EXPANSIVE, COMPESSIBLE, SHIFTING OR OTHER QUESTIONABLE SOIL CHARACTERISTICS ARE LIKELY TO BE PRESENT, THE BUILDING OFFICIAL SHALL DETERMINE WHETHER TO REQUIRE A SOIL TEST TO DETERMINE THE SOIL'S CHARACTERISTICS AT A PARTICULAR LOCATION. THIS TEST BE DONE BY AN APPROVED AGENCY USING AN APPROVED METHOD.

R401.4.1 GEOTECHNICAL EVALUATION. IN LIEU OF A COMPLETE GEOTECHNICAL EVALUATION, THE LOAD-BEARING VALUES IN TABLE R401.4.1

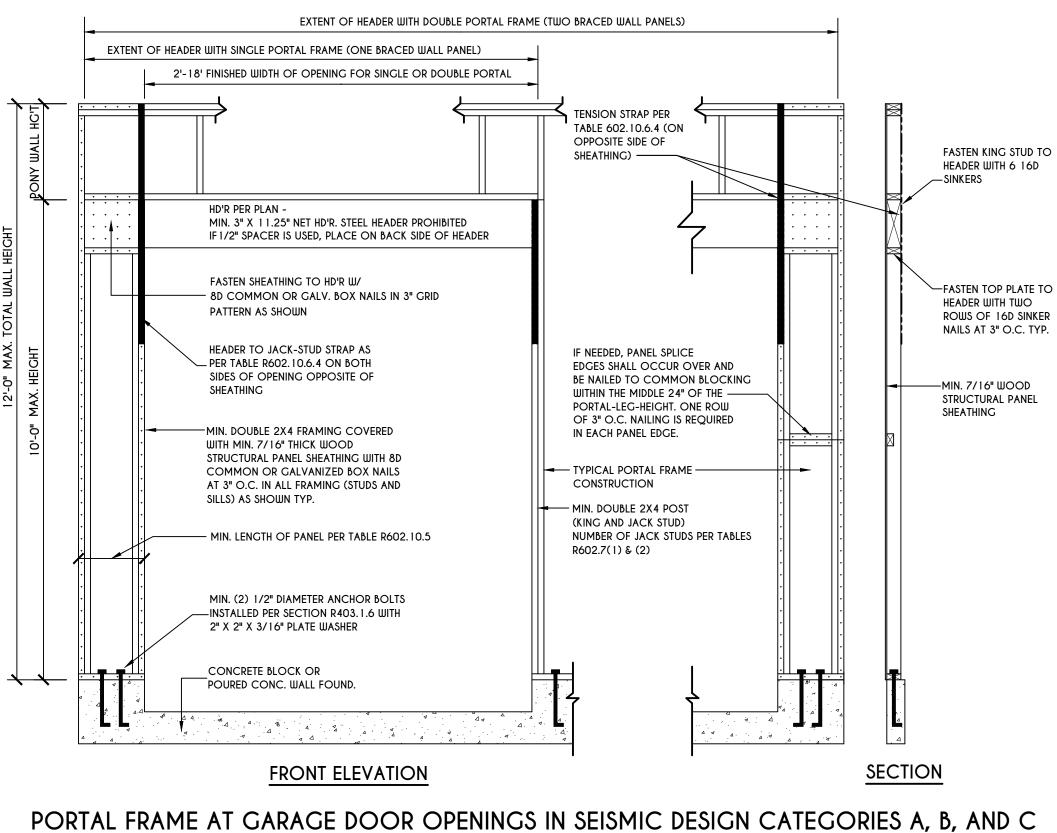
SHALL BE ASSUMED. TABLE R401.4.1

PRESUMPTIVE LOAD-BEARING VALUES	OF FOUNDATION MATERIALS
CLASS OF MATERIALS	LOAD-BEARING PRESSURE (pounds per square foot)
CRYSTALLINE BEDROCK	12,000
SEDIMENTARY & FOLIATED ROCK	4,000
SANDY GRAVEL AND/OR GRAVEL (GW & GP)	3,000
SAND, SILTY SAND, CLAYEY SAND, SILTY GRAVEL, AND CLAYEY GRAVEL (SW, SP, SM, SC, GM, & GC)	2,000
CLAY, SANDY CLAY, SILTY CLAY, CLAYEY SILT, SILT AND SANDY SILT (CL, ML, MH, & CH)	1,500 ^b

a. WHERE SOIL TESTS ARE REQUIRED BY SECTION R401.4, THE ALLOWABLE BEARING CAPACITIES OF THE SOIL SHALL BE PART OF THE RECOMMENDATIONS. b. WHERE THE BUILDING OFFICIAL DETERMINES THAT IN-PLACE SOILS WITH AN ALLOWABLE BEARING CAPACITY OF LESS THAN 1,500 psf ARE LIKELY TO BE PRESENT AT THE SITE, THE ALLOWABLE BEARING CAPACITY SHALL BE DETERMINED BY A SOILS INVESTIGATION.

UNIFIED SOIL CLASSIFICATION SYSTEM UNIFIED SOIL

CLASSIFICATION	
GΨ	WELL-GRADED GRAVELS, GRAVEL SAND MIXTURES, LITTLE OR NO FINES
GP	POORLY GRADED GRAVELS OR GRAVEL SAND, LITTLE OR NO FINES
SW	WELL-GRADED SANDS, GRAVELLY SANDS, LITTLE OR NO FINES
SP	POORLY GRADED SANDS OR GRAVELLY SANDS, LITTLE OR NO FINES
GM	SILTY GRAVELS, GRAVEL-SAND-SILT MIXTURES
SM	SILTY SAND, SAND-SILT MIXTURES
CC	CLAYEY GRAVELS, GRAVEL-SAND-CLAY MIXTURES
SC	CLAYEY SANDS, SAND-CLAY MIXTURE MIXTURES
ML	INORGANIC SILTS & VERY FINE SANDS, ROCK FLOUR, SILTY OR CLAYEY FINE SANDS OR CLAYEY SILTS WITH SLIGHT PLASTICITY
CL	INORGANIC CLAYS OF LOW TO MEDIUM PLASTICITY, GRAVELLY CLAYS, SANDY CLAYS, SILTY CLAYS, LEAN CLAYS
СН	INORGANIC CLAYS OF HIGH PLASTICITY, FAT CLAYS
МН	INORGANIC SILTS, MICACEOUS OR DIATOMACEOUS FINE SANDY OR SILTY SOILS, ELASTIC SILTS
OL	ORGANIC SILTS & ORGANIC SILTY CLAYS OF LOW PLASTICITY
ОН	ORGANIC CLAYS OF MEDIUM TO HIGH PLASTICITY, ORGANIC SILTS
PT	PEAT & OTHER HIGHLY ORGANIC SOILS



SCALE: N.T.S. FIGURE R602.10.6.3


TABLE R404.1.1(4)

TABLE R404.1.2(8)

MINIMUM VERTICAL REINFORCEMENT FOR 6-, 8-, 10- AND 12-INCH NOMINAL FLAT BASEMENT WALLS b, c, d, e, f, h, i, k, n, o MINIMUM VERTICAL REINFORCEMENT-BAR SIZE & SPACING (inches) SOIL CLASSES AND DESIGN LATERAL SOIL (psf PER FOOT OF DEPTH)

G	Ш, GP, SШ, Л 30			GM,	, GS, SM-SC 45	C AND ML		SC, MH, M	L-CL AND II 60	NORGANIC	CL
	30		IMIM	L UM WALL TH		INCHES)			00		
	8	10	12	6	8	10	12	6	8	10	12
	NR	NR	NR	NR	NR	NR	NR	NR	NR	NR	NR
	NR	NR	NR	NR	NR	NR	NR	NR	NR	NR	NR
	NR	NR	NR	NR	NR	NR	NR	NR	NR	NR	NR
	NR	NR	NR	NR	NR ¹	NR	NR	#4@35"	NR ¹	NR	NR
	NR	NR	NR	#5@48"	NR	NR	NR	#5 @ 36"	NR	NR	NR
	NR	NR	NR	NR	NR	NR	NR	NR	NR	NR	NR
	NR	NR	NR	NR	NR	NR	NR	#5@47"	NR	NR	NR
	NR	NR	NR	#5@42"	NR	NR	NR	#6 @ 43"	#5@48"	NR ¹	NR
» 46"	NR	NR	NR	#6@42"	#5@46"	NR ¹	NR	#6@34"	#6@48"	NR	NR
	NR	NR	NR	NR	NR	NR	NR	NR	NR	NR	NR
	NR	NR	NR	#4@38"	NR ¹	NR	NR	#5 @ 43"	NR	NR	NR
» 37"	NR ¹	NR	NR	#5 @ 37"	NR	NR	NR	#6 @ 37"	#5@43"	NR ¹	NR
» 40"	NR	NR	NR	#6 @ 37"	#5@41"	NR ¹	NR	#6@34"	#6@43"	NR	NR
¢43"	#5@47"	NR ¹	NR	#6@34"	#6@43"	NR	NR	#6@27"	#6@32"	#6@44"	NR
	NR	NR	NR	NR	NR	NR	NR	NR	NR	NR	NR
	NR	NR	NR	#4@35"	NR ¹	NR	NR	#5@40"	NR	NR	NR
≥34"	NR ¹	NR	NR	#6@48"	NR	NR	NR	#6 @ 36"	#6@39"	NR ¹	NR
» 36"	NR	NR	NR	#6@34"	#5 @ 37"	NR	NR	#6 @ 33"	#6@38"	# 5 @ 37"	NR ¹
» 38"	#5@41"	NR	NR	#6@33"	#6 @ 38"	#5 @ 37"	NR ¹	#6@24"	#6@29"	#6@39"	#4 @ 48"
» 34"	#6@46"	NR	NR	#6 @ 26"	#6@30"	#6@41"	NR	#6@19"	#6@23"	#6 @ 30"	#6 @ 39"
	NR	NR	NR	NR	NR	NR	NR	NR	NR	NR	NR
	NR	NR	NR	#4@33"	NR ¹	NR	NR	#5 @ 38"	NR	NR	NR
≥ 48 "	NR ¹	NR	NR	#6 @ 45"	NR	NR	NR	#6@34"	#5 @ 37"	NR	NR
» 47"	NR	NR	NR	#6@34"	#6 @ 48"	NR	NR	#6 @ 30"	#6 @ 35"	#6@48"	NR ¹
» 34"	#5@38"	NR	NR	#6@30"	#6@34"	#6@47"	NR ¹	#6@22"	#6 @ 26"	#6 @ 35"	#6@45"
> 34"	#6@41"	#4@48"	NR ¹	#6@23"	#6@27"	#6 @ 35"	#4 @48" ^m	DR	#6 @ 22"	#6 @ 27"	#6@34"

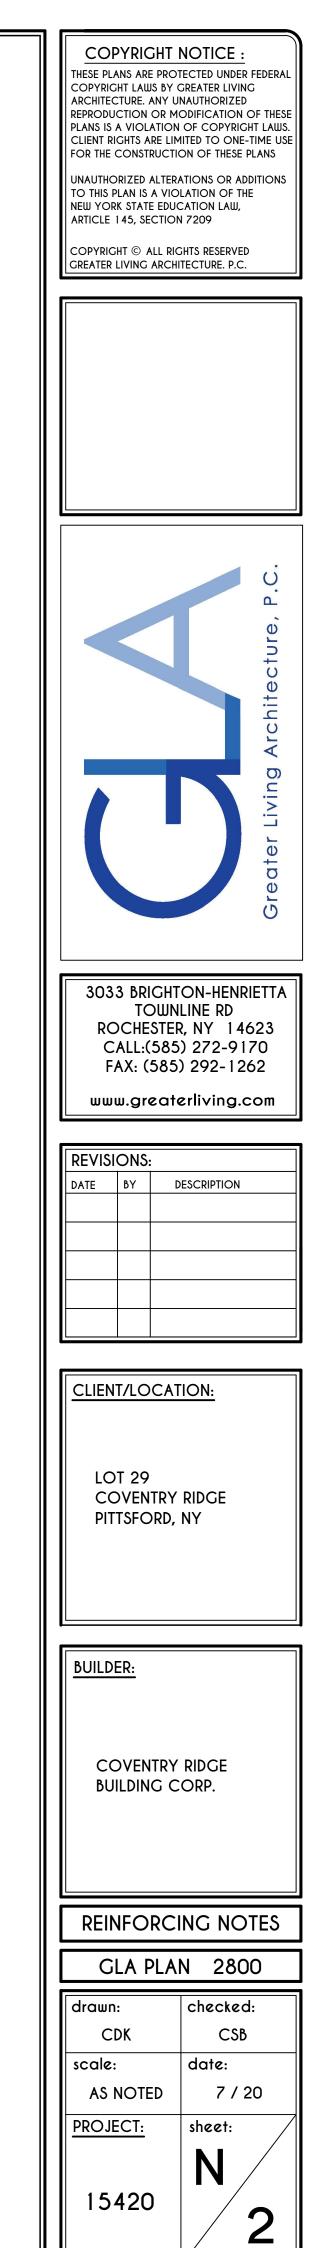n. SEE TABLE R608.3 FOR TOLERANCE FROM NOMINAL THICKNESS PERMITTED FOR FLAT WALLS. o. THE USE OF THIS TABLE SHALL BE PROHIBITED FOR SOIL CLASSIFICATIONS NOT SHOWN.











Town of Pittsford

Department of Public Works 11 South Main Street Pittsford, New York 14534

Permit # B20-000094

Phone: 585-248-6250 FAX: 585-248-6262

DESIGN REVIEW AND HISTORIC PRESERVATION BOARD REFERRAL OF APPLICATION

Property Address: 4 San Rafael Drive ROCHESTER, NY 14618 Tax ID Number: 151.06-1-17 Zoning District: RN Residential Neighborhood Owner: Krapf, Christian Applicant: Krapf, Christian

Application Type:

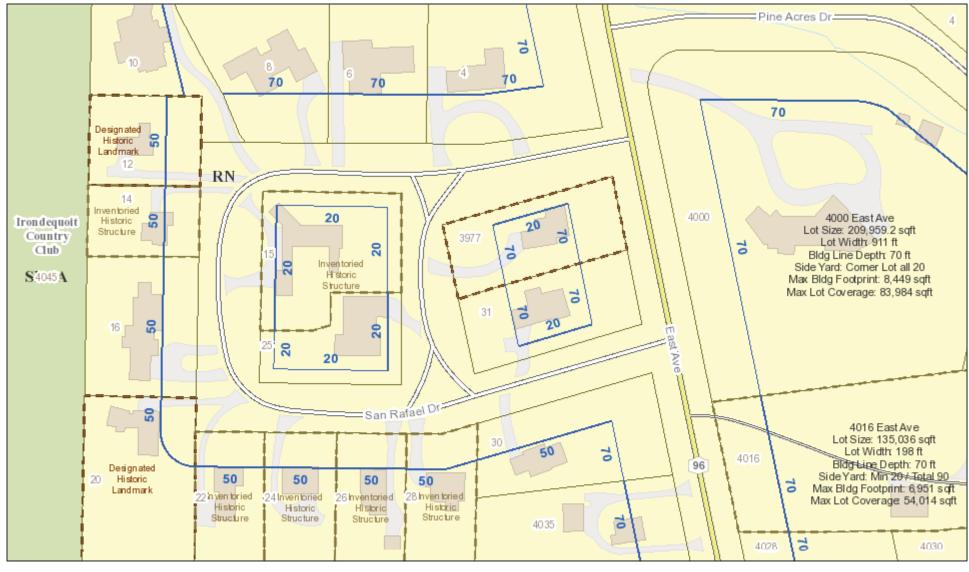
- Residential Design Review §185-205 (B)
- Commercial Design Review §185-205 (B)
- Signage
- §185-205 (C)
- Certificate of Áppropriateness §185-197
- Landmark Designation
- §185-195 (2)
- Informal Review

- Build to Line Adjustment §185-17 (B) (2)
- Building Height Above 30 Feet §185-17 (M)
- Corner Lot Orientation
- §185-17 (K) (3)
- Flag Lot Building Line Location §185-17 (L) (1) (c)
- Undeveloped Flag Lot Requirements §185-17 (L) (2)
- 9185-17 (L) (Z)


Project Description: Applicant is requesting design and review for the construction of a new single family home. The home will be approximately 6440 sq. ft. of livable space and will be located on a vacant lot in the San Rafael Drive neighborhood.

Meeting Date: July 23, 2020

RN Residential Neighborhood Zoning




Printed July 30, 2019

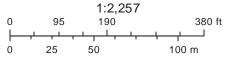

Town of Pittsford GIS

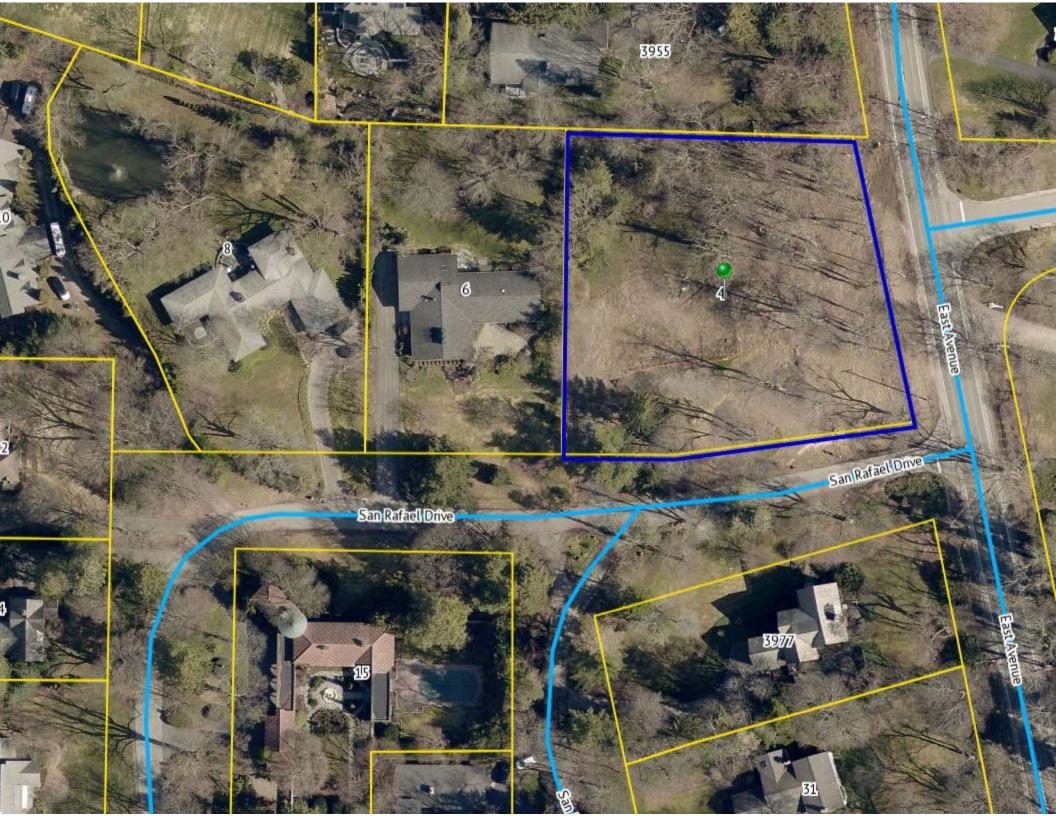The information depicted on this map is representational and should be used for general reference purposes only. No warranties, expressed or implied, are provided for the data or its use or interpretation.



C C H R I S T O P H E R

ARCHITECTURE & INTERIORS

KRAPF RESIDENCE

Photos of Construction Site June 12, 2020



VIEW FROM SOUTH EASTERN CORNER



VIEW FROM NORTH EASTERN CORNER



VIEW FROM SOUTH WESTERN CORNER



VIEW DOWN SAN RAFAEL DRIVE



VIEW DOWN EAST AVENUE

CHRISTOPHER ARCHITECTURE & INTERIORS

Drawing Index

A0.0	COVER SHEET
A1.0	SITE PLAN
A2.1 A2.2	FIRST FLOOR PLAN BASEMENT & SECOND FLOOR PLANS
A3.1 A3.2 A3.3 A3.4	ELEVATIONS ELEVATIONS ELEVATIONS ELEVATIONS
A4.1	SECTIONS

Krapf Residence

lssue: 06/12/2020

4 San Rafael Drive Rochester, New York 14618

Project Information

Owner: Christian & Christina Krapf Architect: Christopher Architecture & Interiors Contact: Chris Reebals Ria Neill Interior Designer: Christopher Architecture & Interiors Contact: Joanna Goodman 2601 Highland Avenue Birmingham, Alabama 35205 (205)-413-8531 Square Footages Heated/Cooled Total: 6,440sf Basement Level: 900 sf 5,183 sf Ground Level: 357 sf Upper Level: 1,133 sf Unconditioned Total: Patios: 644 sf Trellis: 402sf 98sf Spa: Total Design SF: 7,574sf

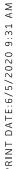
Applicable Codes: 2017 International Residential Code

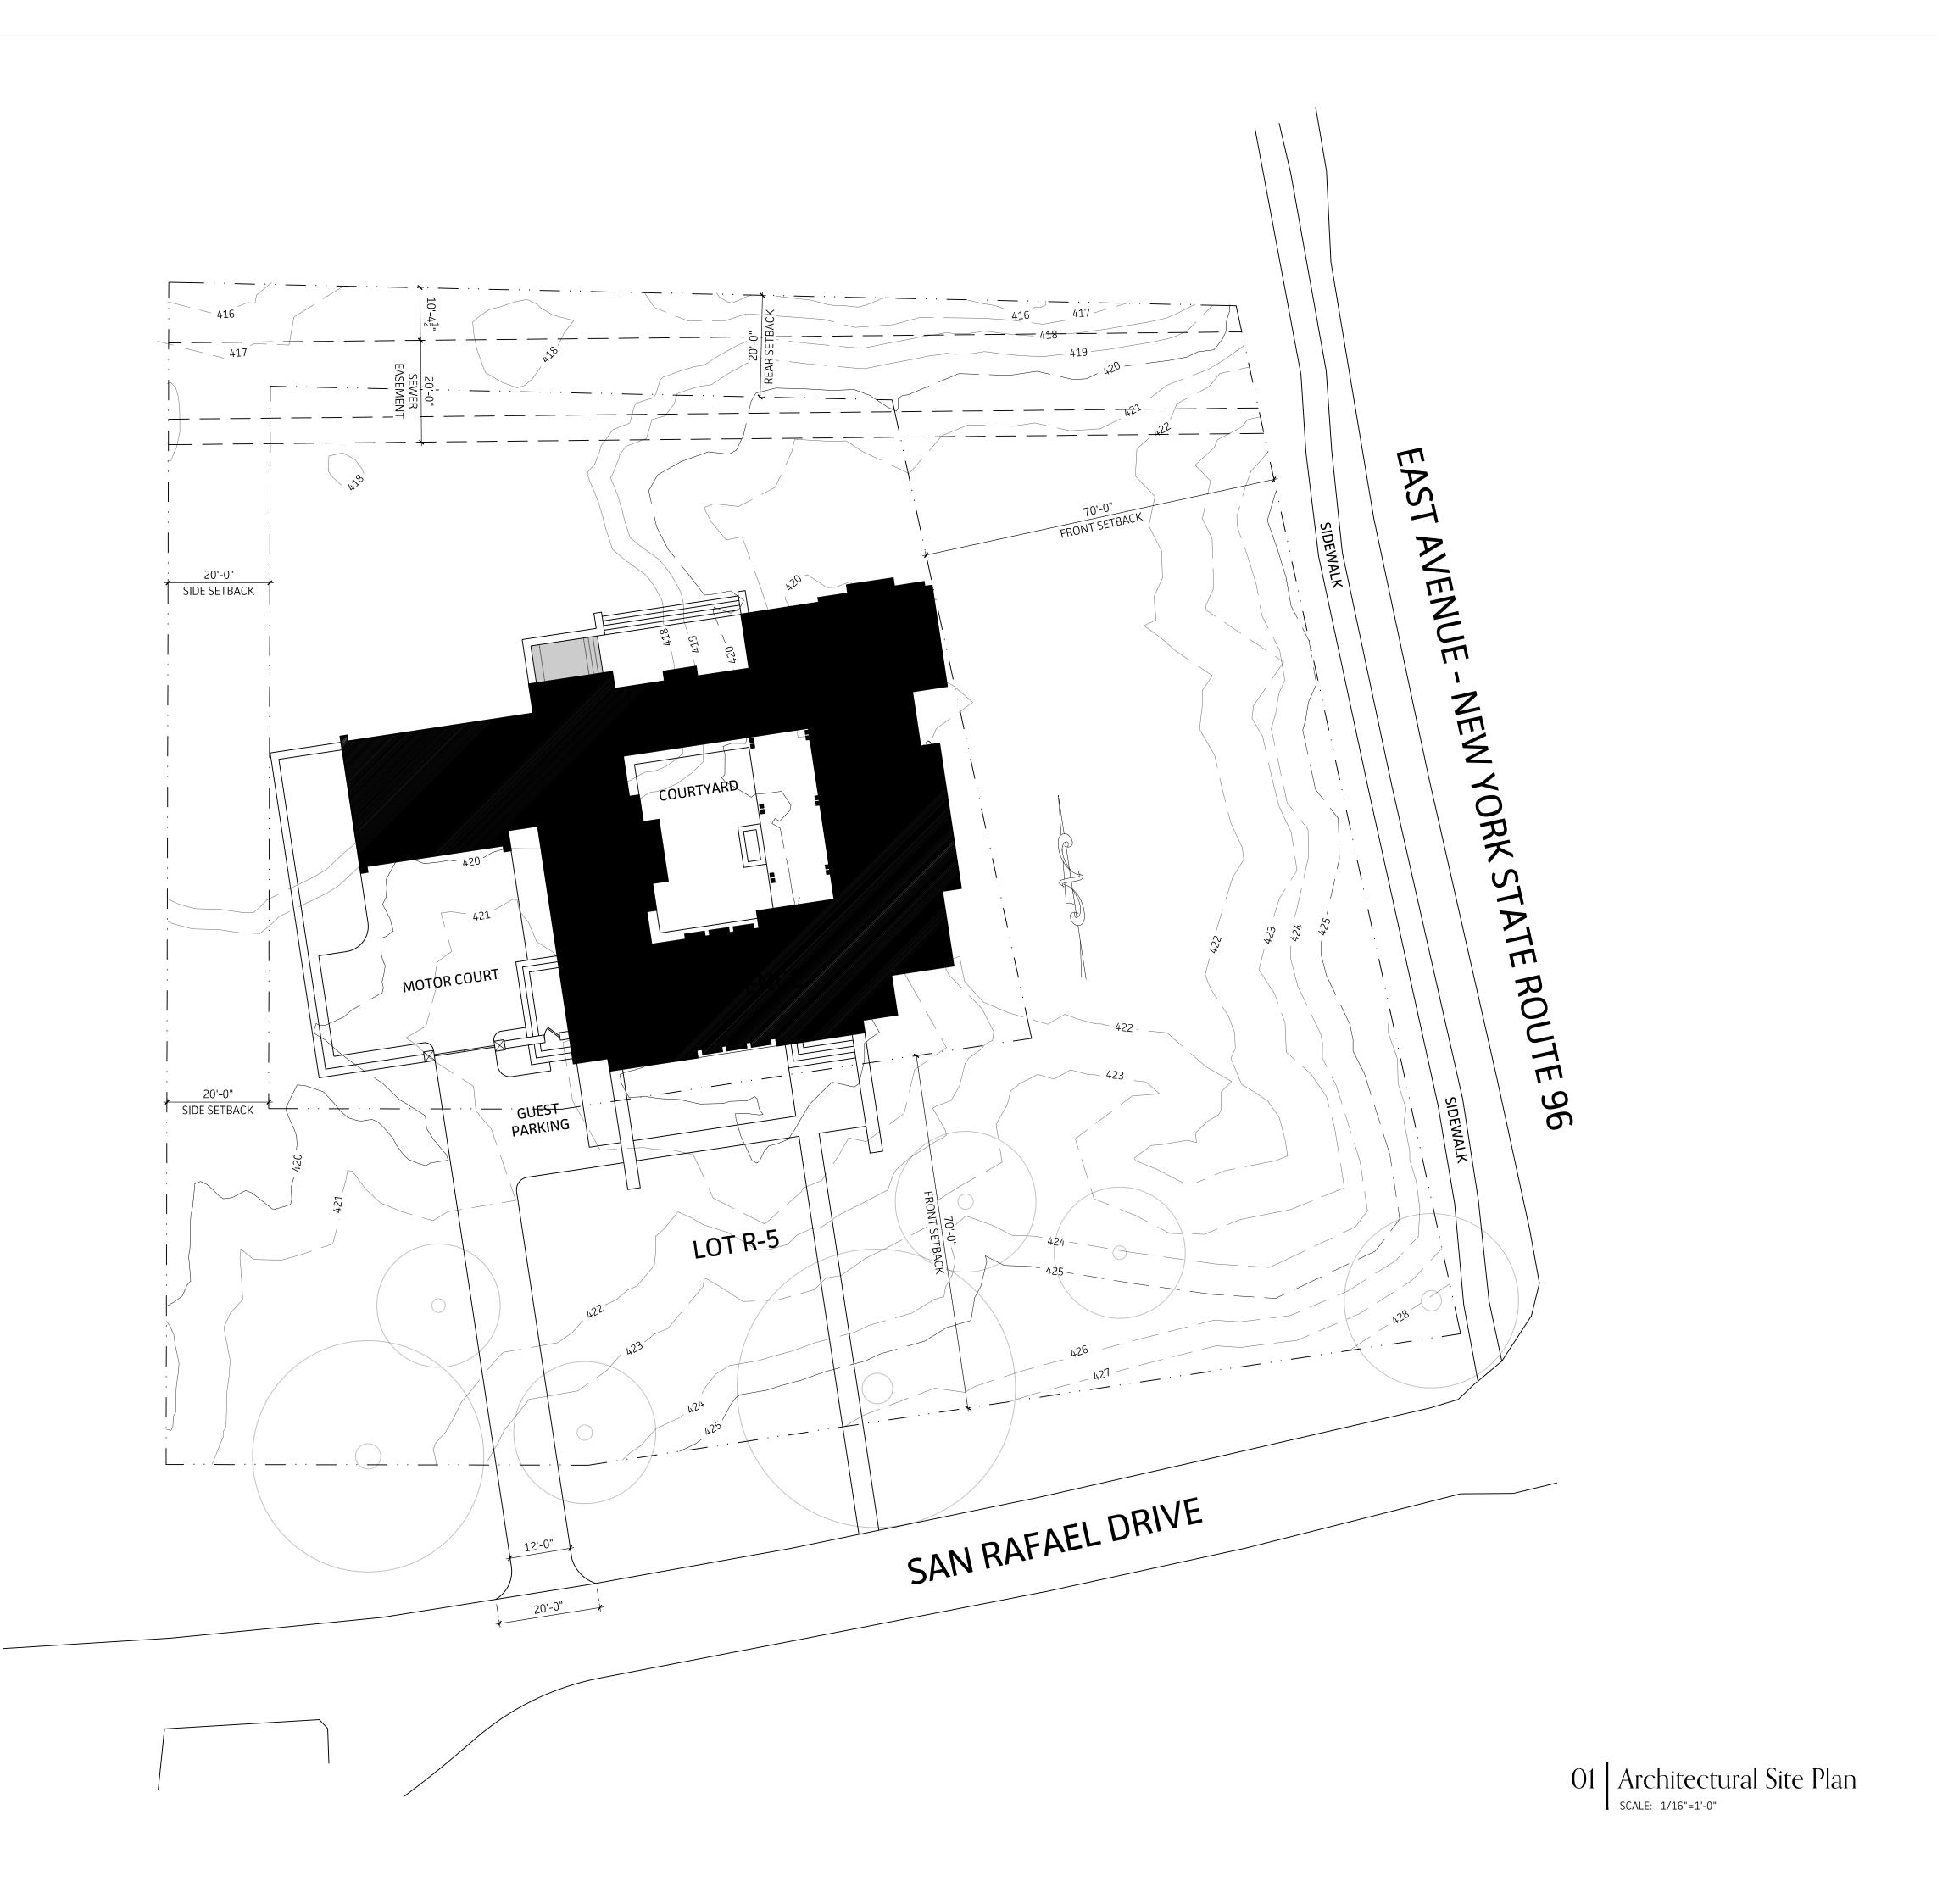
Design Review and Historic Preservation Set












Krapf Residence 4 San Rafael Drive Rochester, New York 14618

^{date} 06/12/2020 јов no. 19014

drawn by RN checked by CR/JG

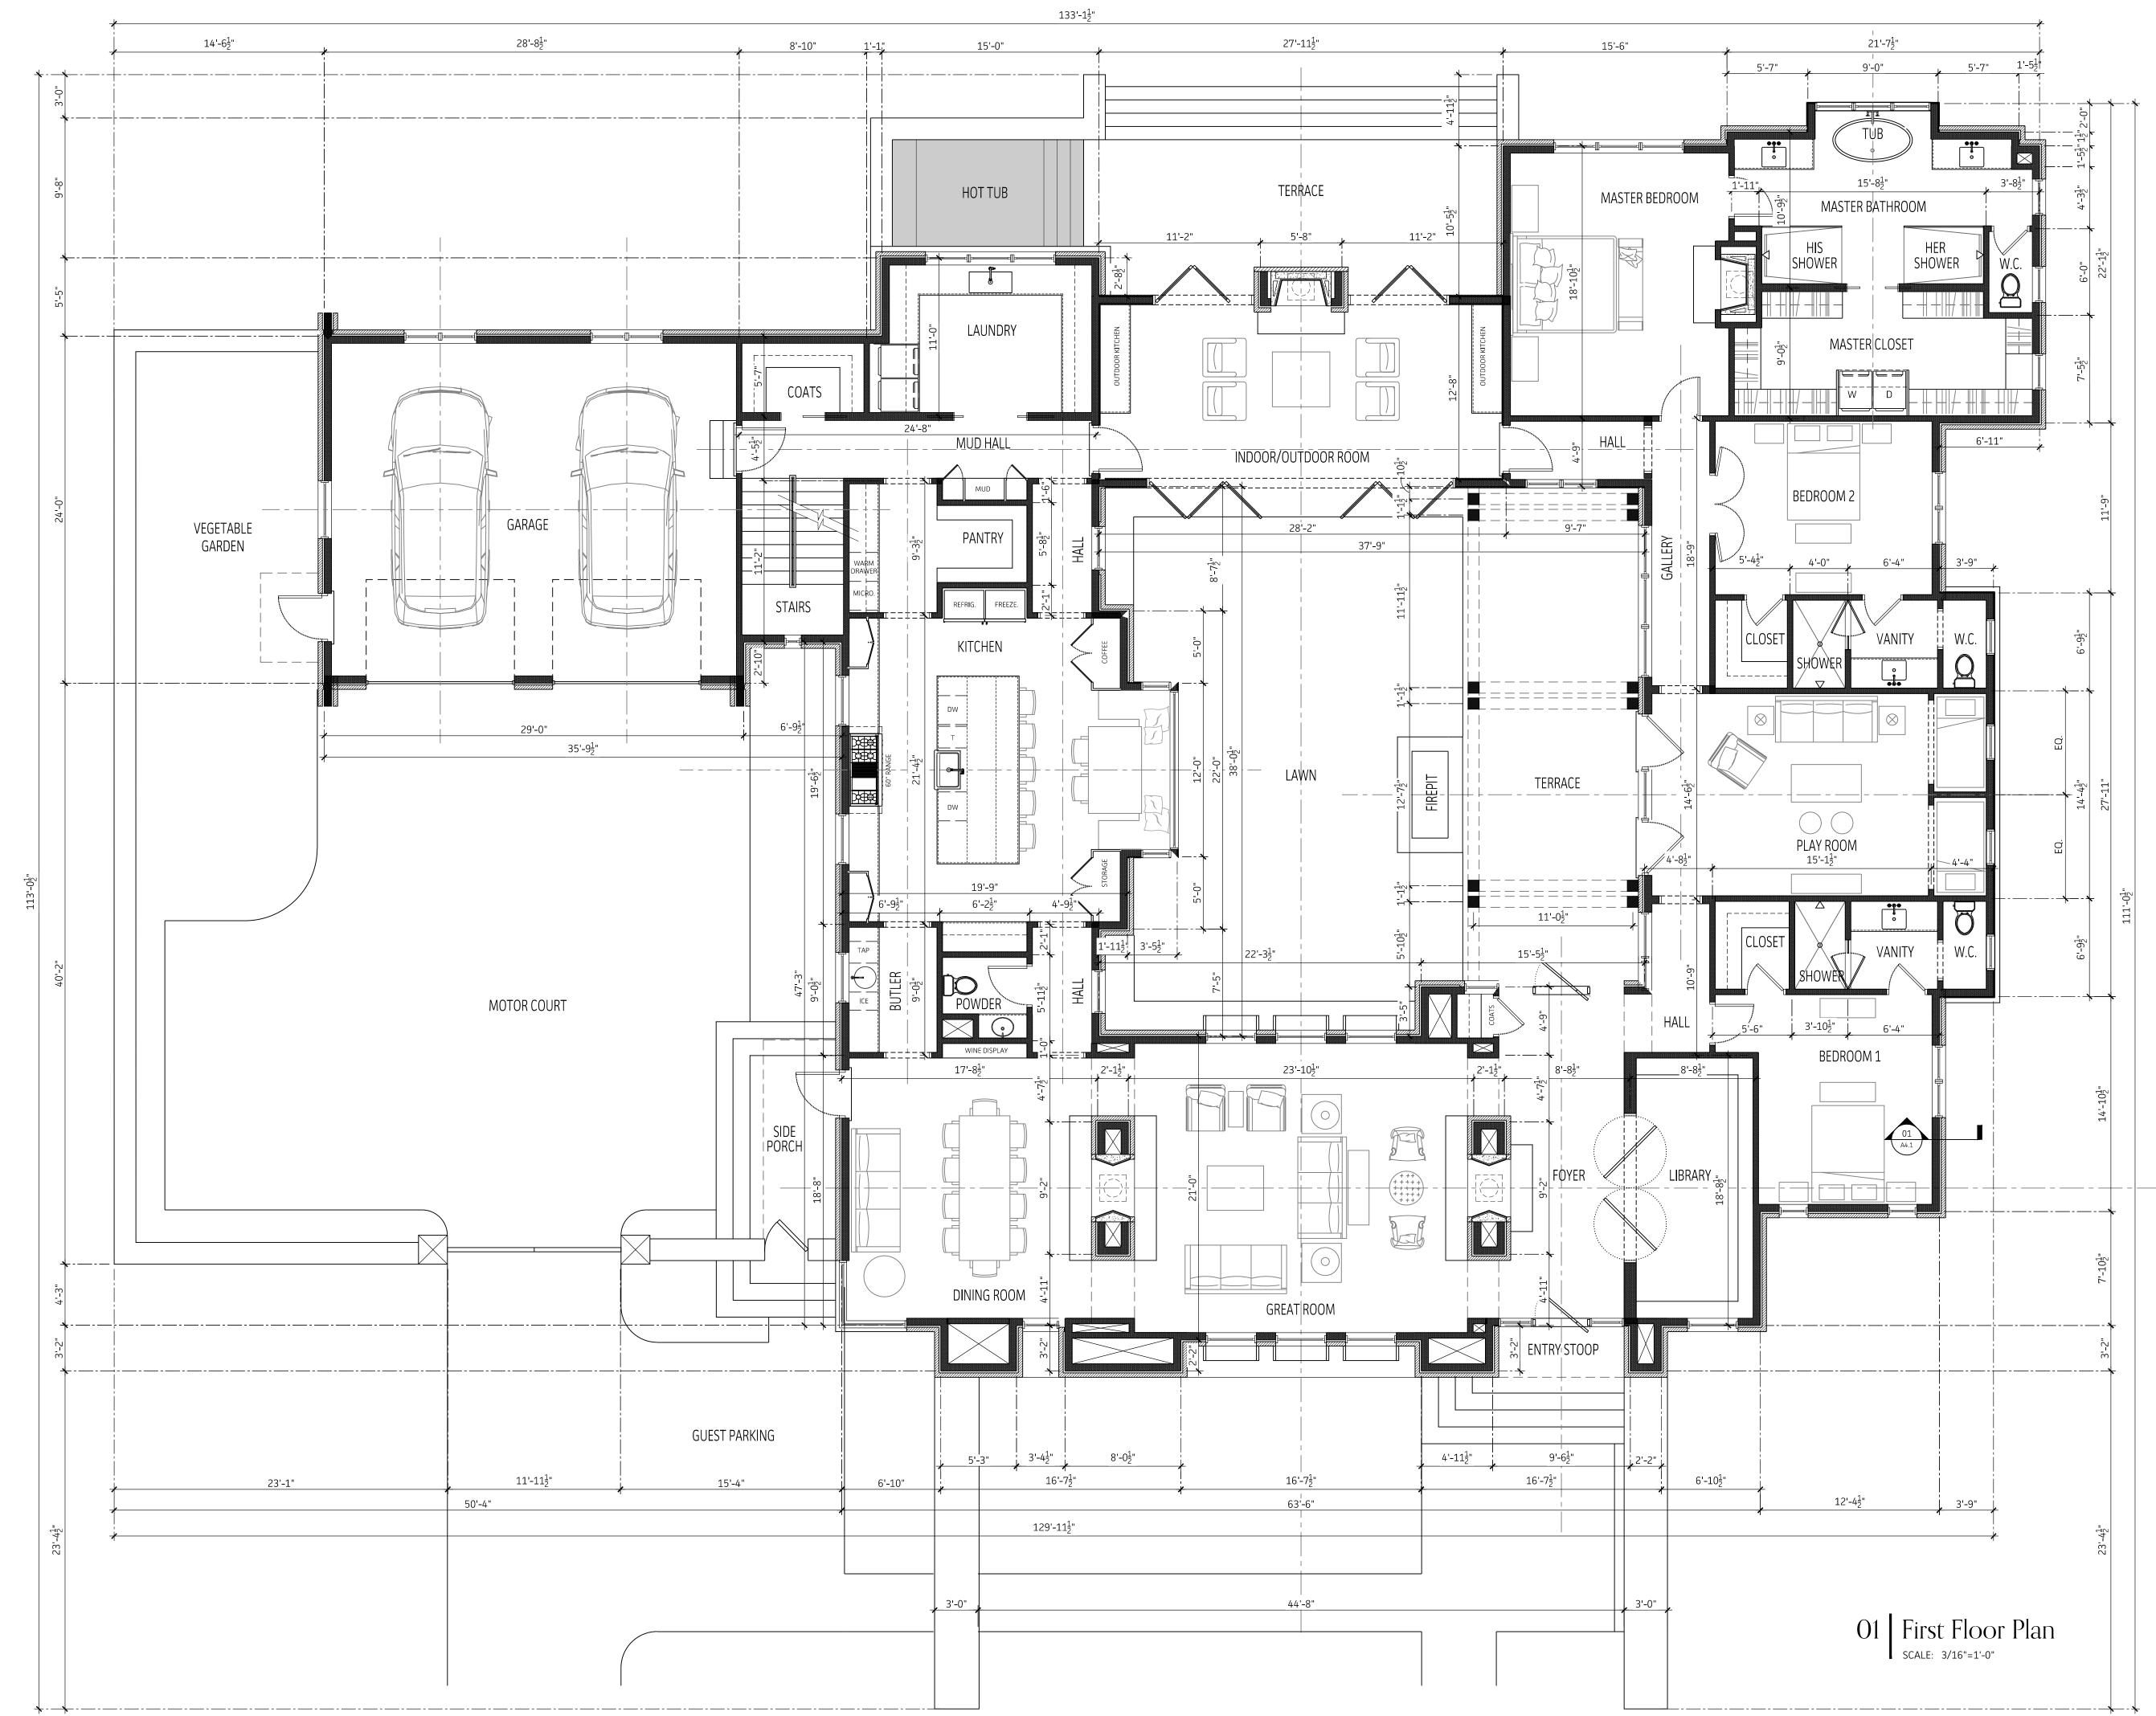
SHEET TITLE SITE PLAN A1.0




NOT FOR CONSTRUCTION Krapf Residence 4 San Rafael Drive Rochester, New York 14618 drawn by **RN** ^{date} 06/12/2020 јов no. **19014** снескед ву CR/JG

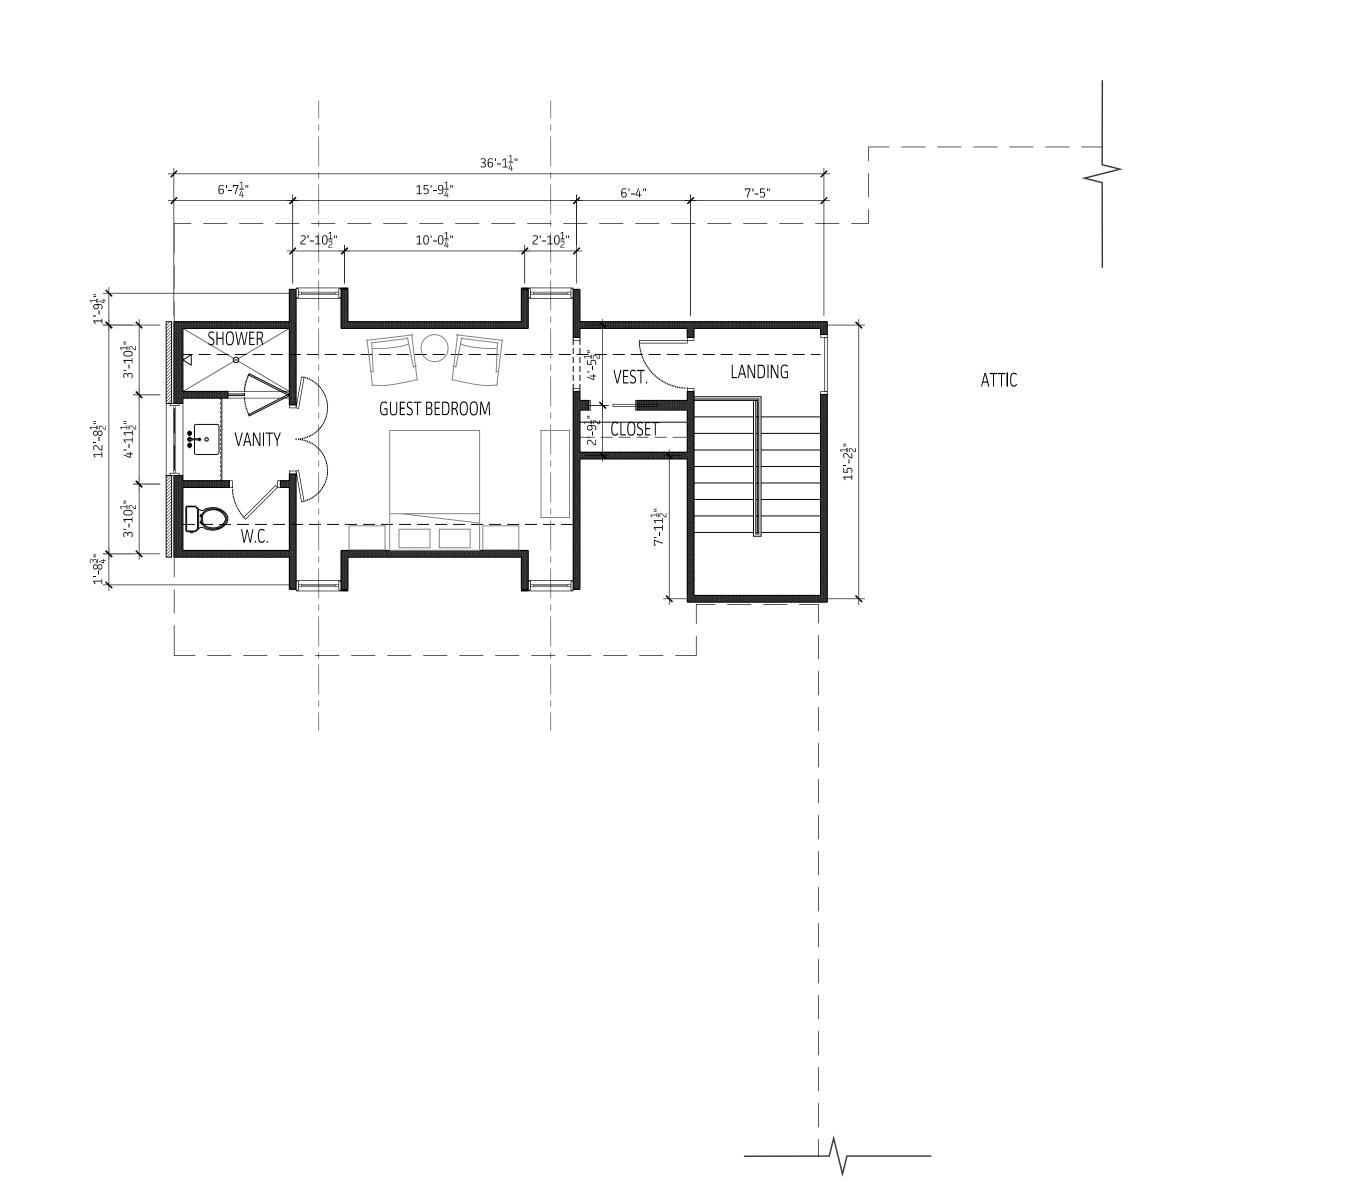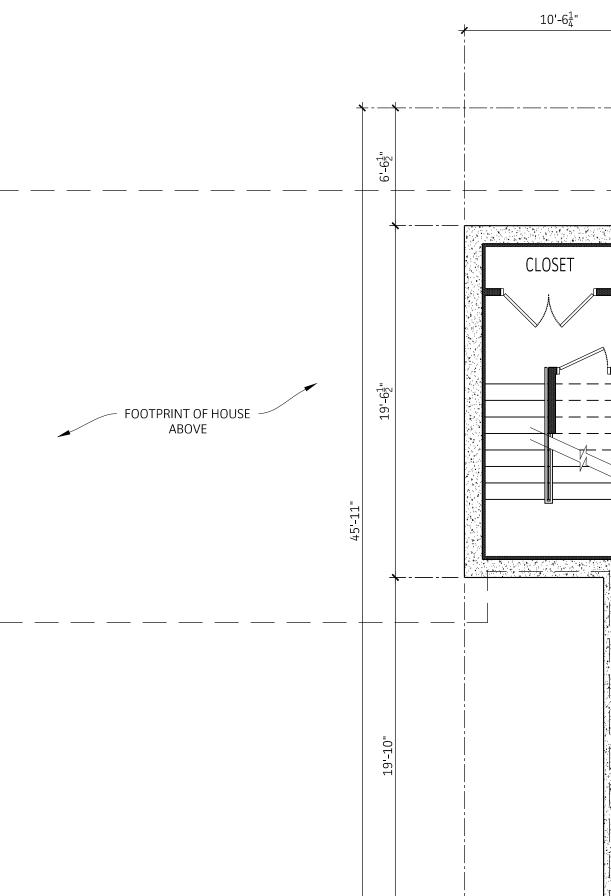SHEET TITLE FIRST FLOOR PLAN








02 Second Floor Plan SCALE: 3/16"=1'-0"



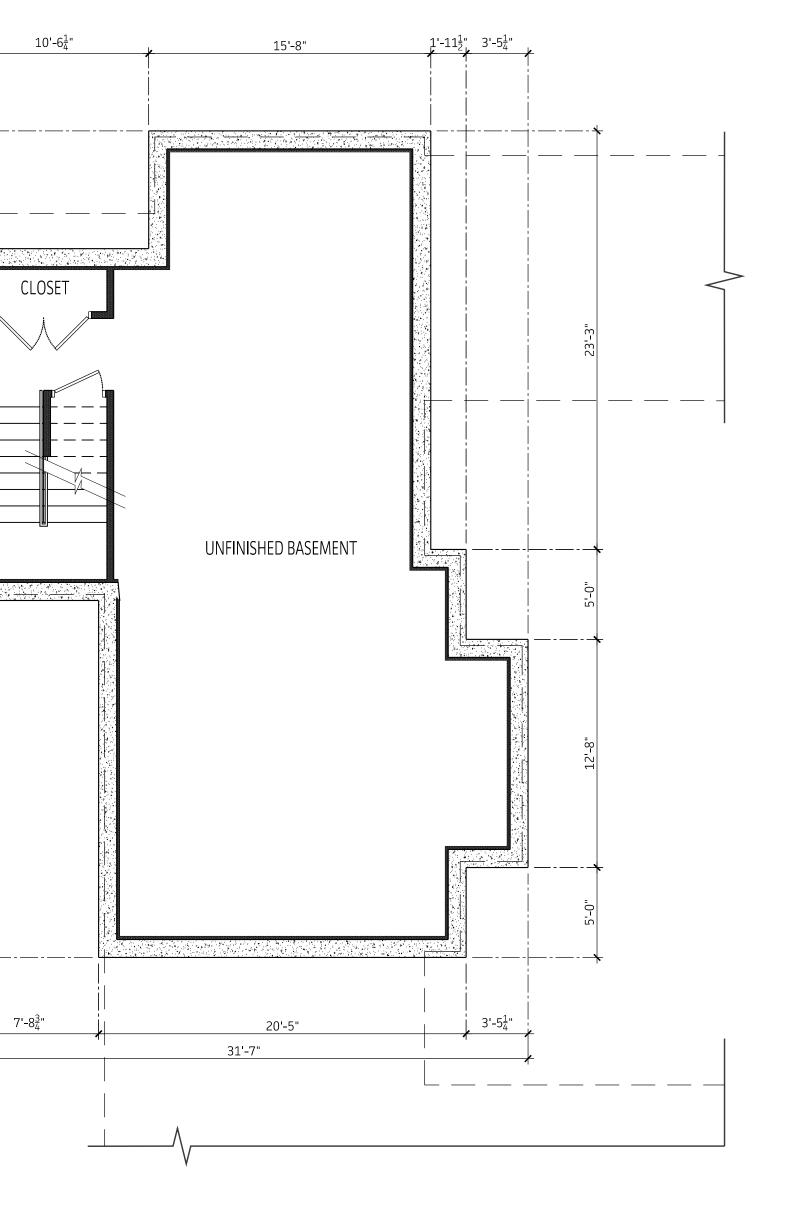

O1 Basement Floor Plan










Krapf Residence 4 San Rafael Drive Rochester, New York 14618


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јов no. 19014	

drawn by RN снескед вү CR/JG

SHEET TITLE

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Krapf Residence 4 San Rafael Drive Rochester, New York 14618

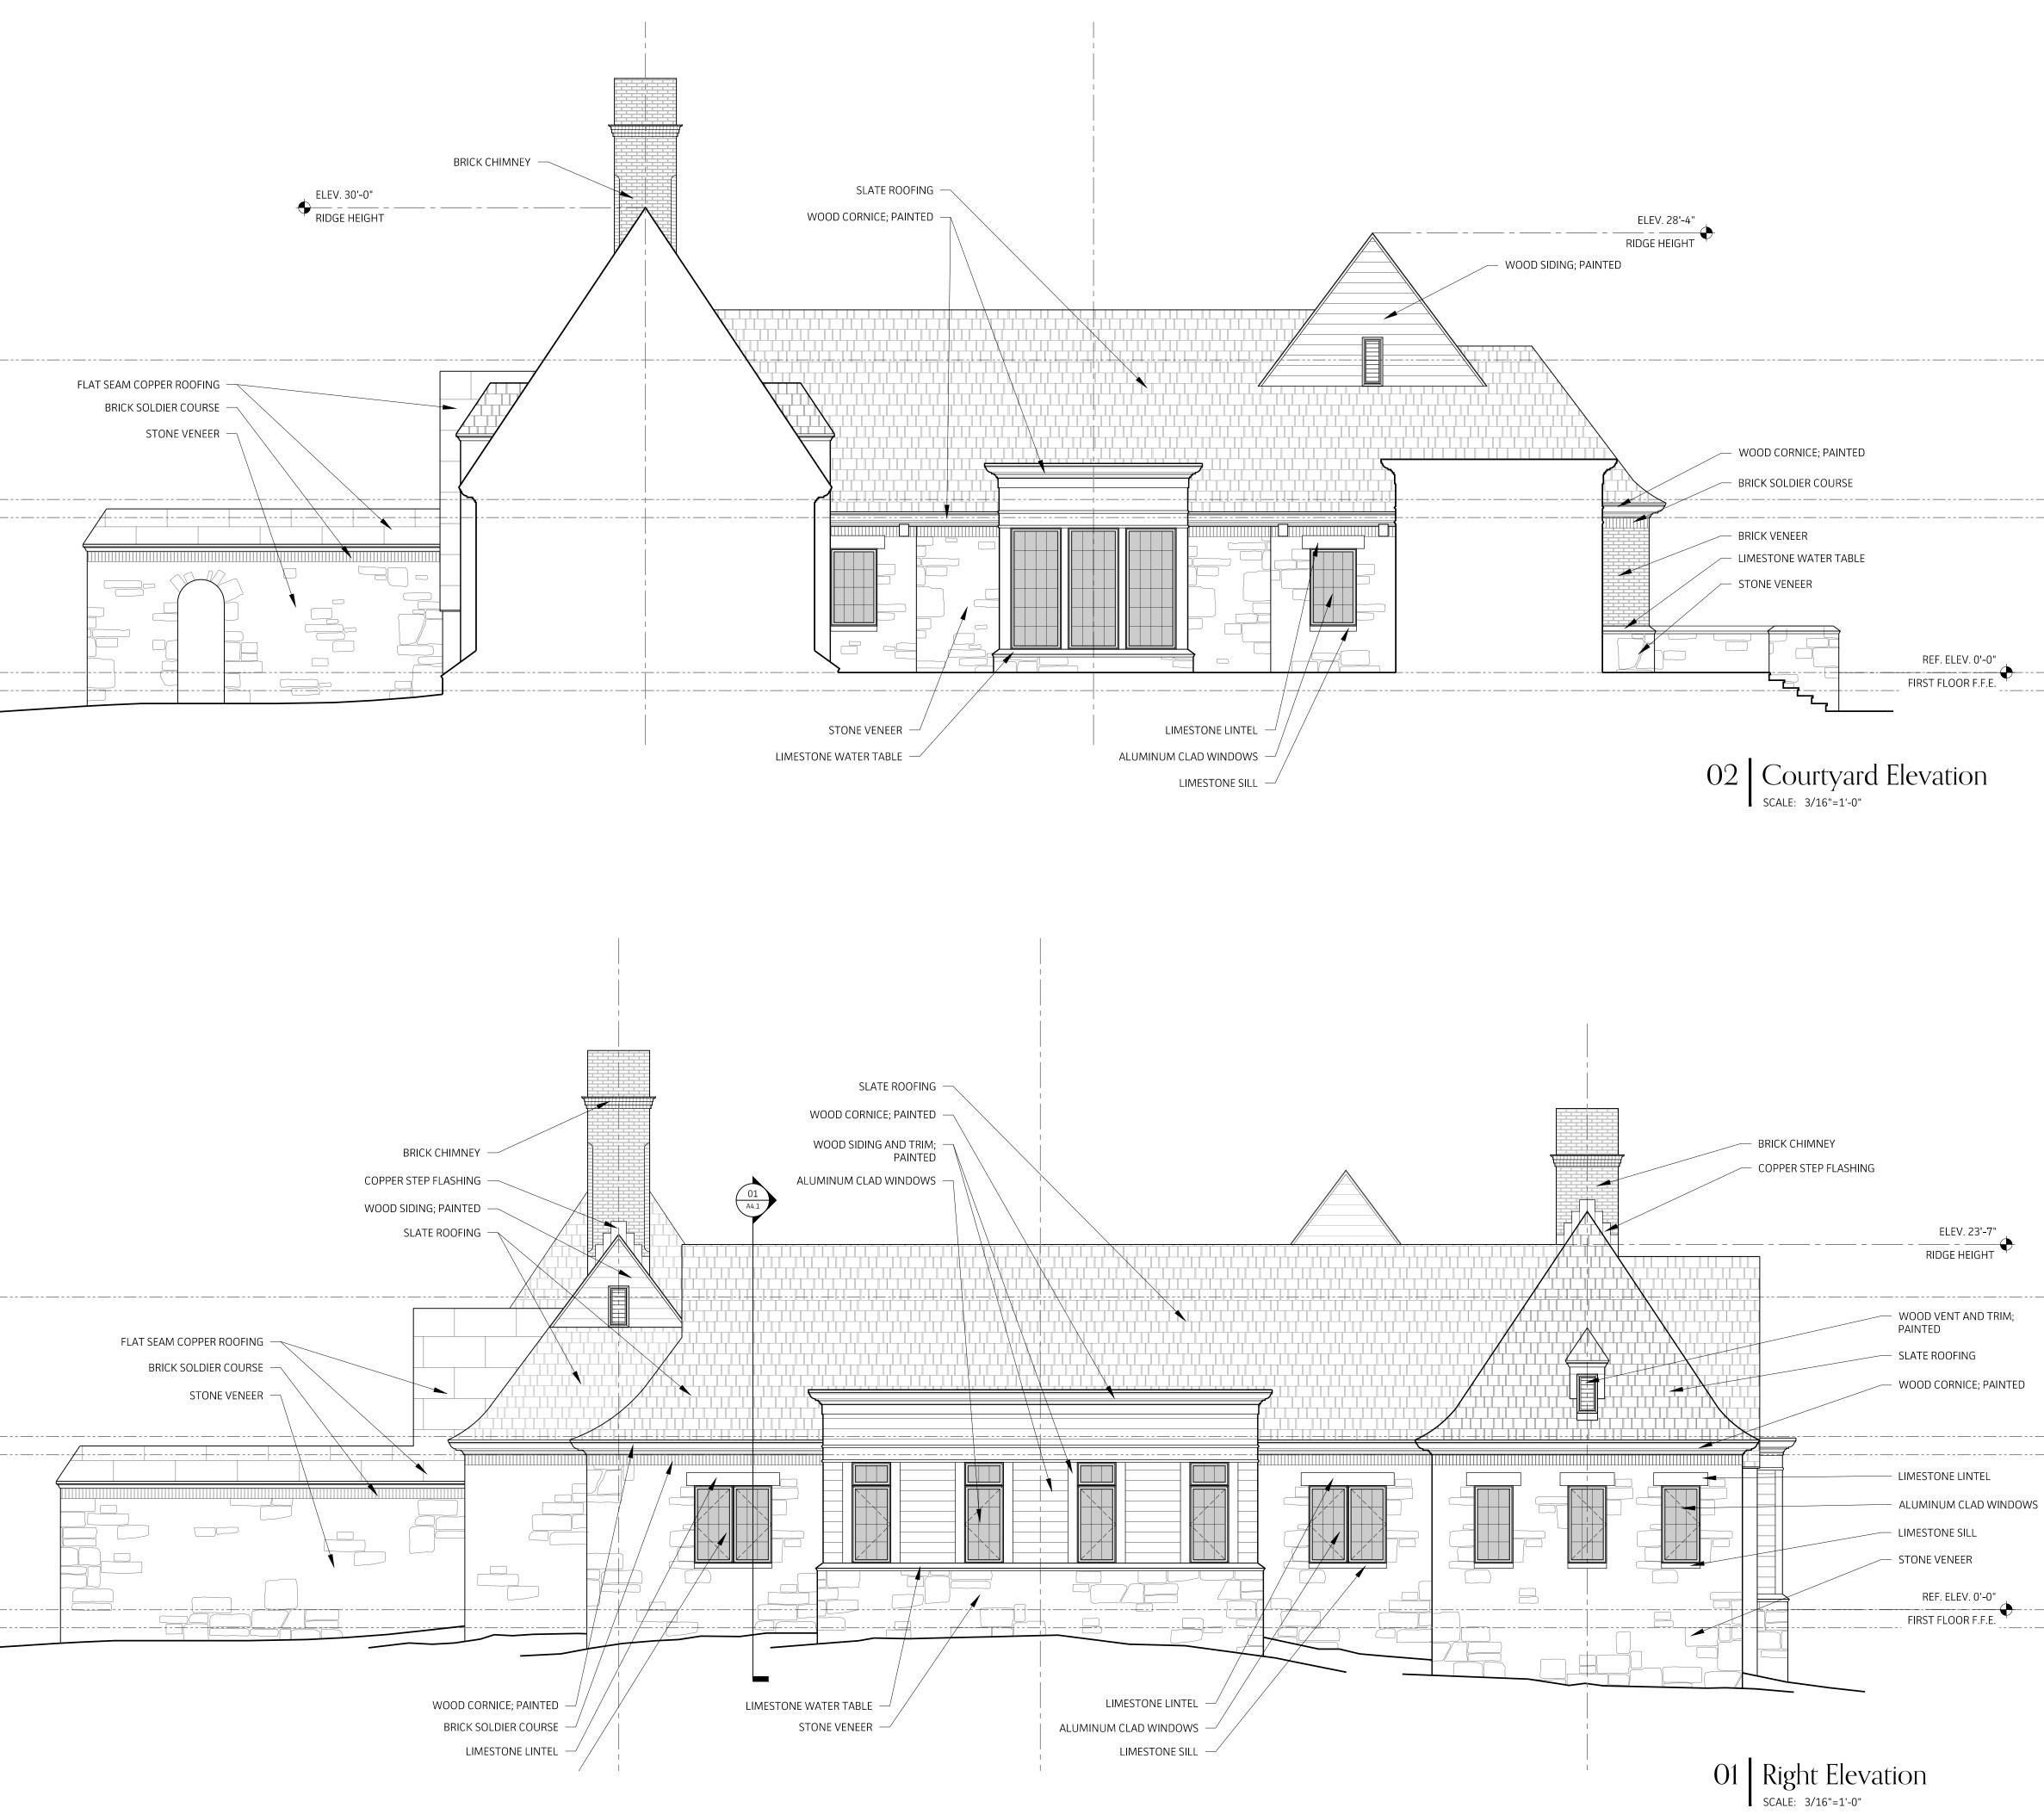^{date} 06/12/2020 јов no. **19014**

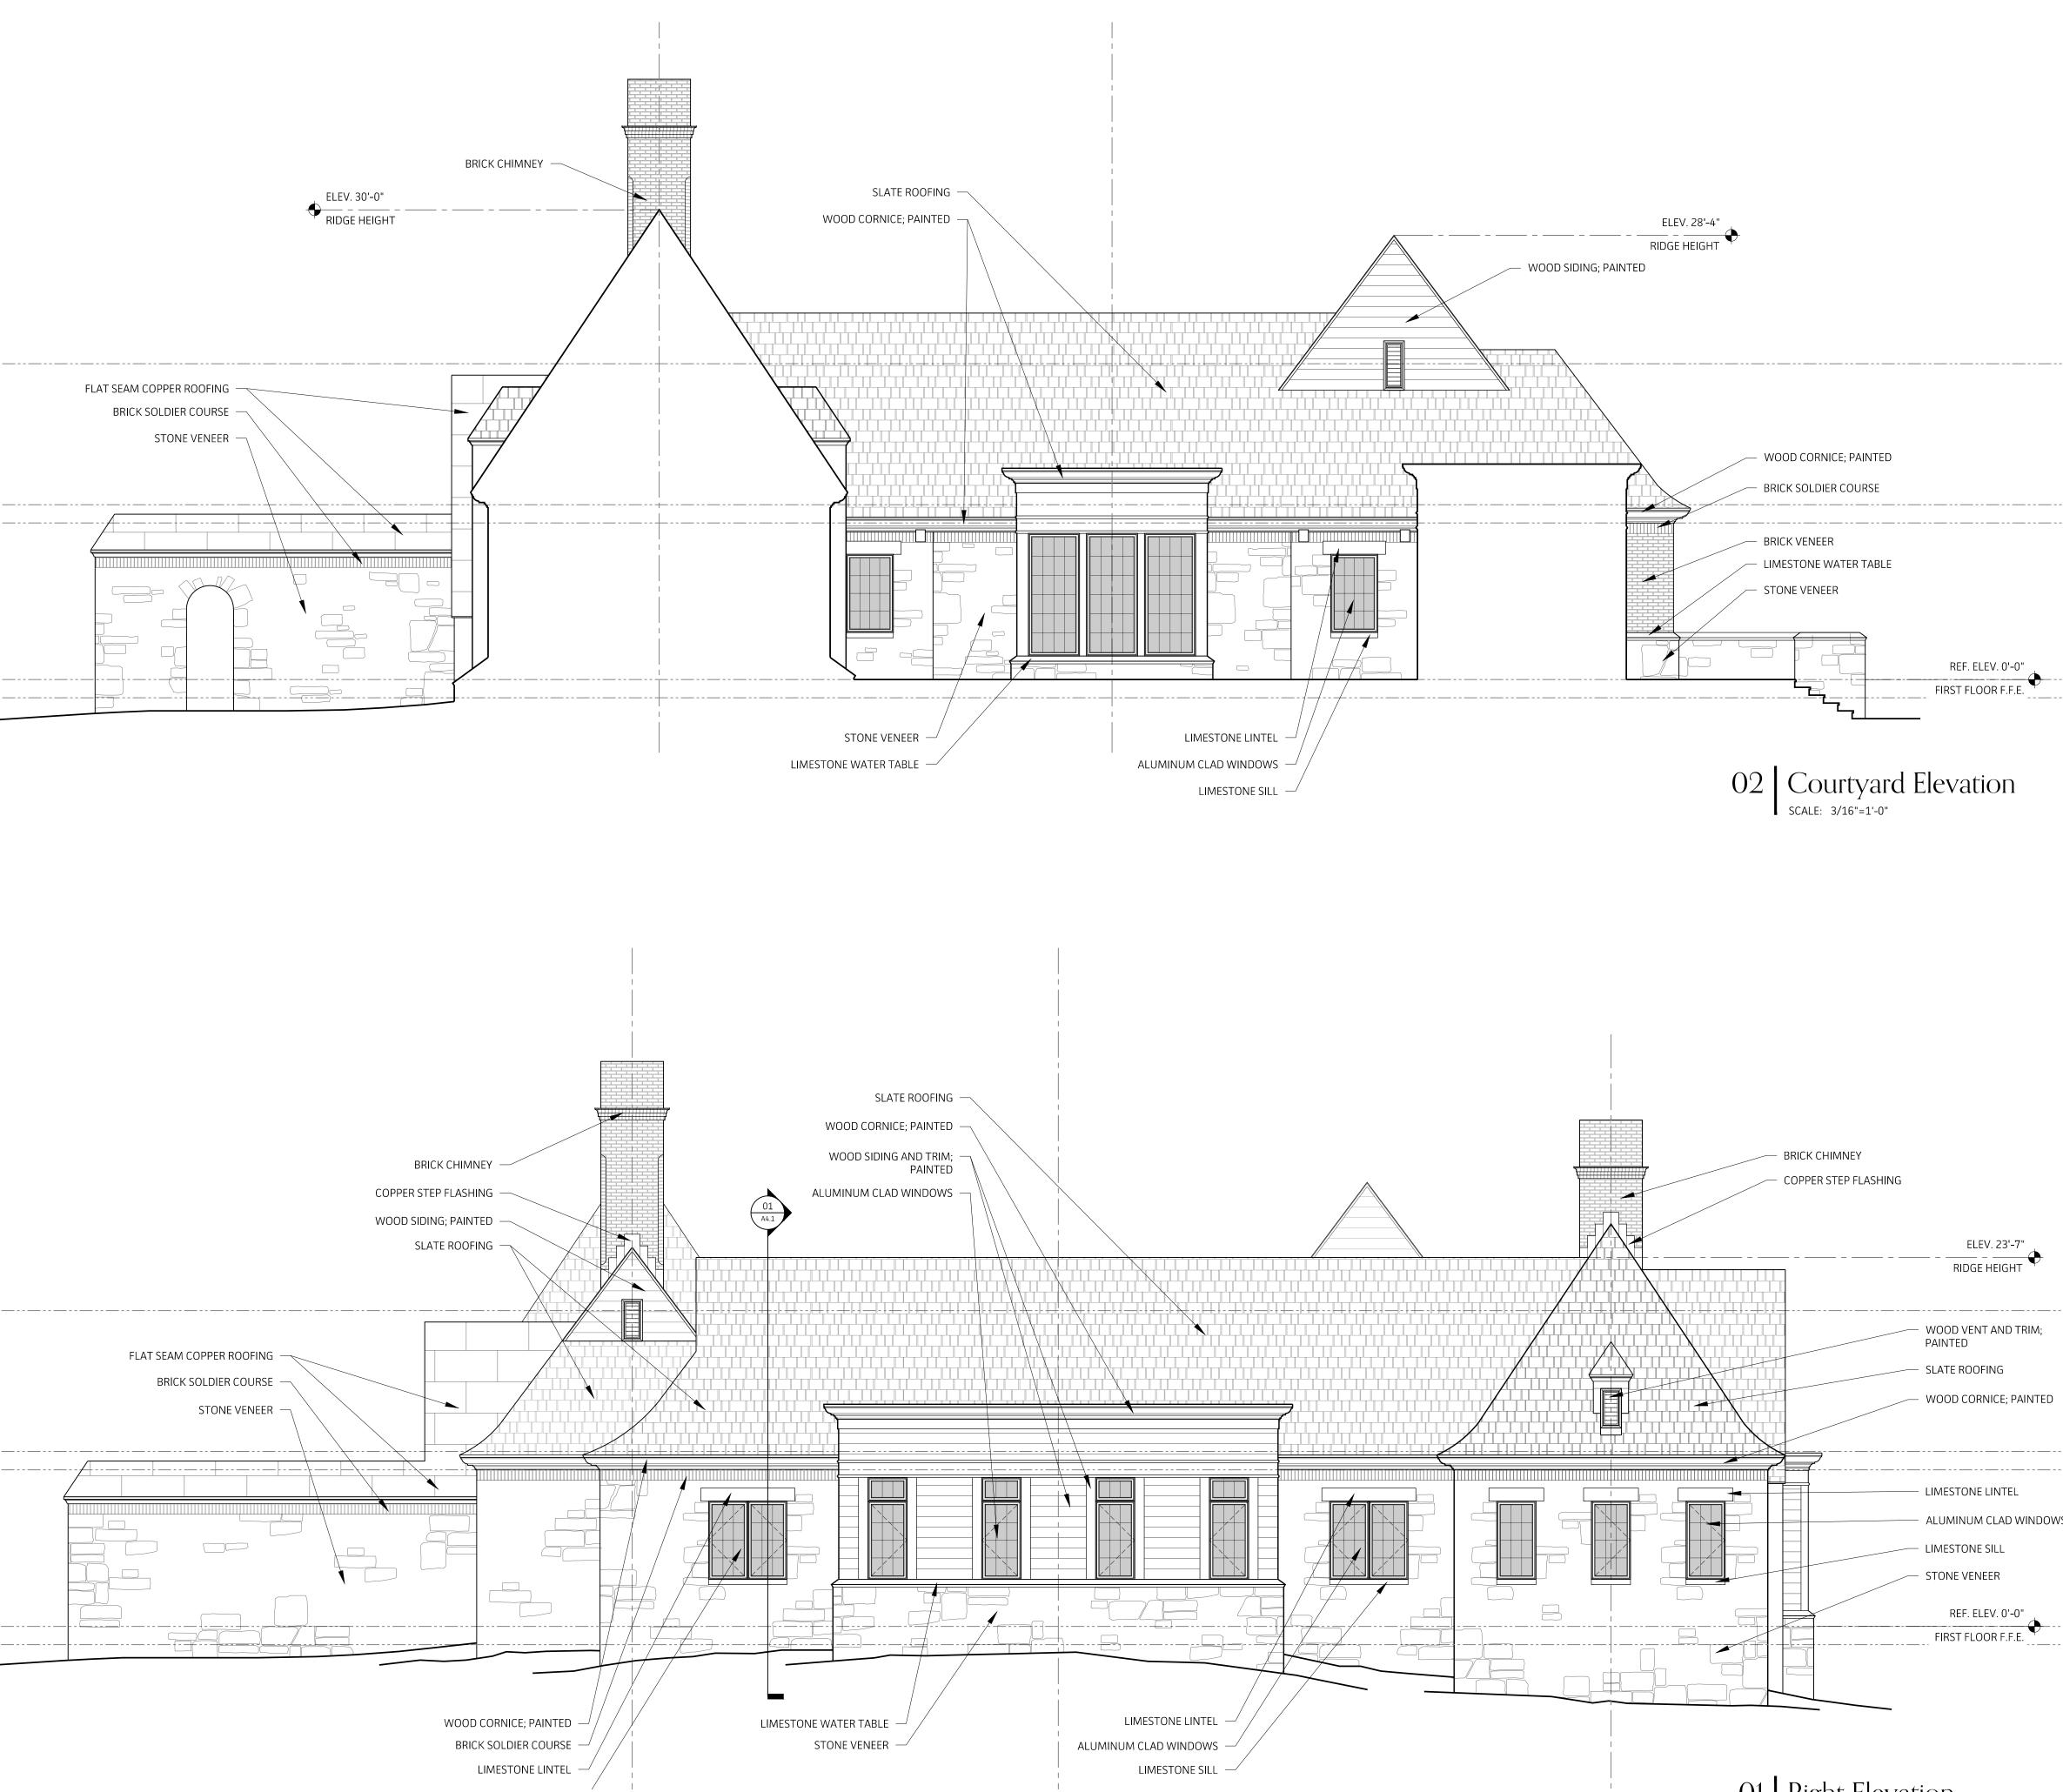drawn by RN checked by CR/JG

SHEET TITLE





NOT FOR CONSTRUCTION Krapf Residence

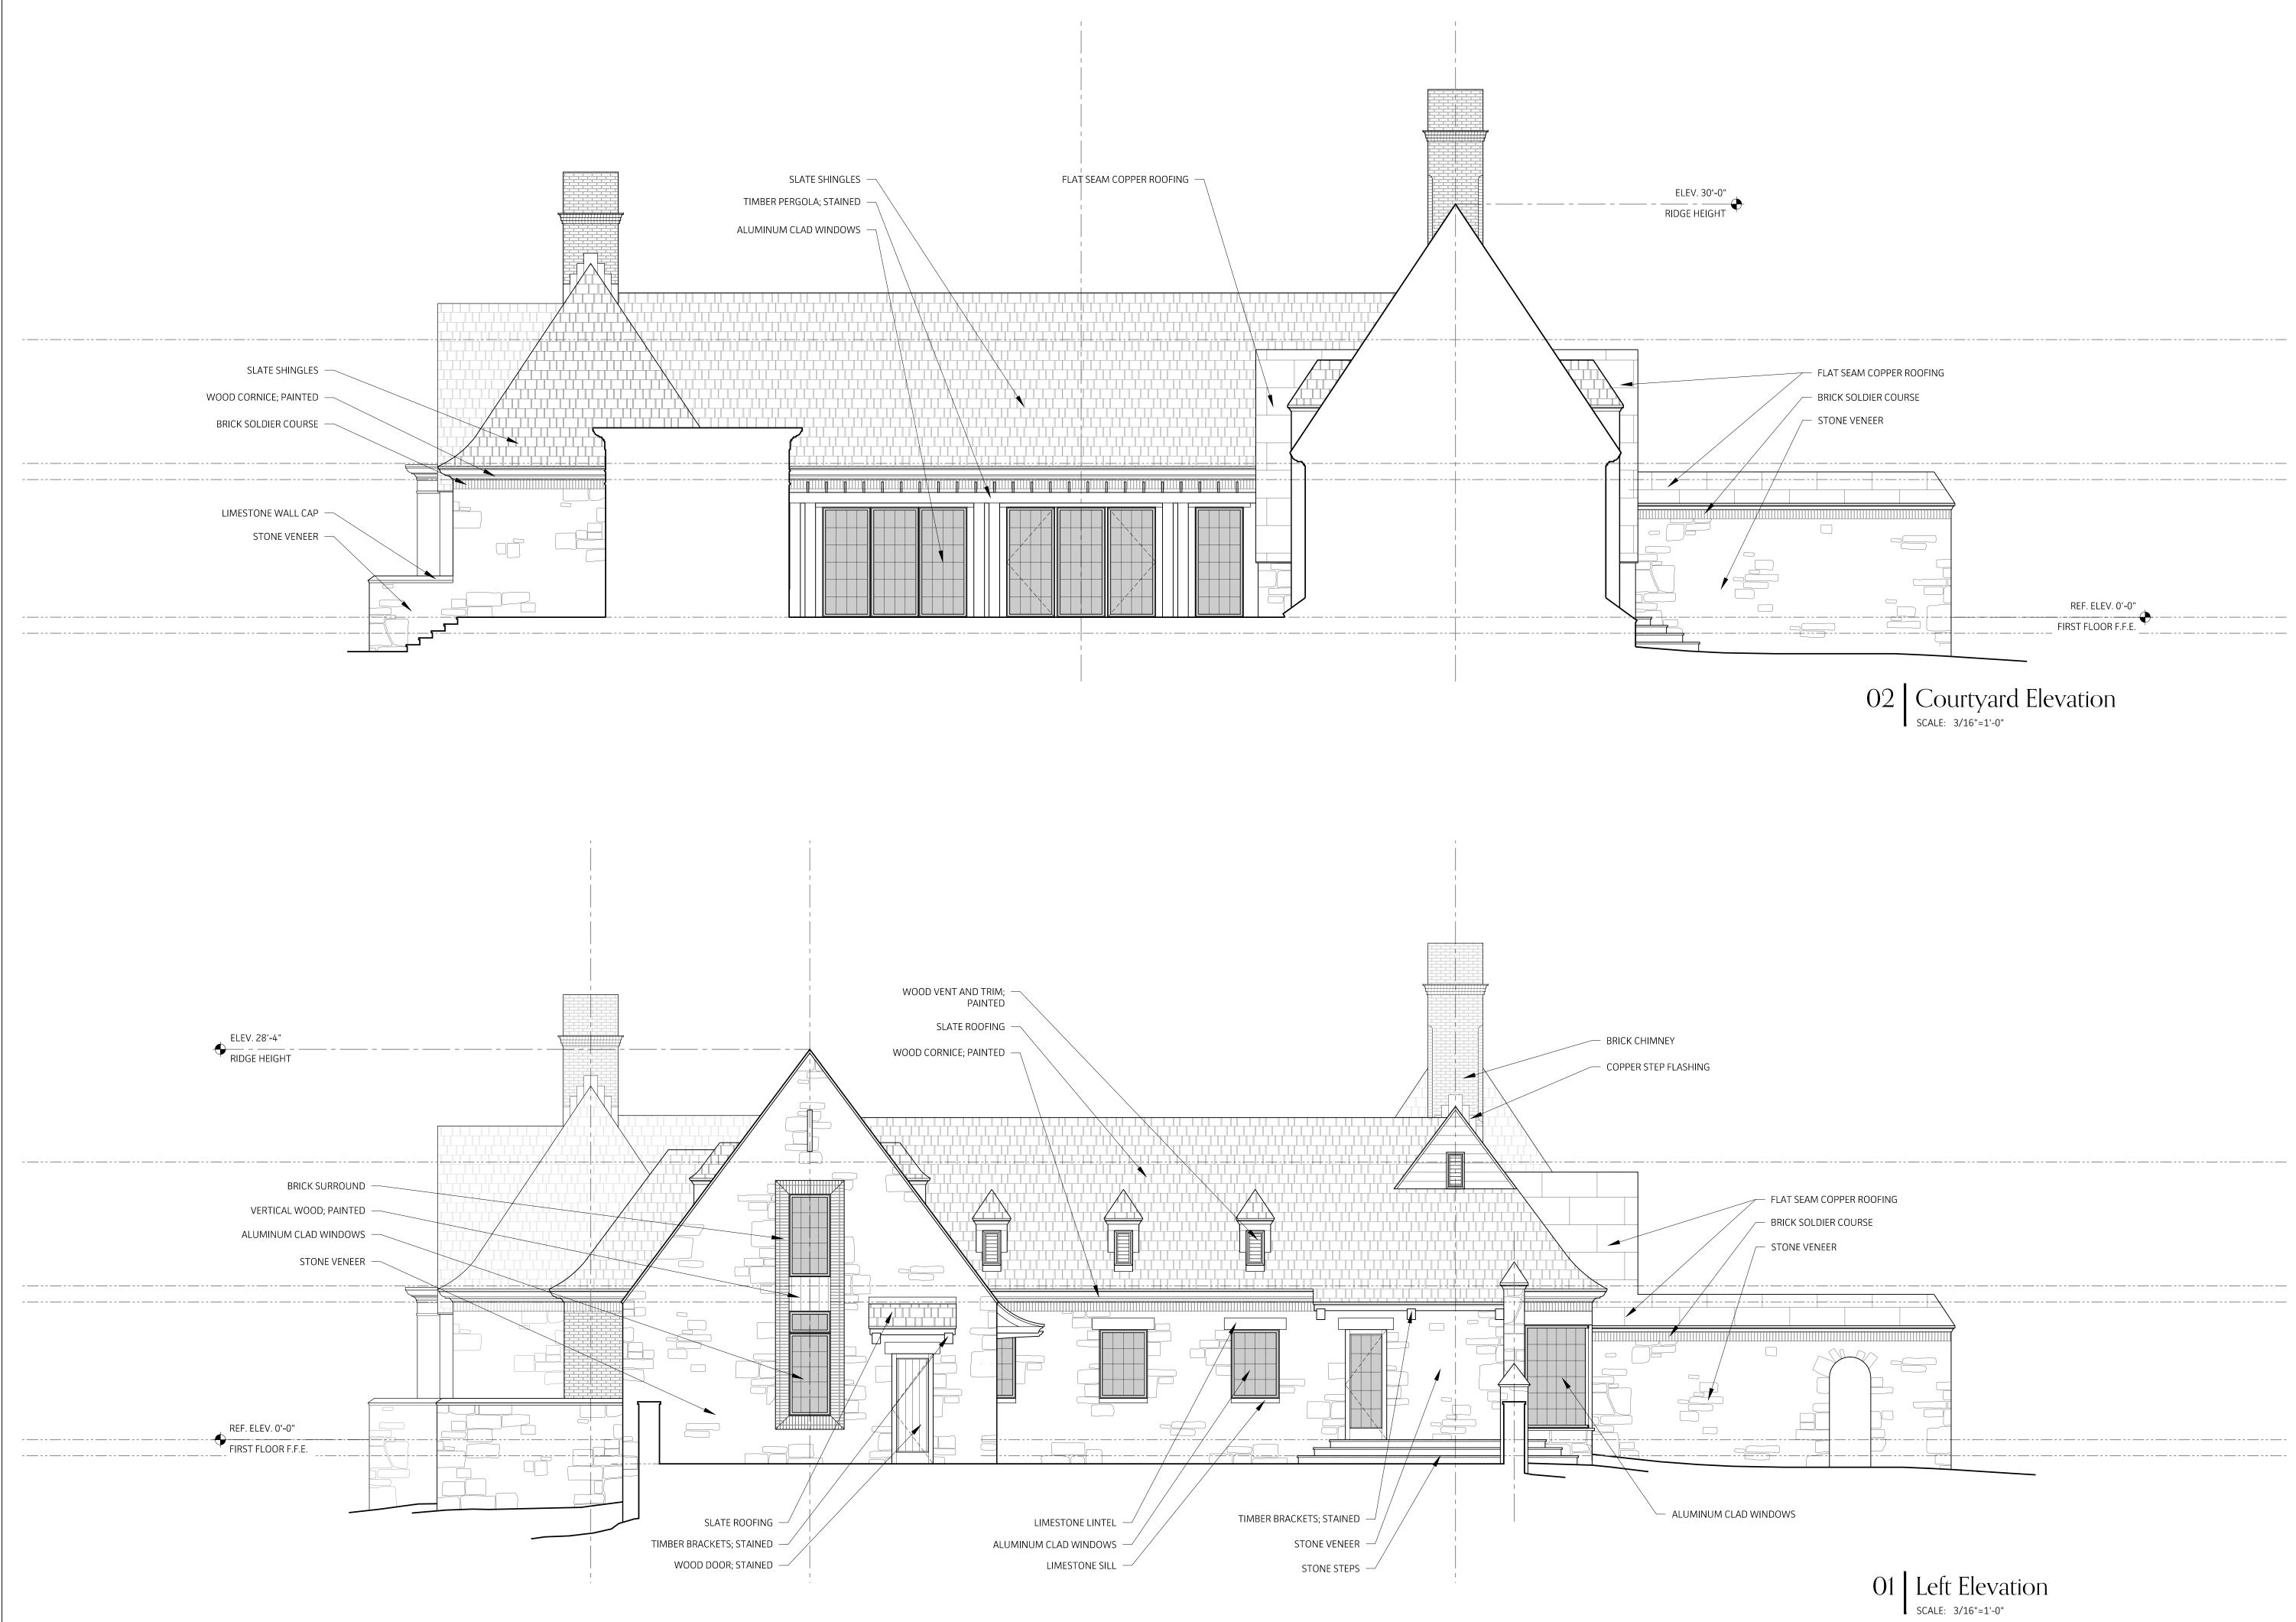
4 San Rafael Drive Rochester, New York 14618

DATE 06/12/2020 JOB NO. 19014

drawn by RN checked by CR/JG

SHEET TITLE








Krapf Residence 4 San Rafael Drive Rochester, New York 14618


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drawn by **RN** снескед ву CR/JG

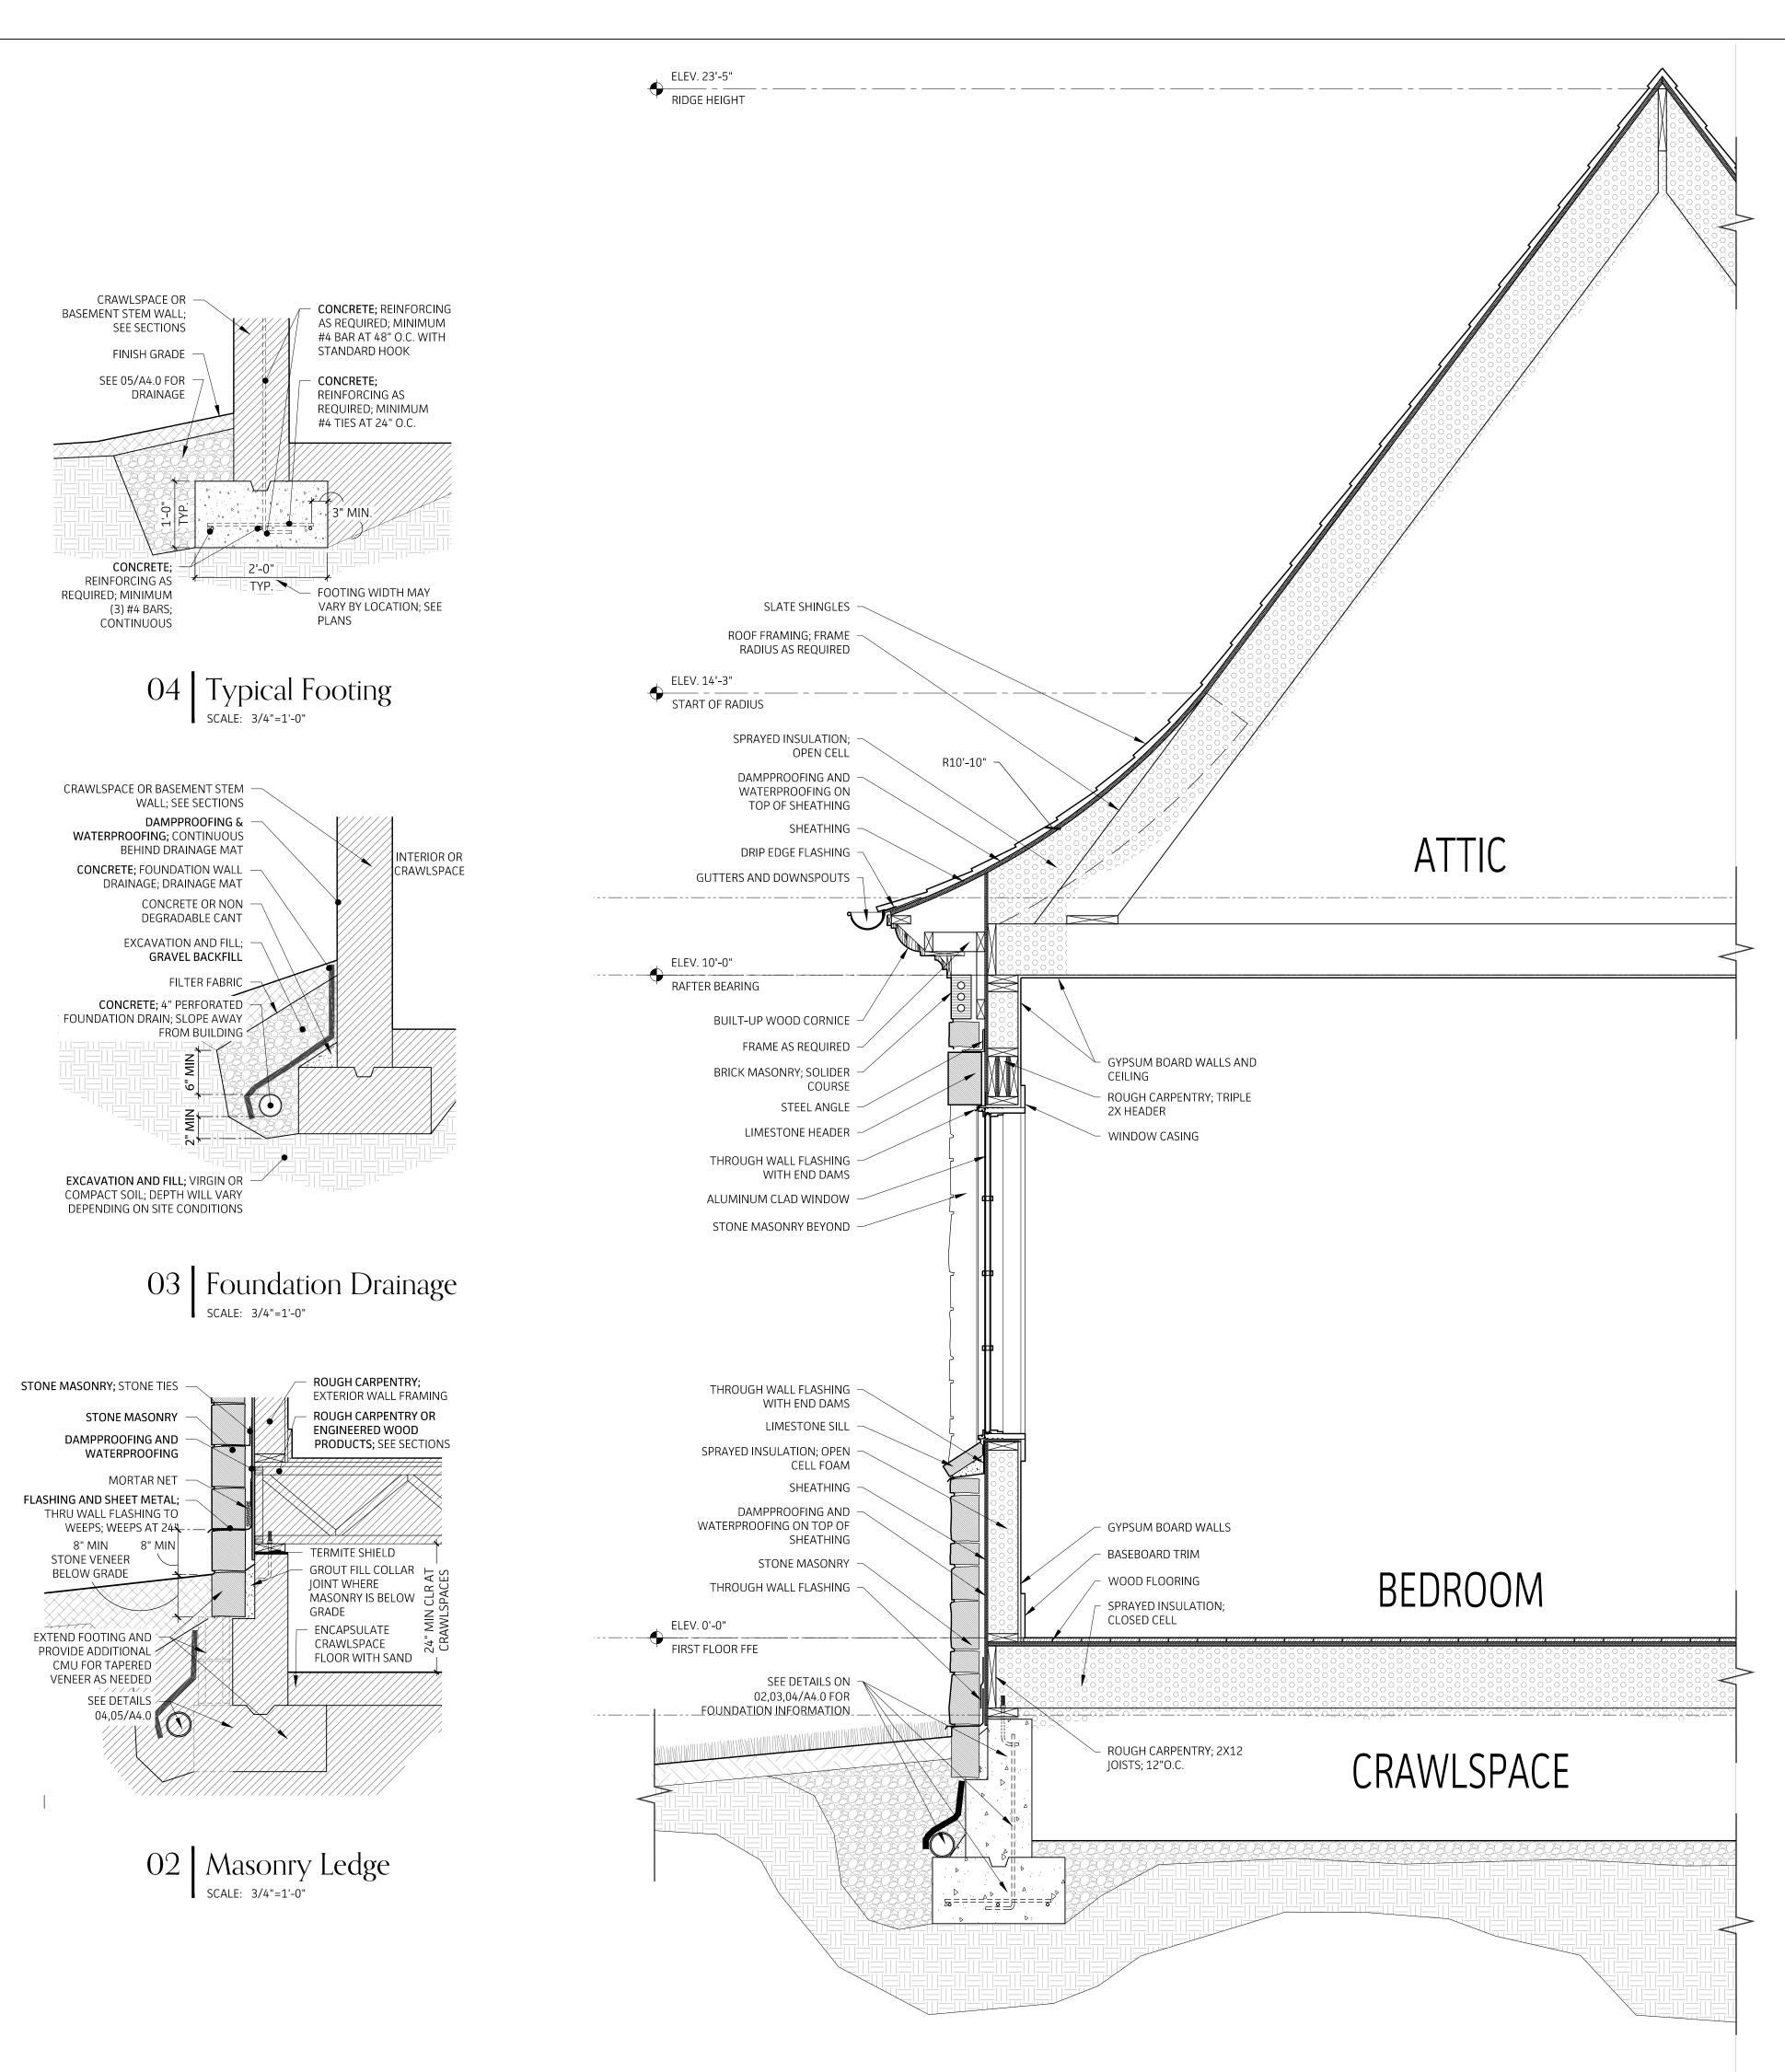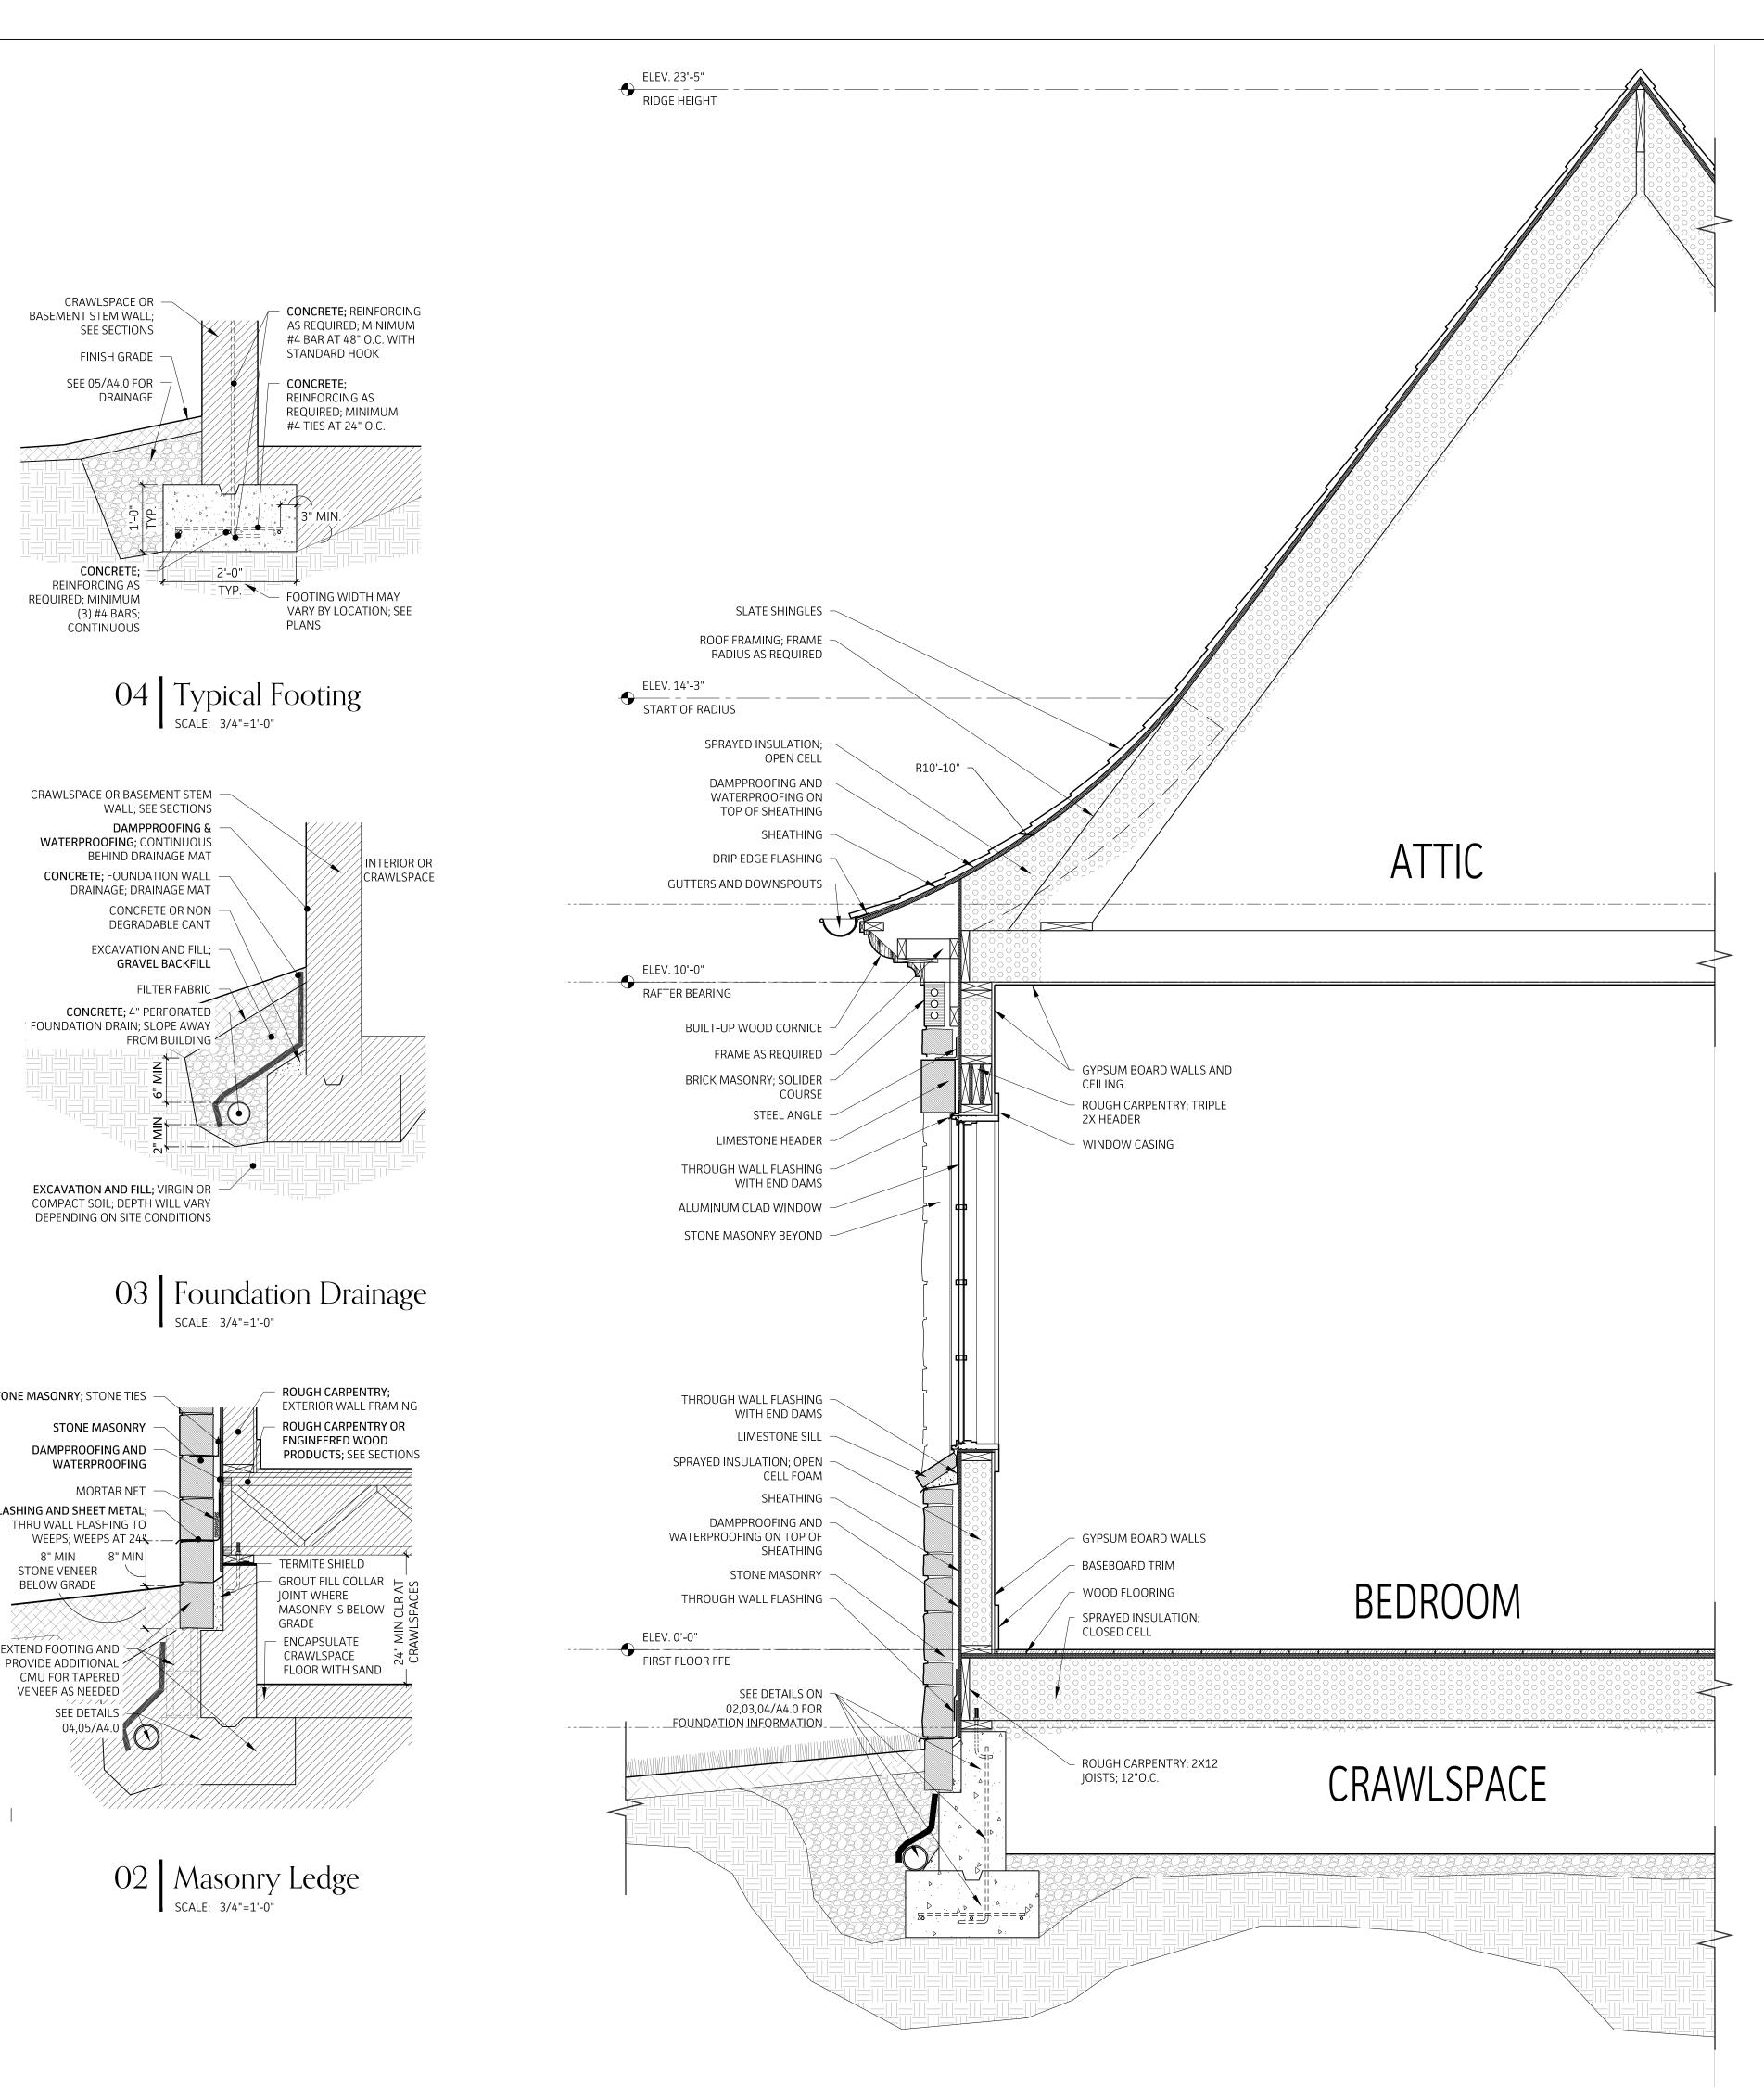SHEET TITLE










Krapf Residence 4 San Rafael Drive Rochester, New York 14618

^{date} 06/05/2020 јов no. **19014**

drawn by RN снескед ву CR/JG

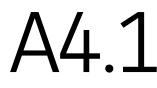sheet title SECTIONS











Town of Pittsford

Department of Public Works 11 South Main Street Pittsford, New York 14534

Permit # B20-000086

Phone: 585-248-6250 FAX: 585-248-6262

DESIGN REVIEW AND HISTORIC PRESERVATION BOARD REFERRAL OF APPLICATION

Property Address: 23 & 25 Skylight Trail Pittsford, NY 14534
Tax ID Number: 192.06-1-18, 192.06-1-17
Zoning District:
Owner: S&J Morrell Builders Inc.
Applicant: S&J Morrell Builders Inc.

Application Type:

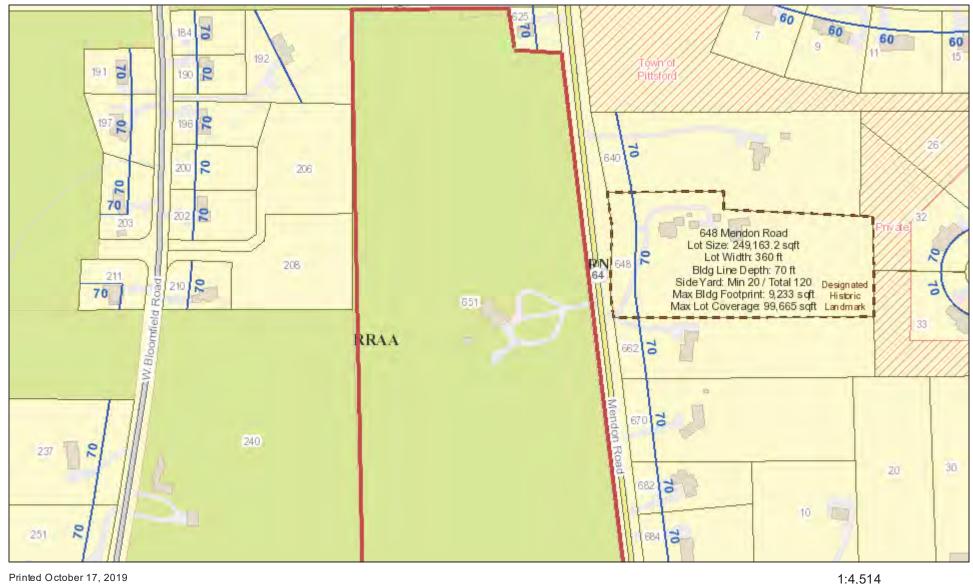
- Residential Design Review §185-205 (B)
- Commercial Design Review
- §185-205 (B) Signage
- §185-205 (C)
- Certificate of Áppropriateness §185-197
- Landmark Designation
- §185-195 (2)
- Informal Review

- Build to Line Adjustment §185-17 (B) (2)
- Building Height Above 30 Feet §185-17 (M)
- Corner Lot Orientation
- §185-17 (K) (3)
- Flag Lot Building Line Location §185-17 (L) (1) (c)
- Undeveloped Flag Lot Requirements §185-17 (L) (2)

Project Description: Applicant is returning to request design review for the proposed construction of a new town home dwelling. The proposed building will consist of 2 attached single family dwellings sharing a common wall. Lot 40 (23 Skylight Trail) will be approximately 2013 sq. ft. and Lot 39 (25 Skylight Trail) will be 2000 sq. ft. The town homes will be located in the new Alpine Ridge development.

Meeting Date: July 23, 2020

RN Residential Neighborhood Zoning



Printed October 17, 2019

110 Town of Pittsford GIS

390

780 ft

220 m

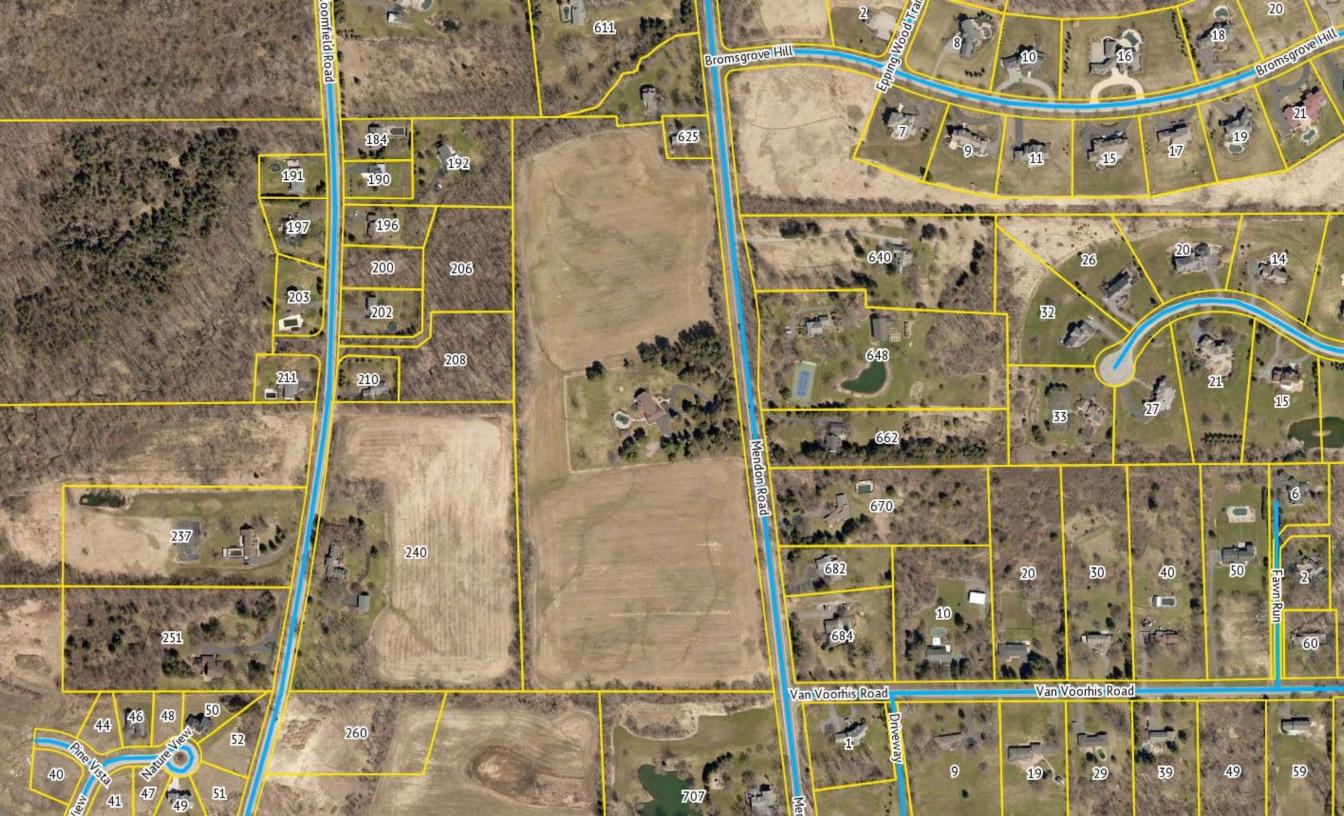
195

55

0

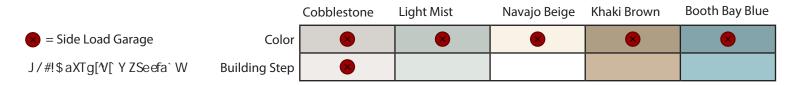
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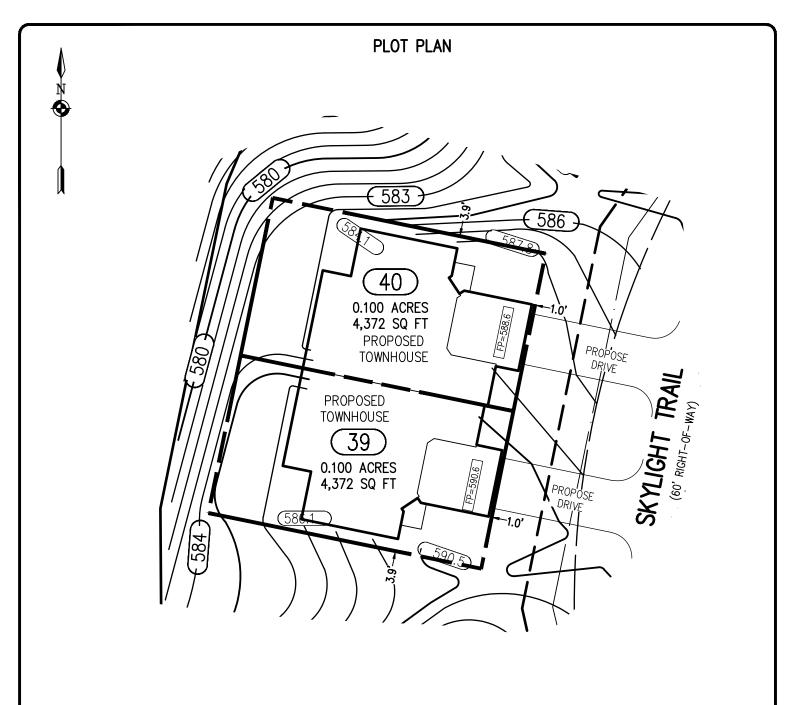
X= Proposed X= Built





"X" MARKS LOCATION OF LOTS 39 & 40





REFERENCES:

- 1. A PLAN ENTITLED "ALPINE RIDGE SUBDIVISION, SECTION 1, BEING A RE-SUBDIVISION OF THE KEVIN RYAN SUBDIVISION, AS FILED 4/15/2019 IN M.C.C.O. AS LIBER 358 OF MAPS, PAGE 41," PREPARED BY DOUGLAS W. MAGDE, L.S. HAVING DRAWING NUMBER SV1.0 AND LAST REVISED JUNE 27. 2019.
- 2. AN ABSTRACT OF TITLE WAS NOT PROVIDED FOR THE COMPLETION OF THIS SURVEY.

NOTES:

PHONE 585-377-7360 FAX 585-377-7309

1. THE BEARING BASE SHOWN HEREON WAS TAKEN FROM REFERENCE 1.

2. SETBACK REQUIREMENTS: 0'(LOT) 25' (R.O.W.) FRONT 0' SIDE REAR 0'

3. UTILITY EASEMENT TO THE TOWN OF PITTSFORD PER REFERENCE 1.

BME Associate

4. GRADING SHOW HEREON WAS TAKEN FROM A PLAN ENTITLED "FINAL SECTION 1 PLANS FOR ALPINE RIDGE SUBDIVISION, GRADING PLAN (SHEET 1 OF 2), PREPARED BY MARATHON ENGINEERING, HAVING JOB NUMBER 0891-17, DRAWING NUMBER C4.0 AND LAST REVISED JUNE 27, 2019.

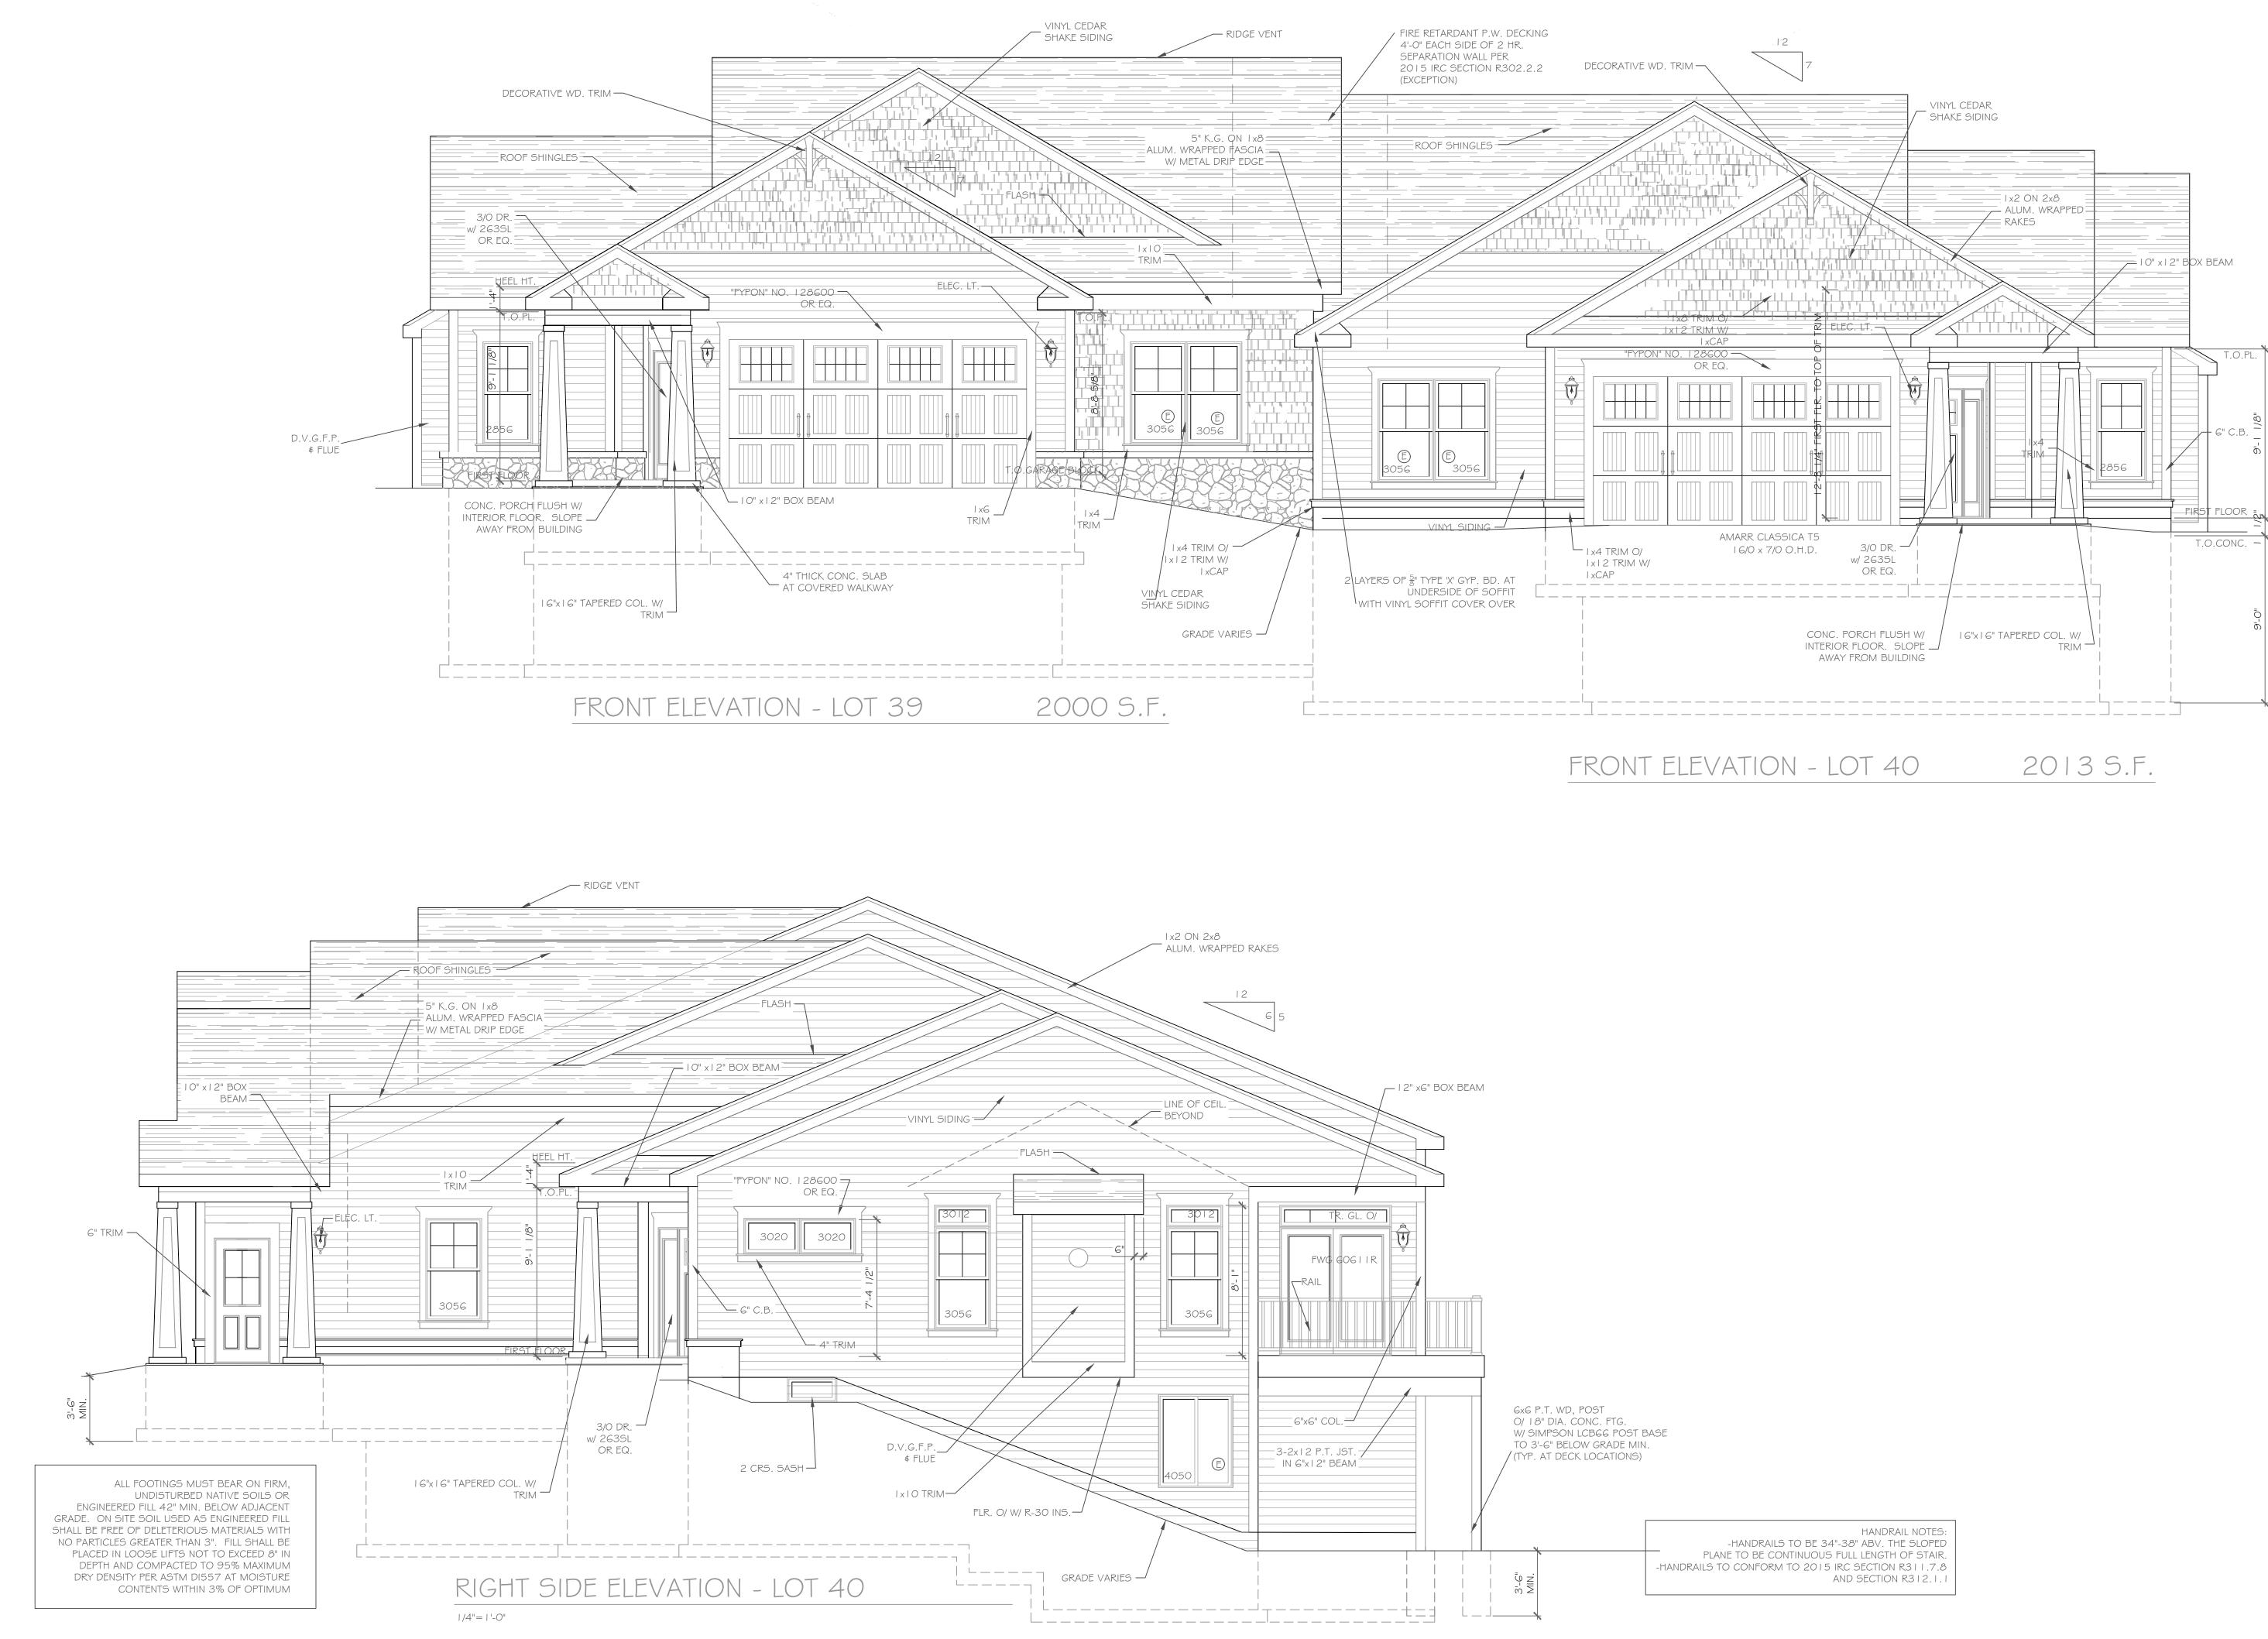
"CERTIFICATIONS INDICATED HEREON SHALL RUN ONLY TO THE PERSON FOR WHOM THE SURVEY IS PREPARED, AND ON HIS BEHALF TO THE TITLE COMPANY, GOVERNMENTAL AGENCY AND LENDING INSTITUTION LISTED HEREON, AND TO THE ASSIGNEES OF THE LENDING INSTITUTION. CERTIFICATIONS ARE NOT TRANSFERABLE TO ADDITIONAL INSTITUTIONS OR SUBSEQUENT OWNERS." THIS MAP AND THE INFORMATION SHOWN HEREON IS NOT TO BE USED WITH AN "AFFIDAVIT OF NO CHANGE." BME ASSOCIATES ASSUMES NO LIABILITY TO THE PARTIES NOTED HEREON OR TO ANY FUTURE OWNER, TITLE COMPANY, GOVERNMENTAL AGENCY, ATTORNEY, OR LENDING INSTITUTION IN THE EVENT THAT THIS MAP IS USED WITH AN "AFFIDAVIT OF NO CHANGE." OR SIMILAR INSTRUMENT. OF NEN XX S COPIES OF THIS SURVEY MAP NOT BEARING THE LAND SURVEYOR'S ORIGINAL INKED SEAL OR EMBOSSED SEAL SHALL NOT BE CONSIDERED TO BE A VALID TRUE COPY. "UNAUTHORIZED ALTERATION OR ADDITION TO THIS SURVEY MAP IS A VIOLATION OF SECTION 7209, OF THE NEW YORK STATE EDUCATION LAW." BME ASSOCIATES LOTS 39 & 40 ALPINE RIDGE SUBDIVISION SECTION 1 TOWN OF PITTSFORD MONROE COUNTY NEW YORK ENGINEERS • SURVEYORS • LANDSCAPE ARCHITECTS 10 LIFT BRIDGE LANE EAST FAIRPORT, NEW YORK 14450 SCALE: 1"=30' DRAWN BY: GDB 05066 COPYRIGHT © 2020 SED LAND SURVE

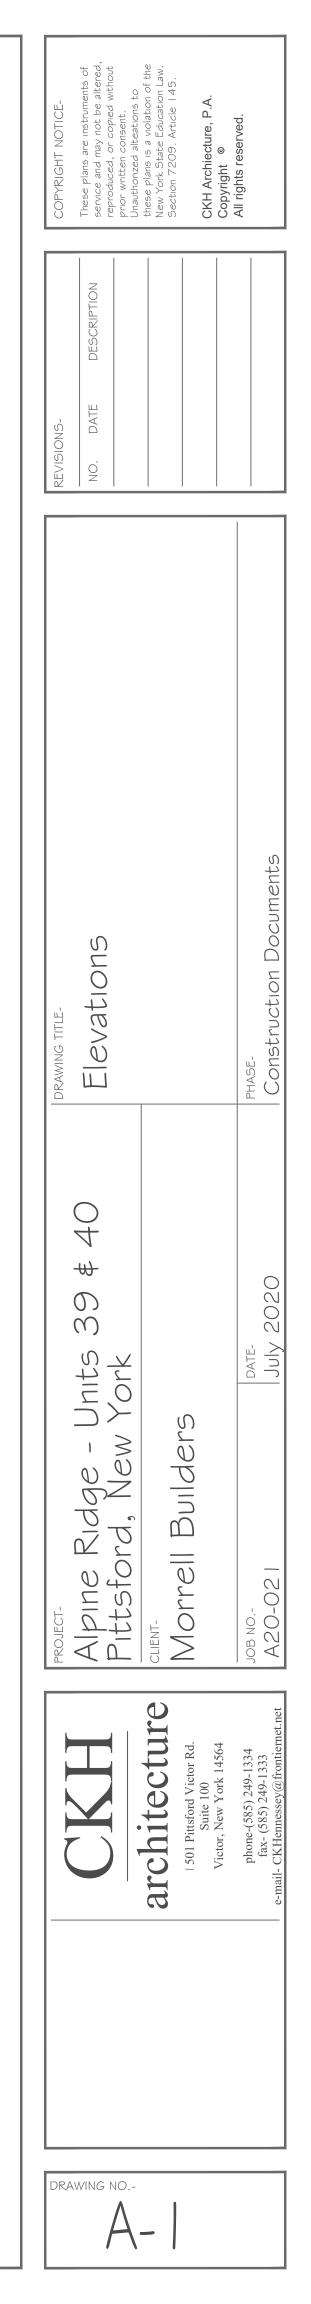
DATE: 7-2-20

DWG NO: 2688-04

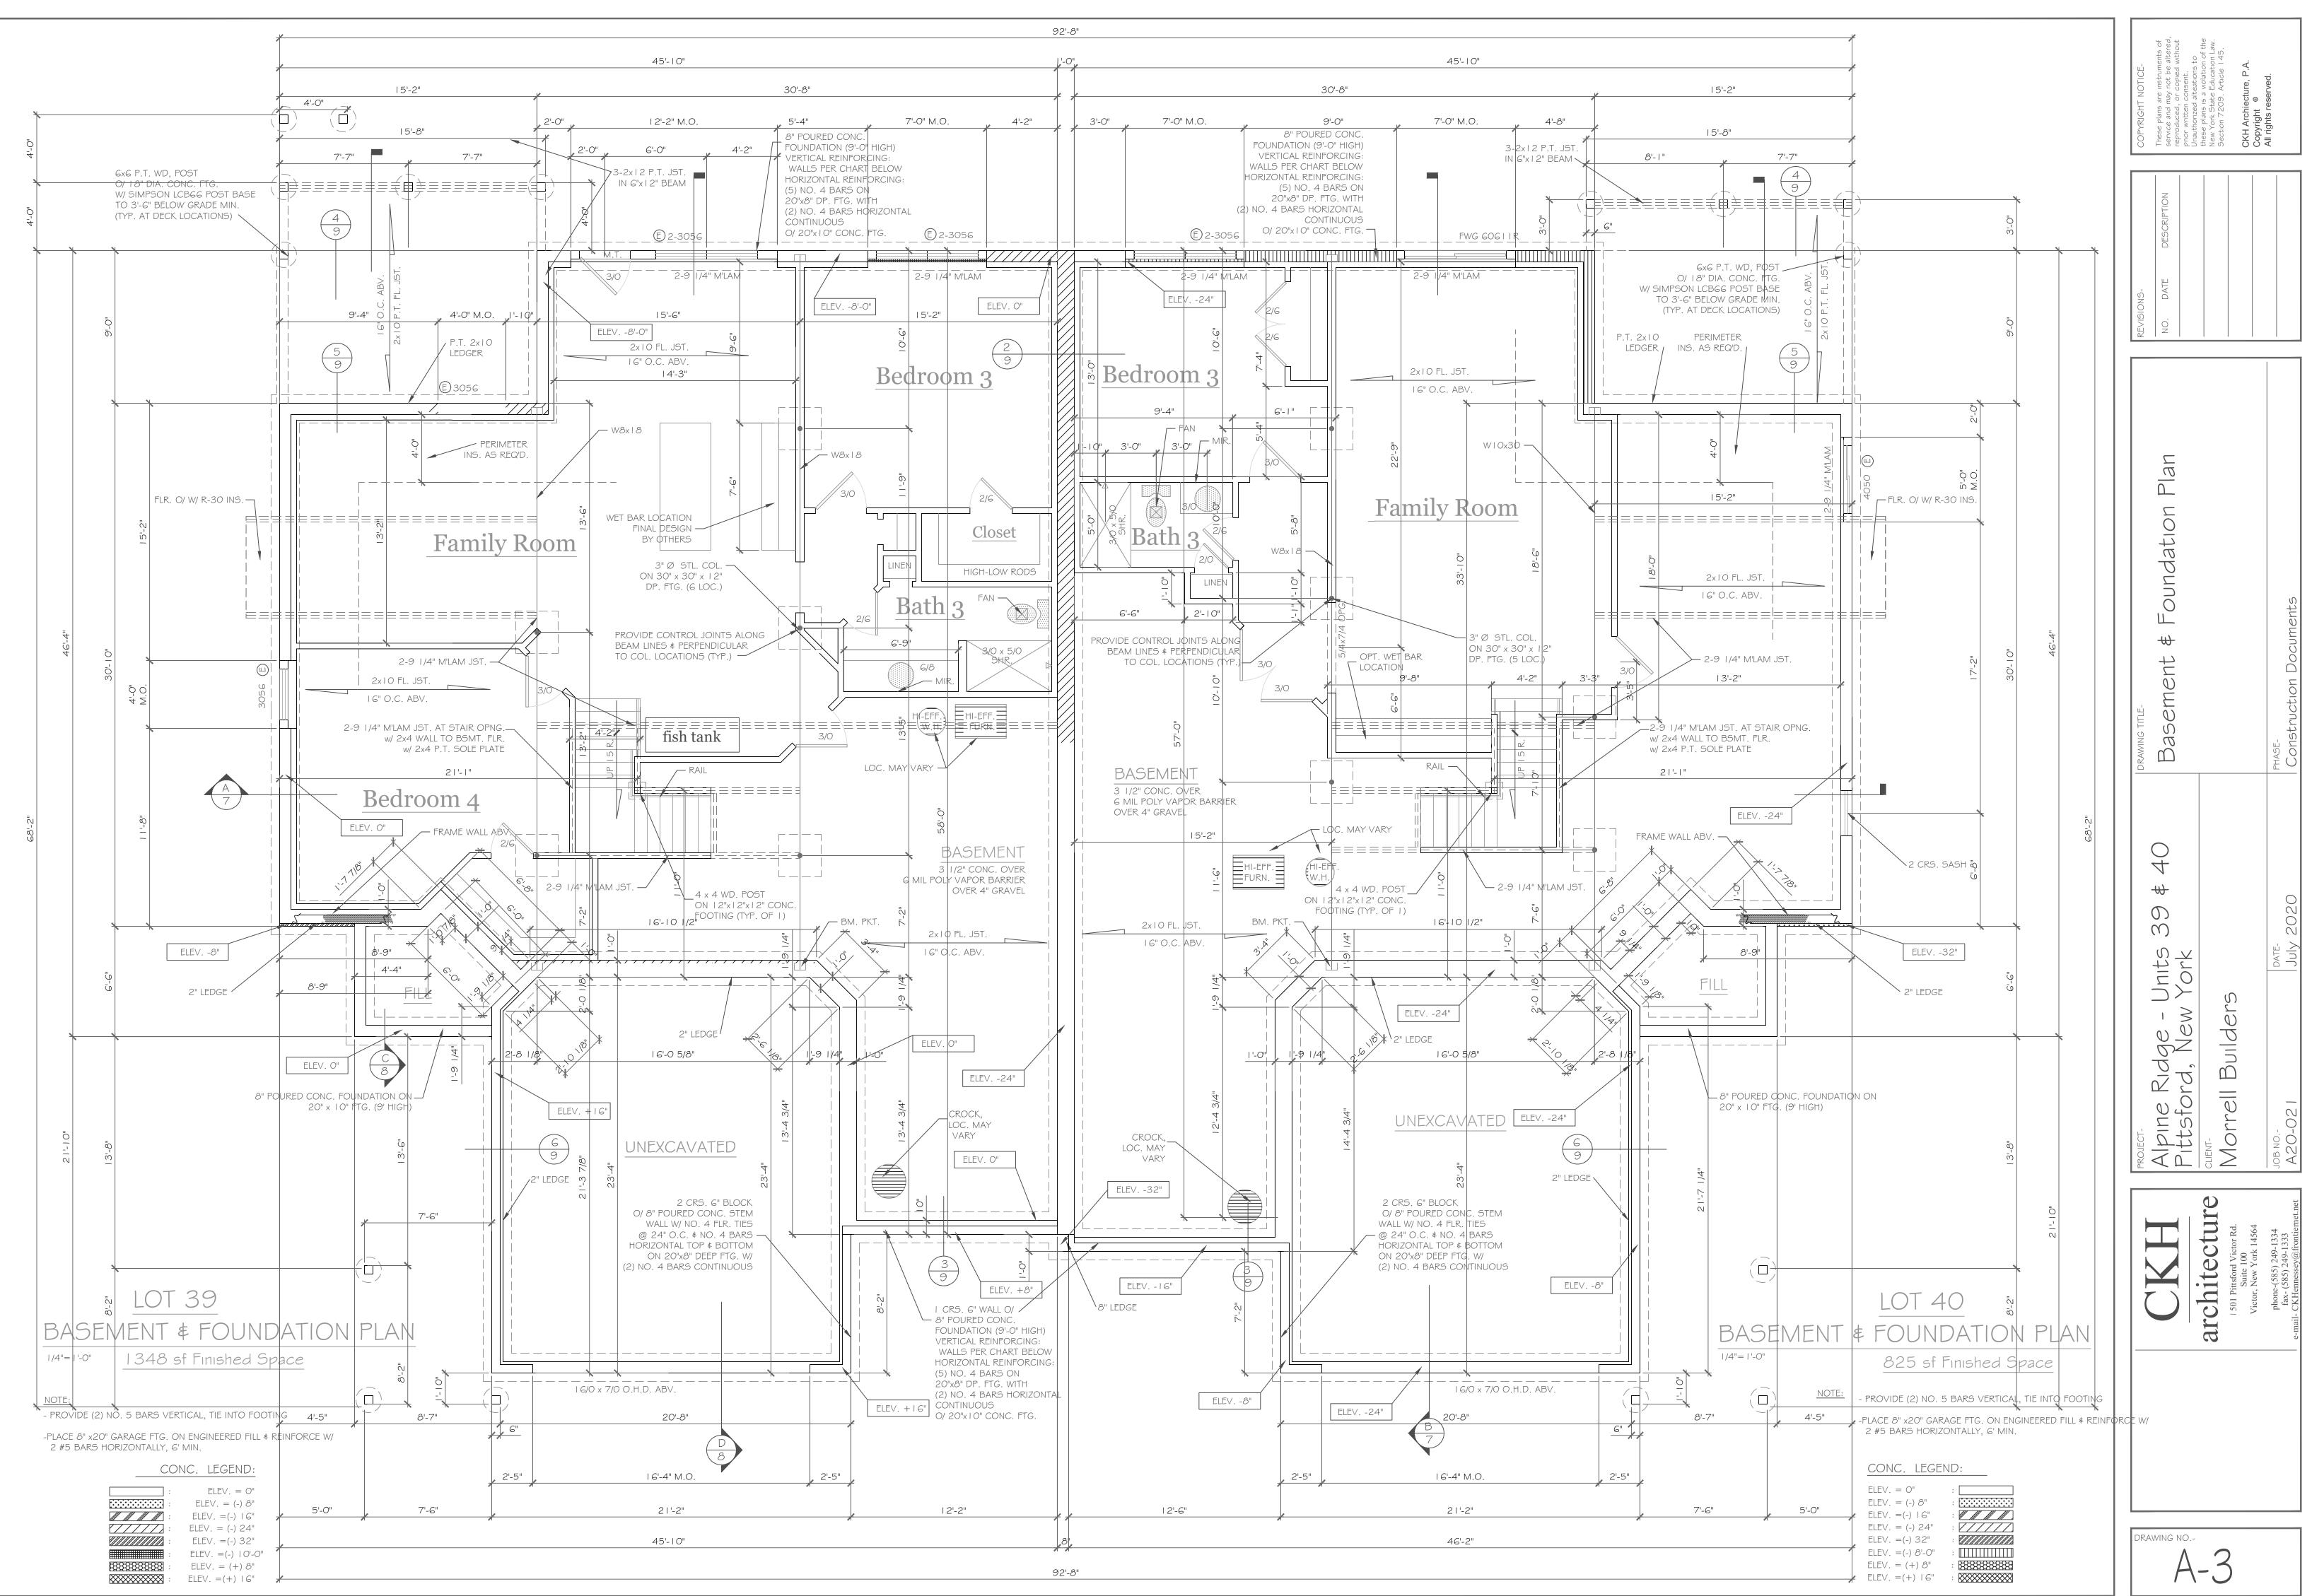
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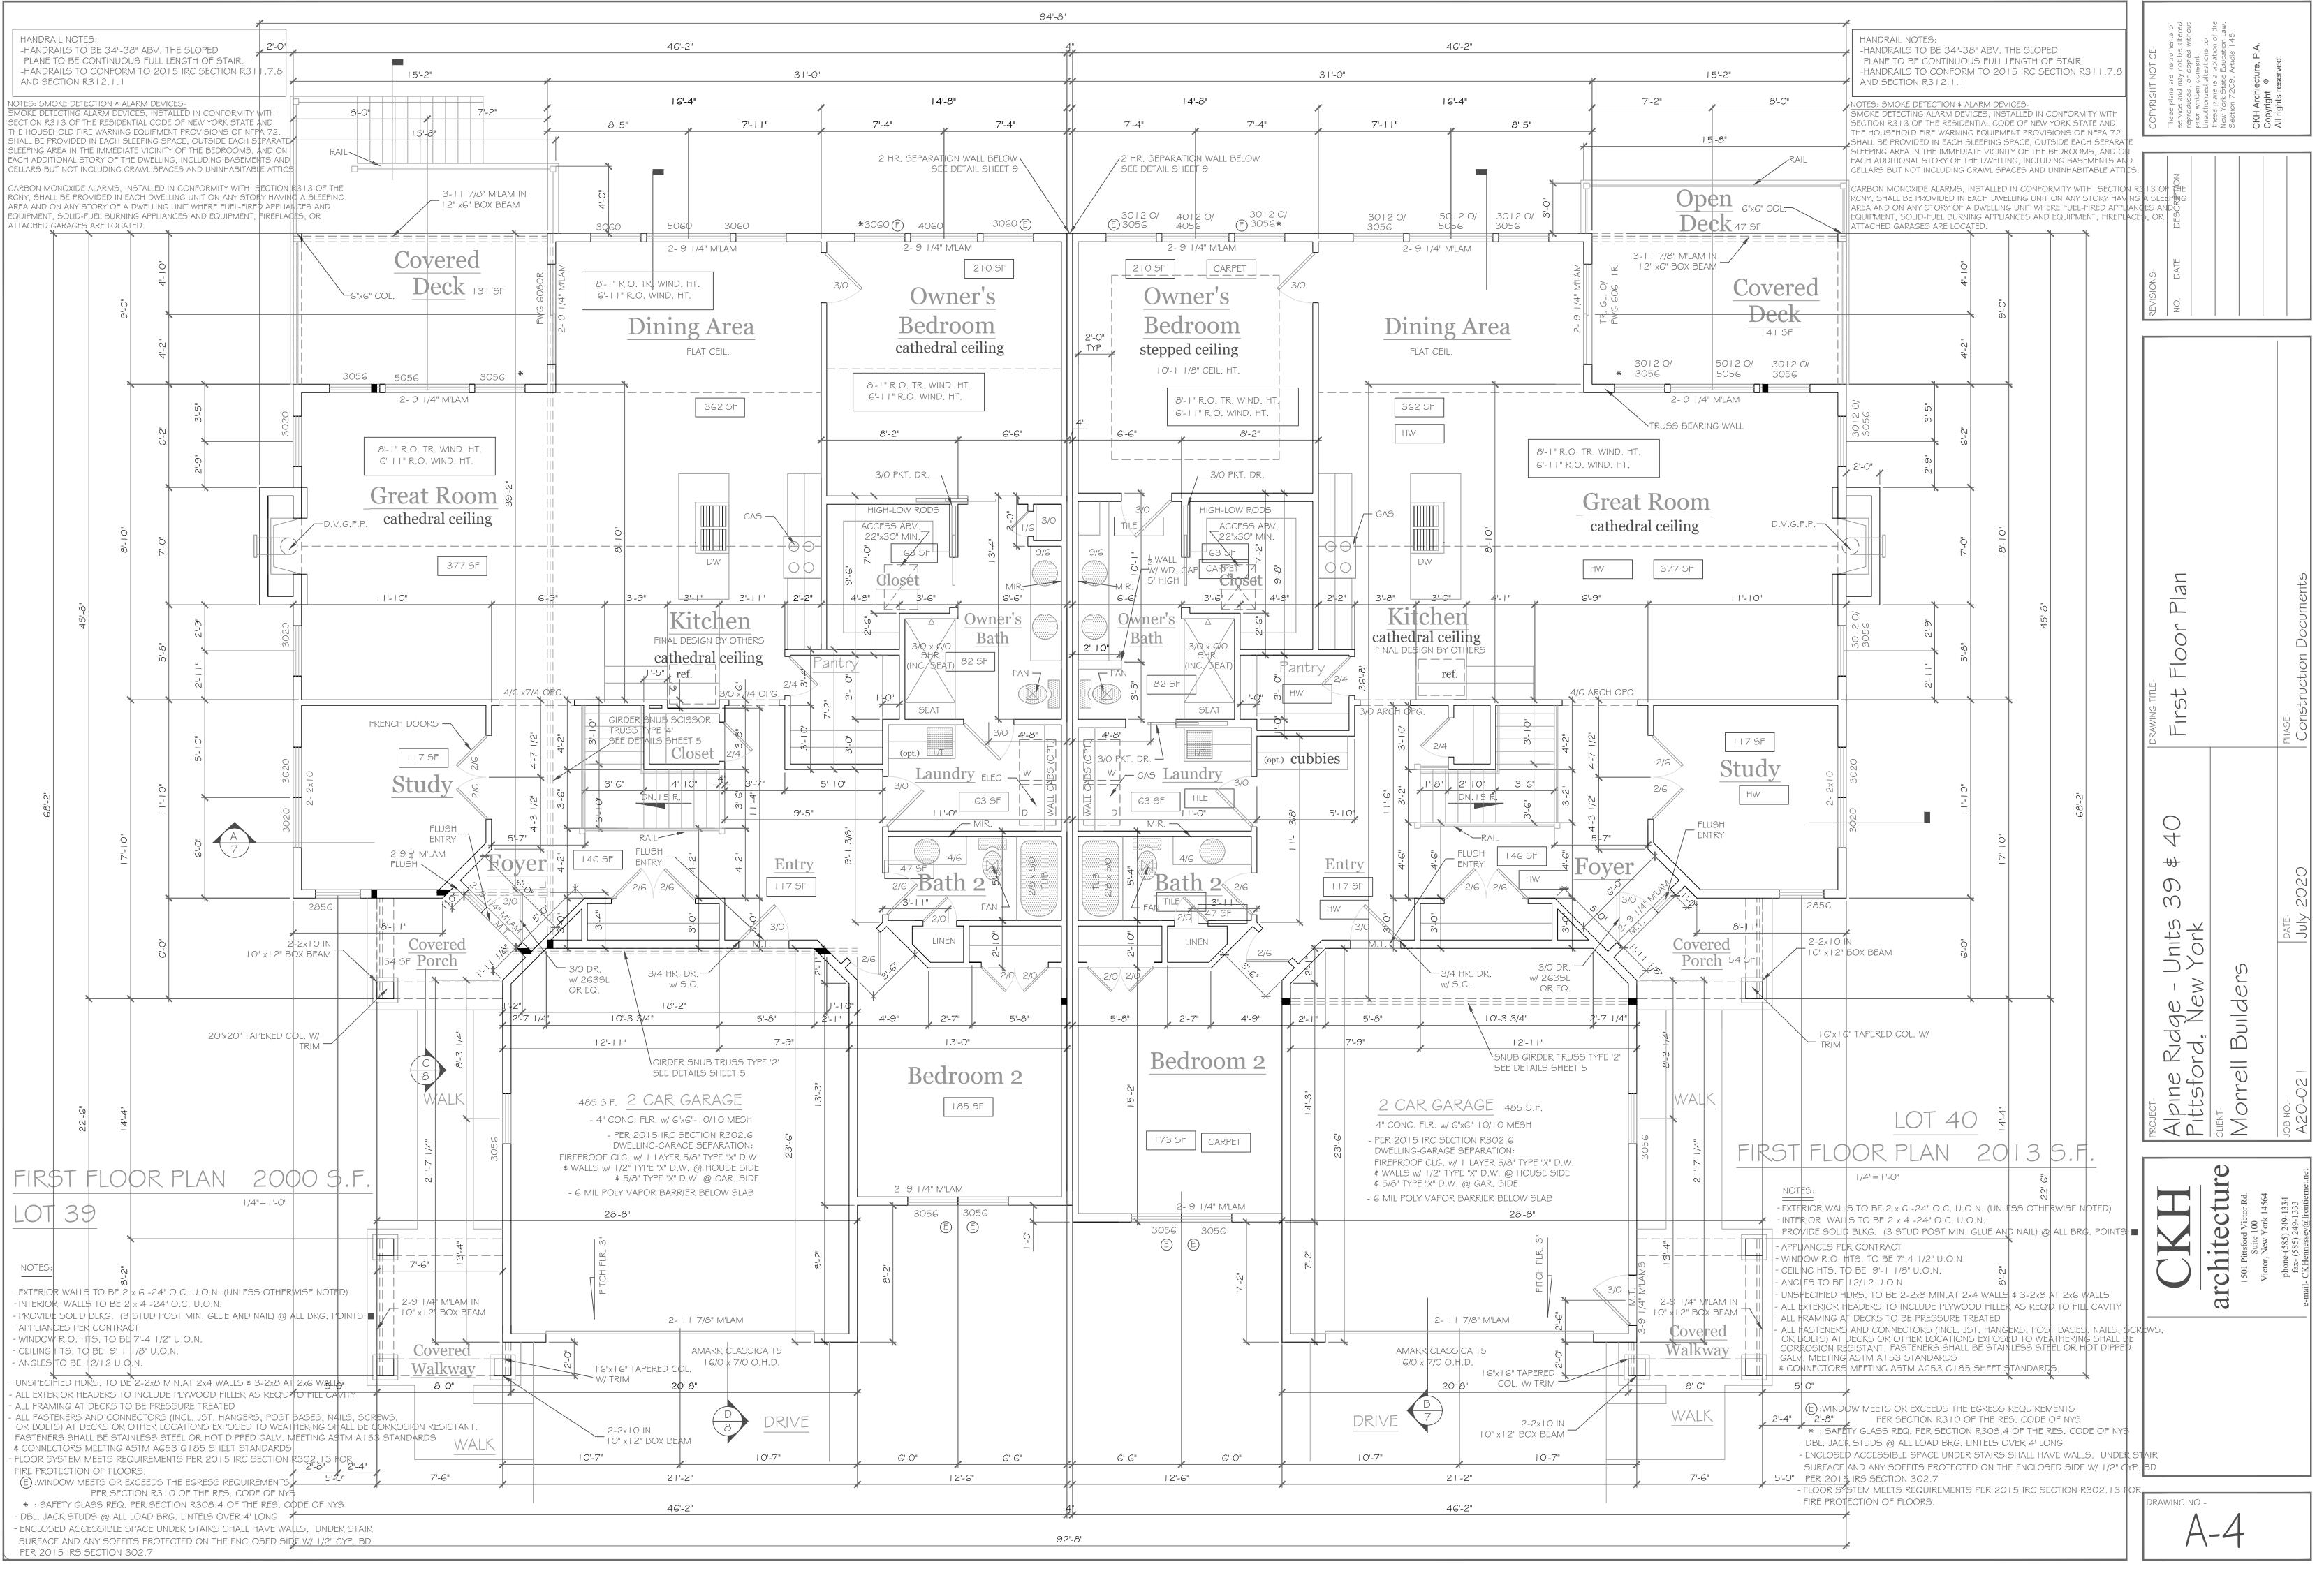
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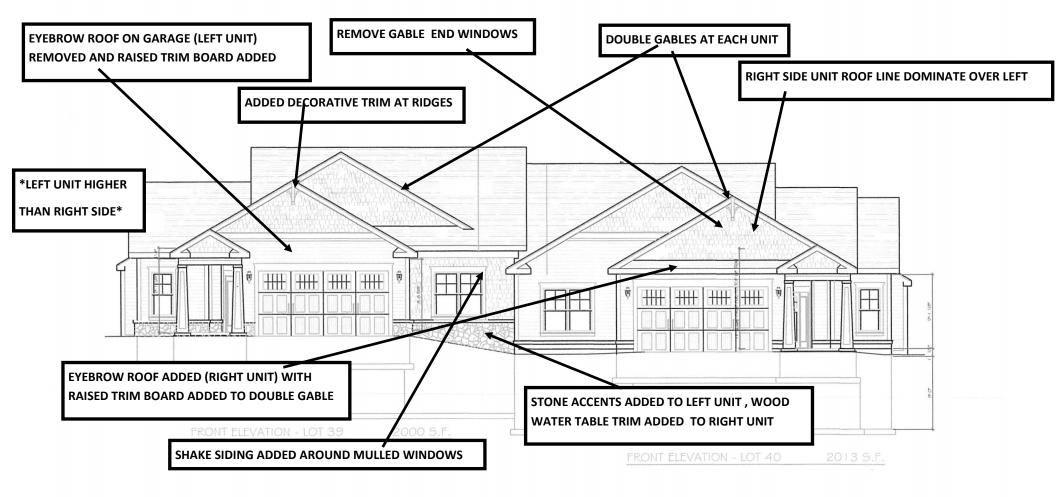
This rendering used to show color only.



THIS RENDERING USED TO SHOW GARAGE ORIENTATION ONLY



DIFFERENCES BETWEEN PROPOSED AND APPROVED UNITS



Front Elevation # 2

CONSTRUCTED

4&6 Skylight Trail



Front Elevation # 1

APPROVED & UNDER CONSTRUCTION

9&11 Skylight Trail



FRONT ELEVATION - LOT 45 2000 S.F.



Town of Pittsford

Department of Public Works 11 South Main Street Pittsford, New York 14534

Permit # B20-000095

Phone: 585-248-6250 FAX: 585-248-6262

DESIGN REVIEW AND HISTORIC PRESERVATION BOARD REFERRAL OF APPLICATION

Property Address: 40 Skylight Trail	Pittsford, NY 14534
Tax ID Number: 192.06-1-99	
Zoning District:	
Owner: S & J Morrell Builders	
Applicant: S & J Morrell Builders	

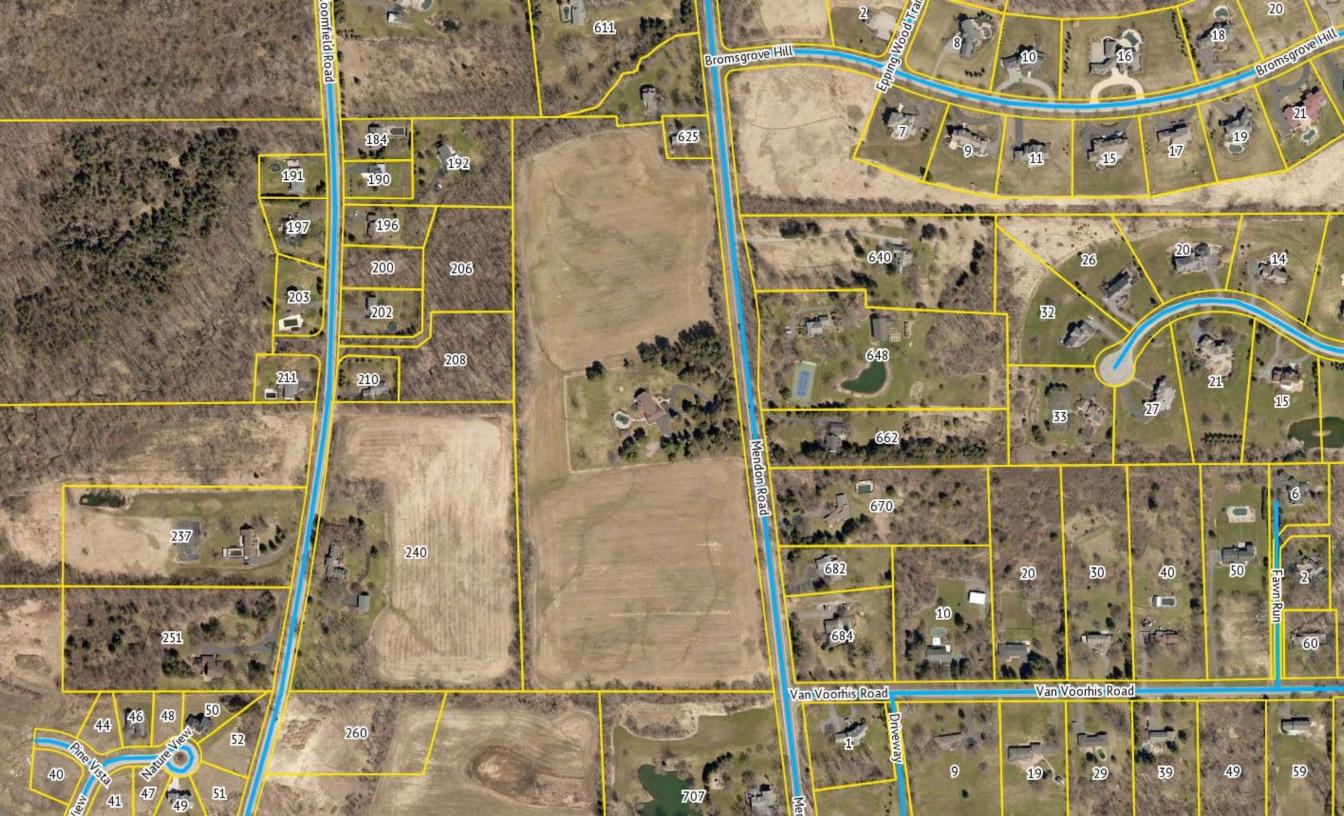
Application Type:

- Residential Design Review §185-205 (B)
- Commercial Design Review §185-205 (B)
- §185-20 Signage
- §185-205 (C)
- Certificate of Appropriateness §185-197
- Landmark Designation
- §185-195 (2)
- Informal Review

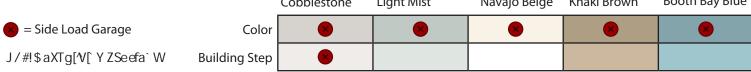
- Build to Line Adjustment §185-17 (B) (2)
- Building Height Ábove 30 Feet §185-17 (M)
- Corner Lot Orientation
- §185-17 (K) (3)
- Flag Lot Building Line Location §185-17 (L) (1) (c)
- Undeveloped Flag Lot Requirements §185-17 (L) (2)

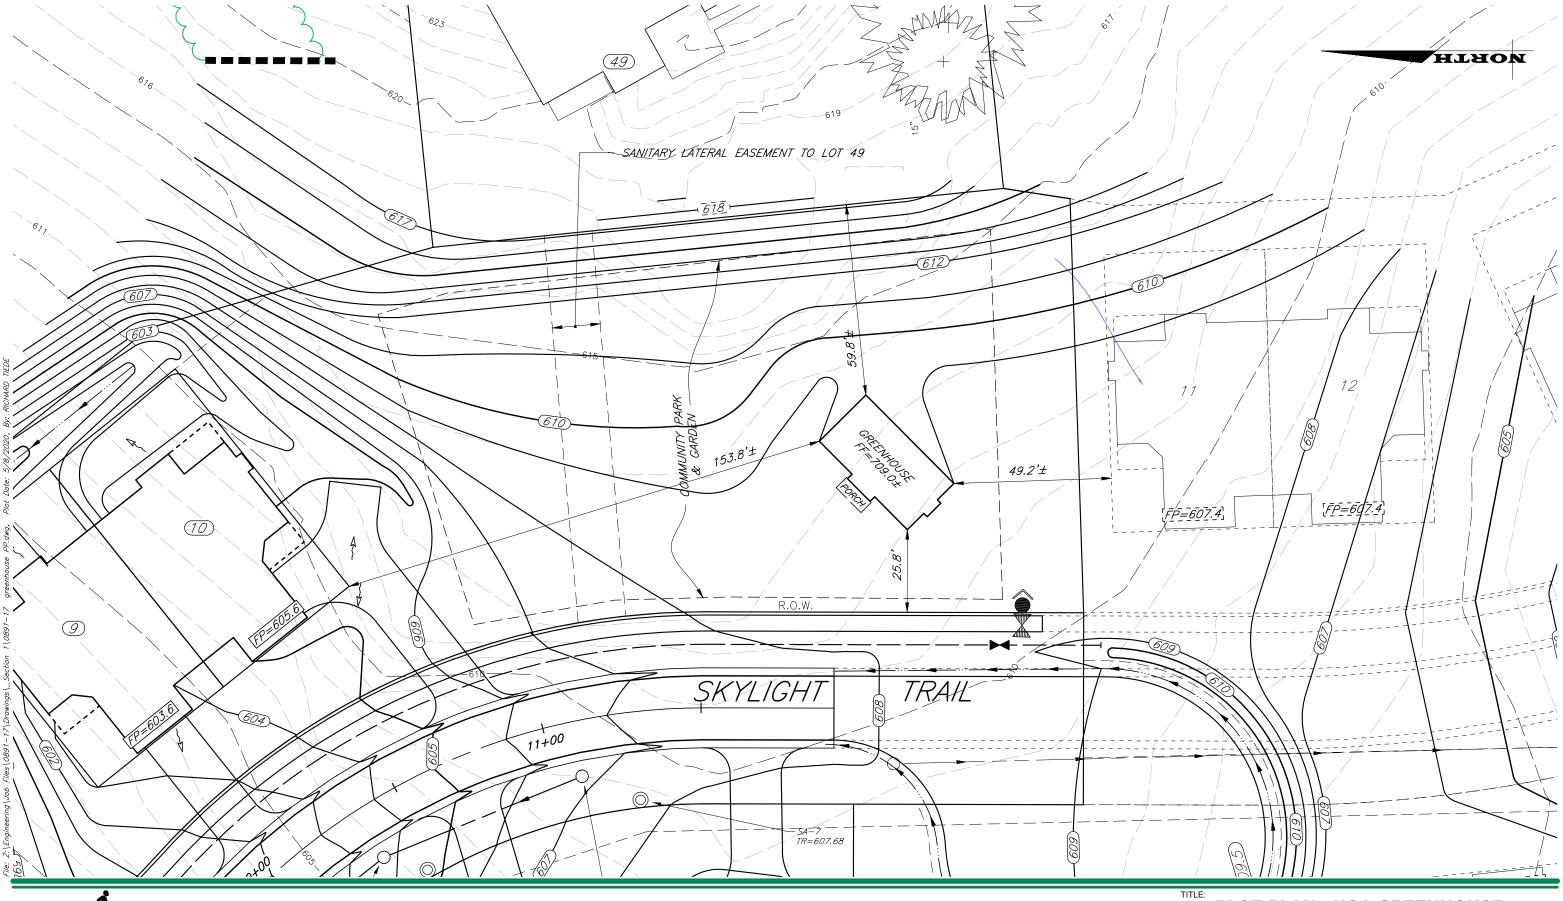
Project Description: Applicant is requesting design review for the construction of a community building. The building will be approximately 820 sq. ft. and will be located in the Alpine Ridge Subdivision.

Meeting Date: July 23, 2020











JOB NO:	0891-18
SCALE:	1" = 30'
DRAWN:	RJT
DESIGNED:	RJT
DATE:	5/8/20

SETBACK	REQUIRED	PROVIDED
FRONT	25'	25.8'

PLOT PLAN - HOA GREENHOUSE

ALPINE RIDGE - SECTION 1



DESIGN CRITERIA:

-For Greater Rochester Area and surrounding counties.

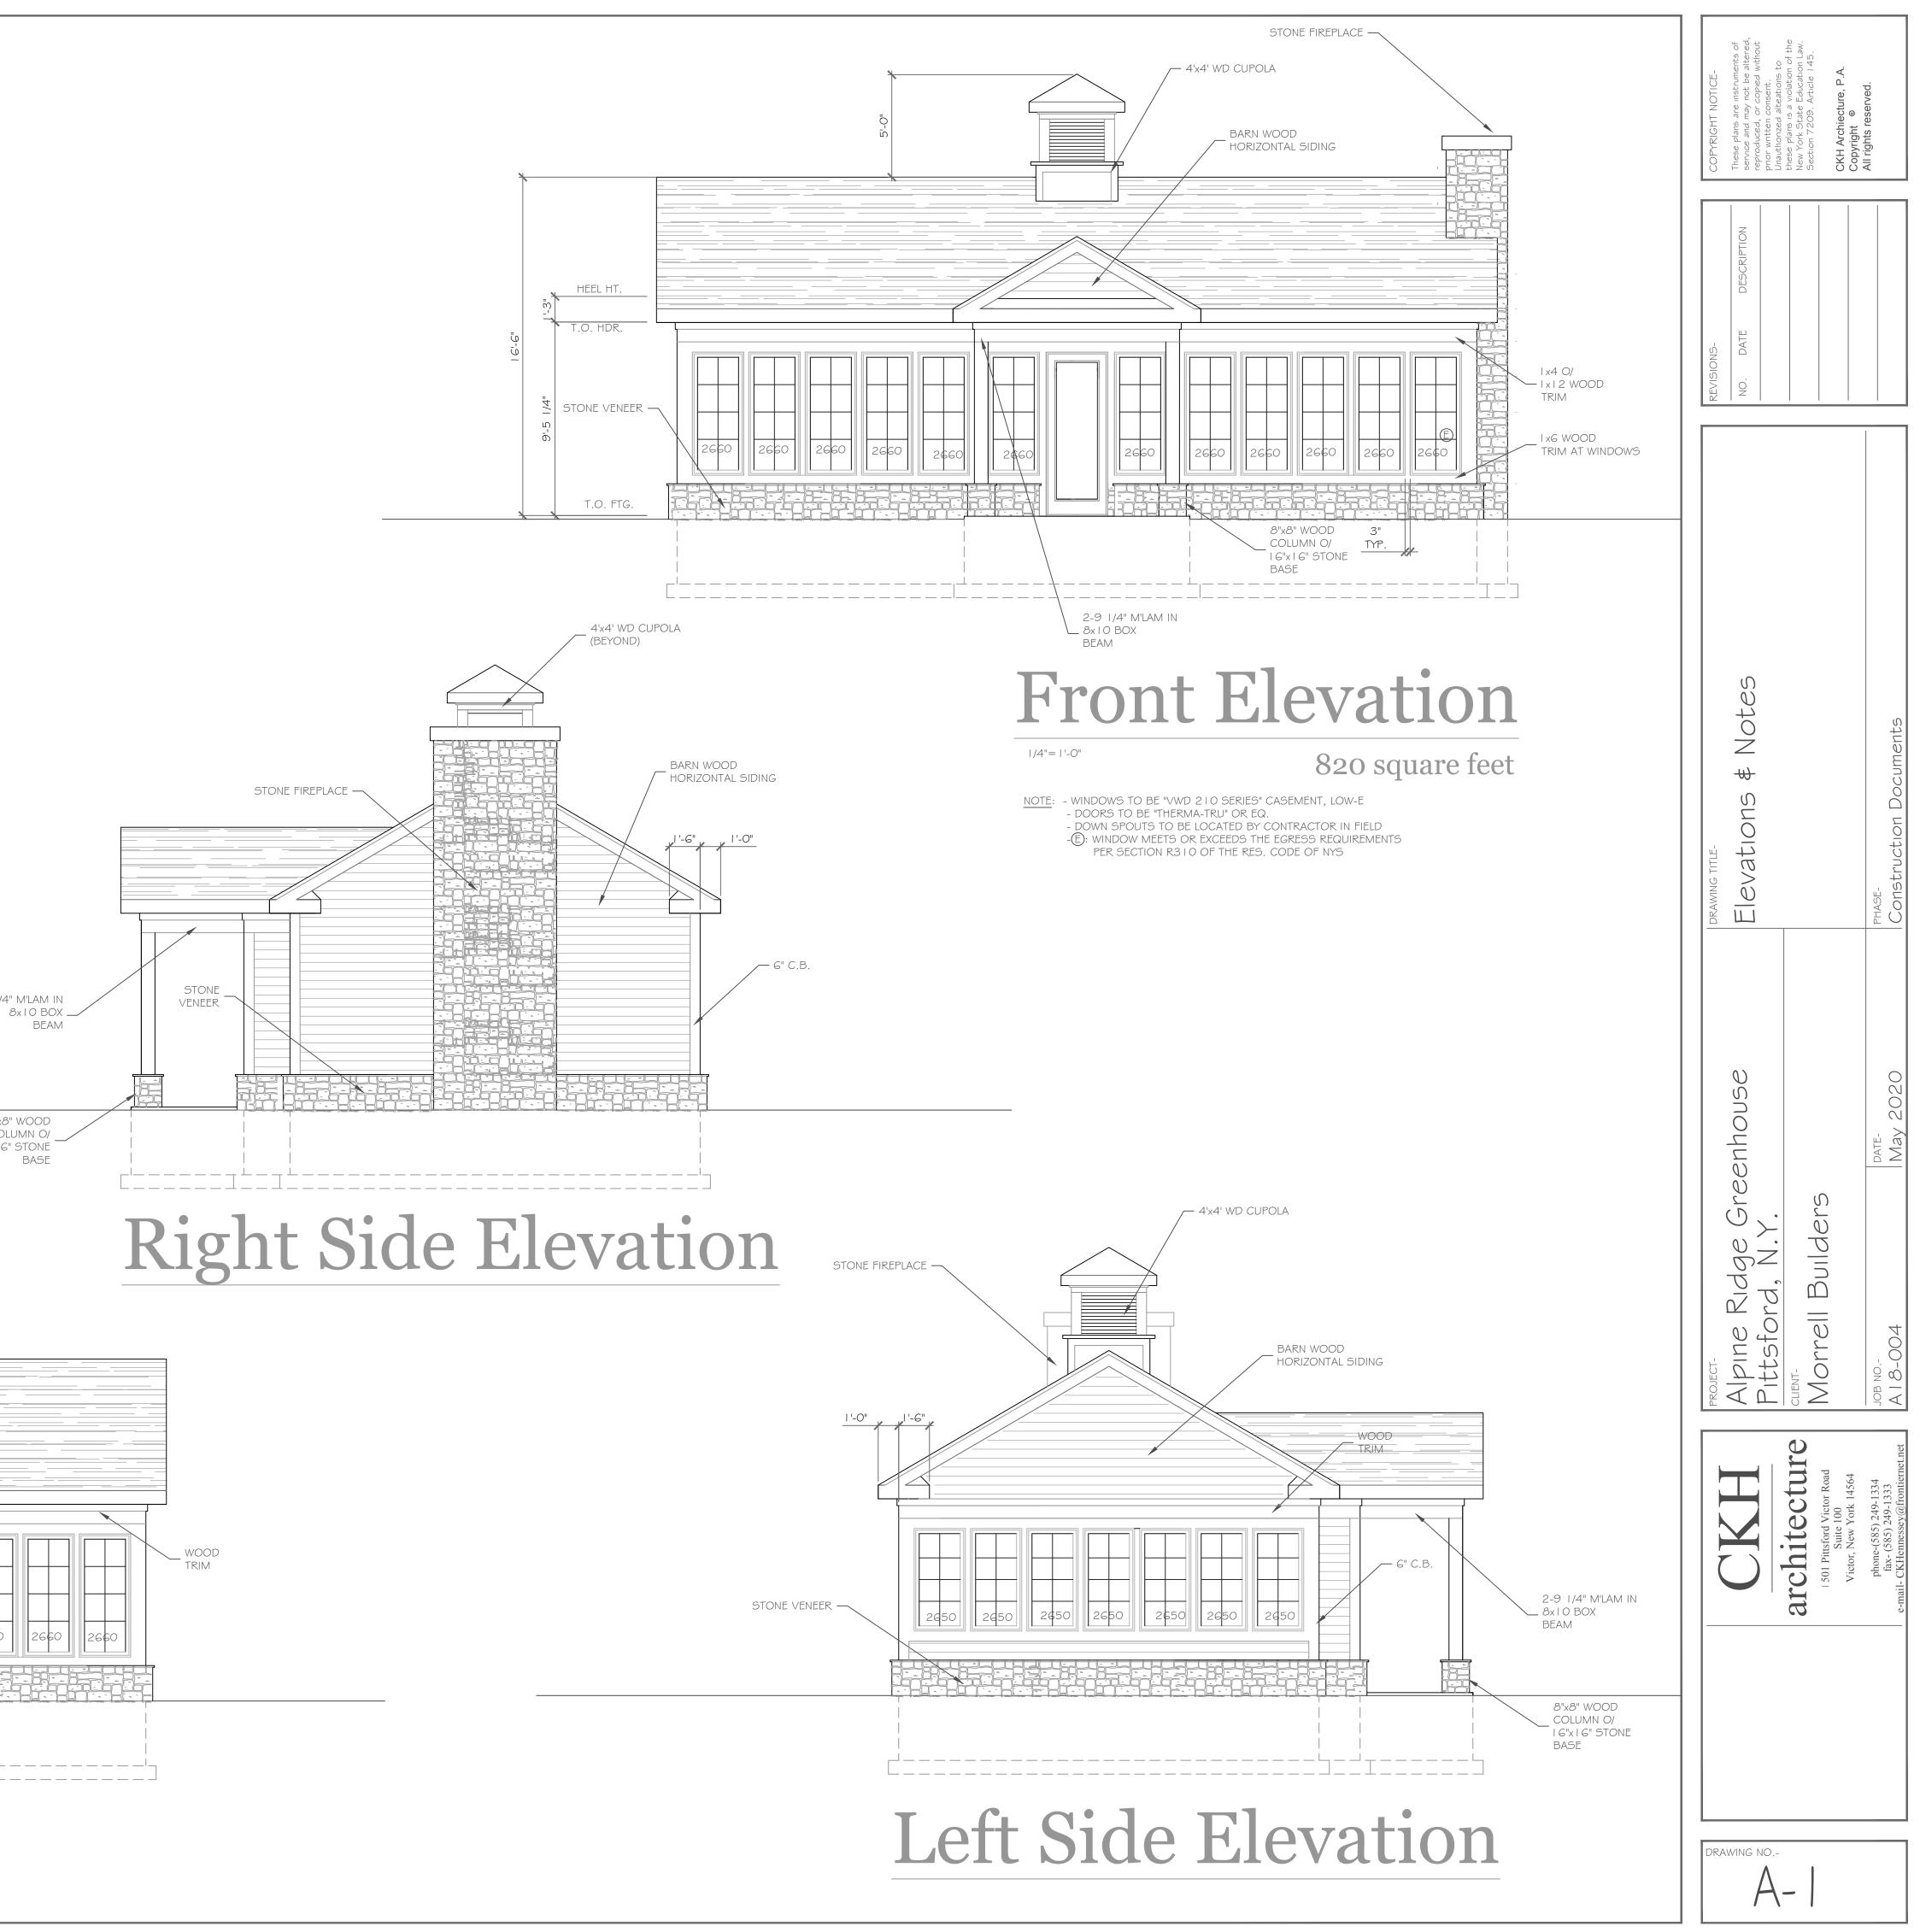
IST \$ 2ND FLOOR LIVING AREA LIVE LOAD

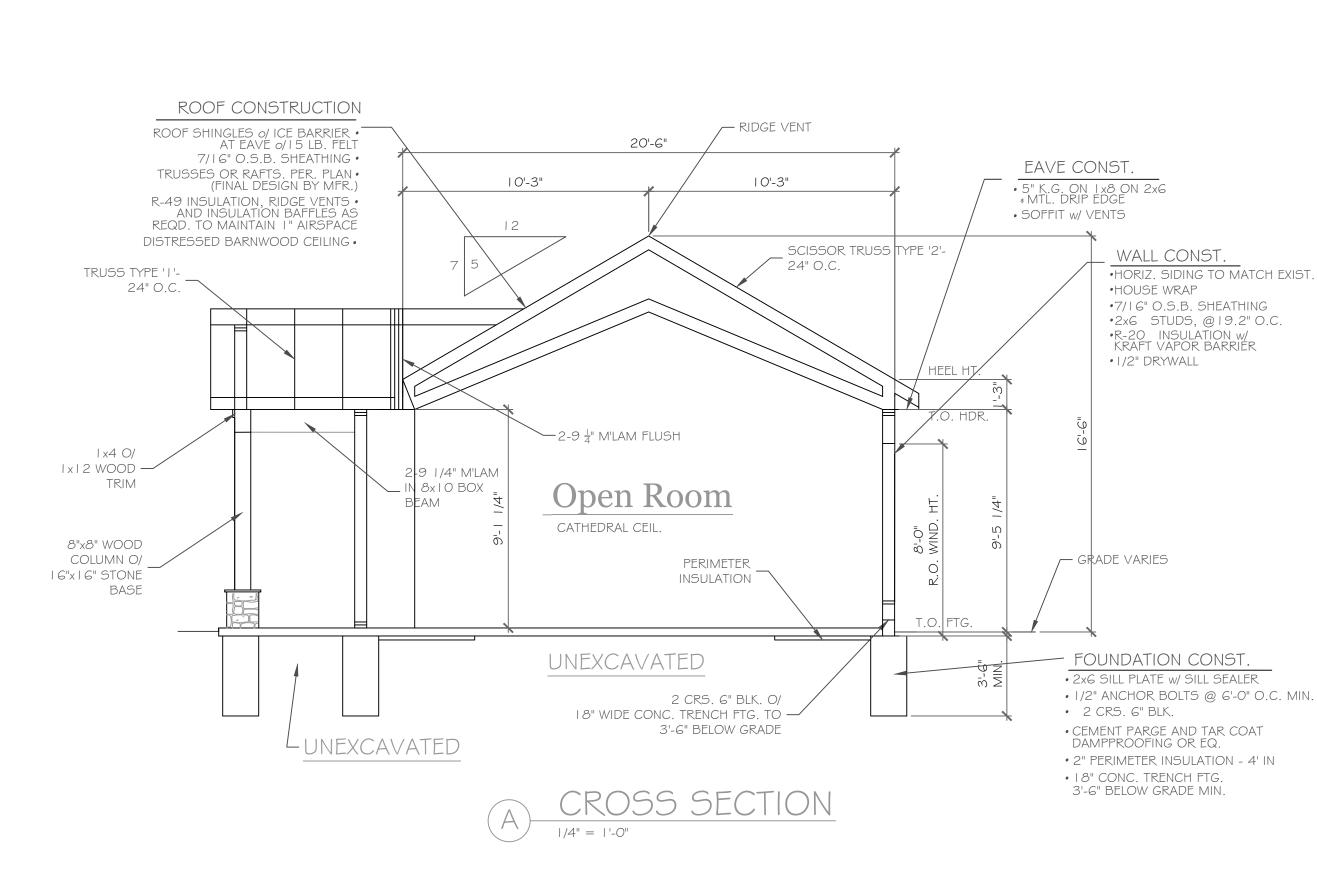
- SLEEPING AND ATTIC AREA LIVE LOAD FLOOR DEAD LOAD
- GROUND SNOW LOAD
- ROOF DEAD LOAD
- ALLOWABLE SOIL BEARING
- WIND SPEED
- SEISMIC DESIGN
- WEATHERING
- FROST DEPTH LINE
- TERMITE DAMAGE
- DECAY DAMAGE
- WINTER DESIGN TEMPERATURE
- ICE SHIELD UNDERLAYMENT
- FLOOD HAZARD ROOF TIE DOWN REQUIREMENTS

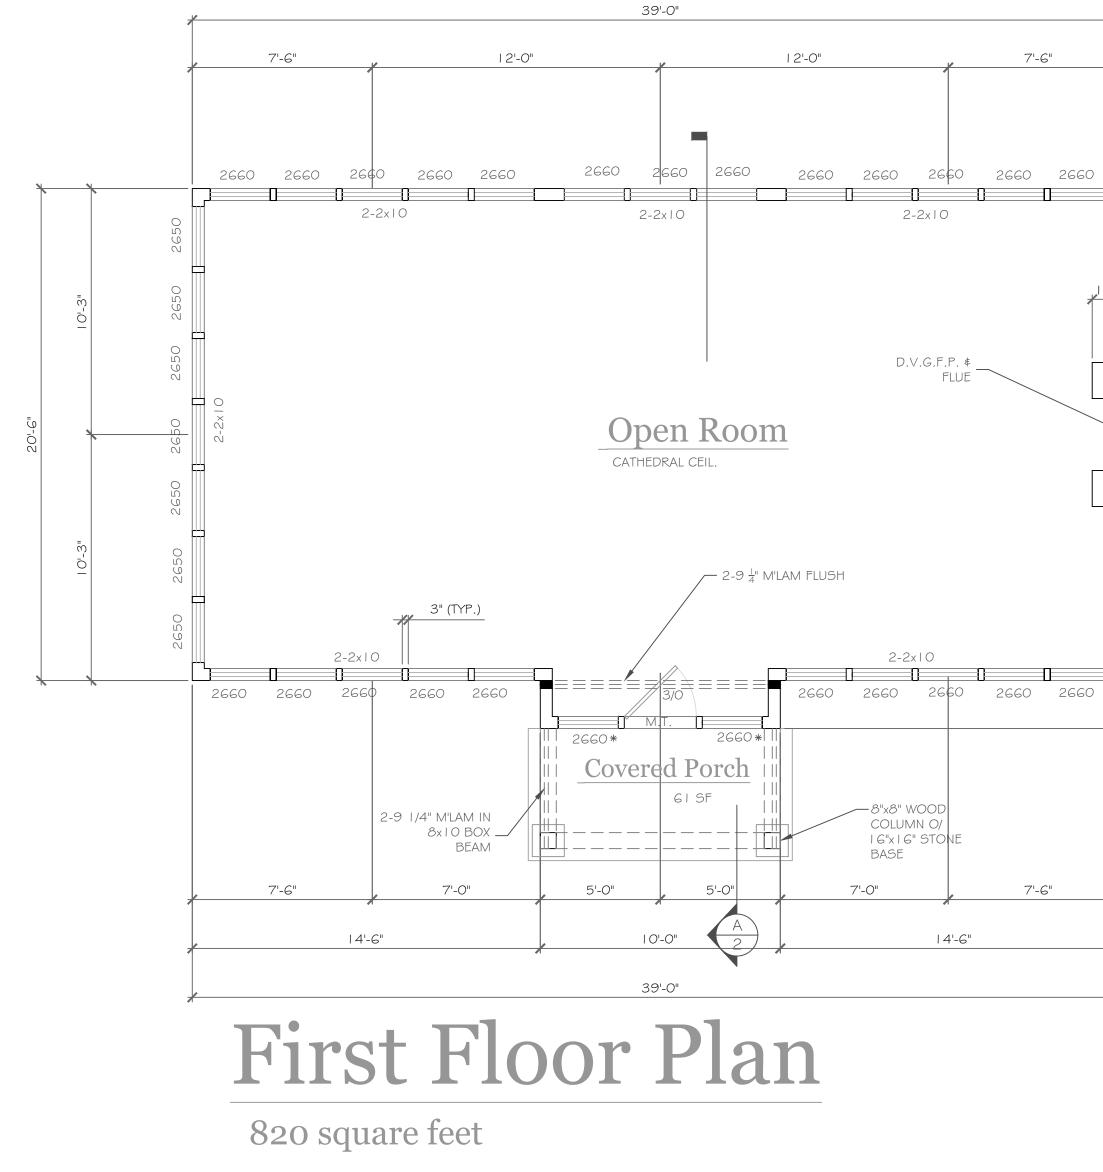
40 PSF

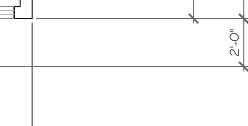
- 30 PSF
- 15 PSF
- 40 PSF
- IO PSF
- 2500 PSF AT MINIMUM 42" BELOW FINISHED GRADE
- I I 5 MPH, EXPOSURE B
- CATEGORY B
- SEVERE
- 42 INCHES
- SLIGHT TO MODERATE
- NONE TO SLIGHT
- I DEGREE
- REQUIRED 24" INSIDE OF EXTERIOR WALL LINE
- FIRM 1992
- R802.11, BASED UPON SPECIFIC ROOF DESIGN
- 2-9 1/4" M'LAM IN

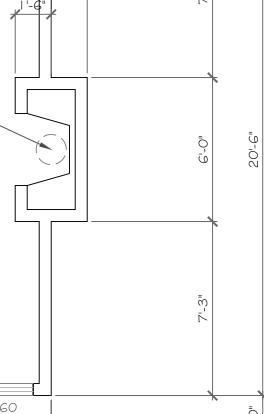
8"x8" WOOD COLUMN O/ I 6"x I 6" STONE BASE - 4'x4' WD CUPOLA STONE FIREPLACE — STONE VENEER — 2660 2660 2660 2660 2660 2660 2660 2660 _____ **Rear Elevation**

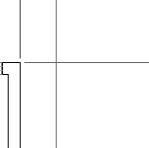


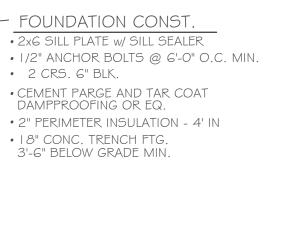


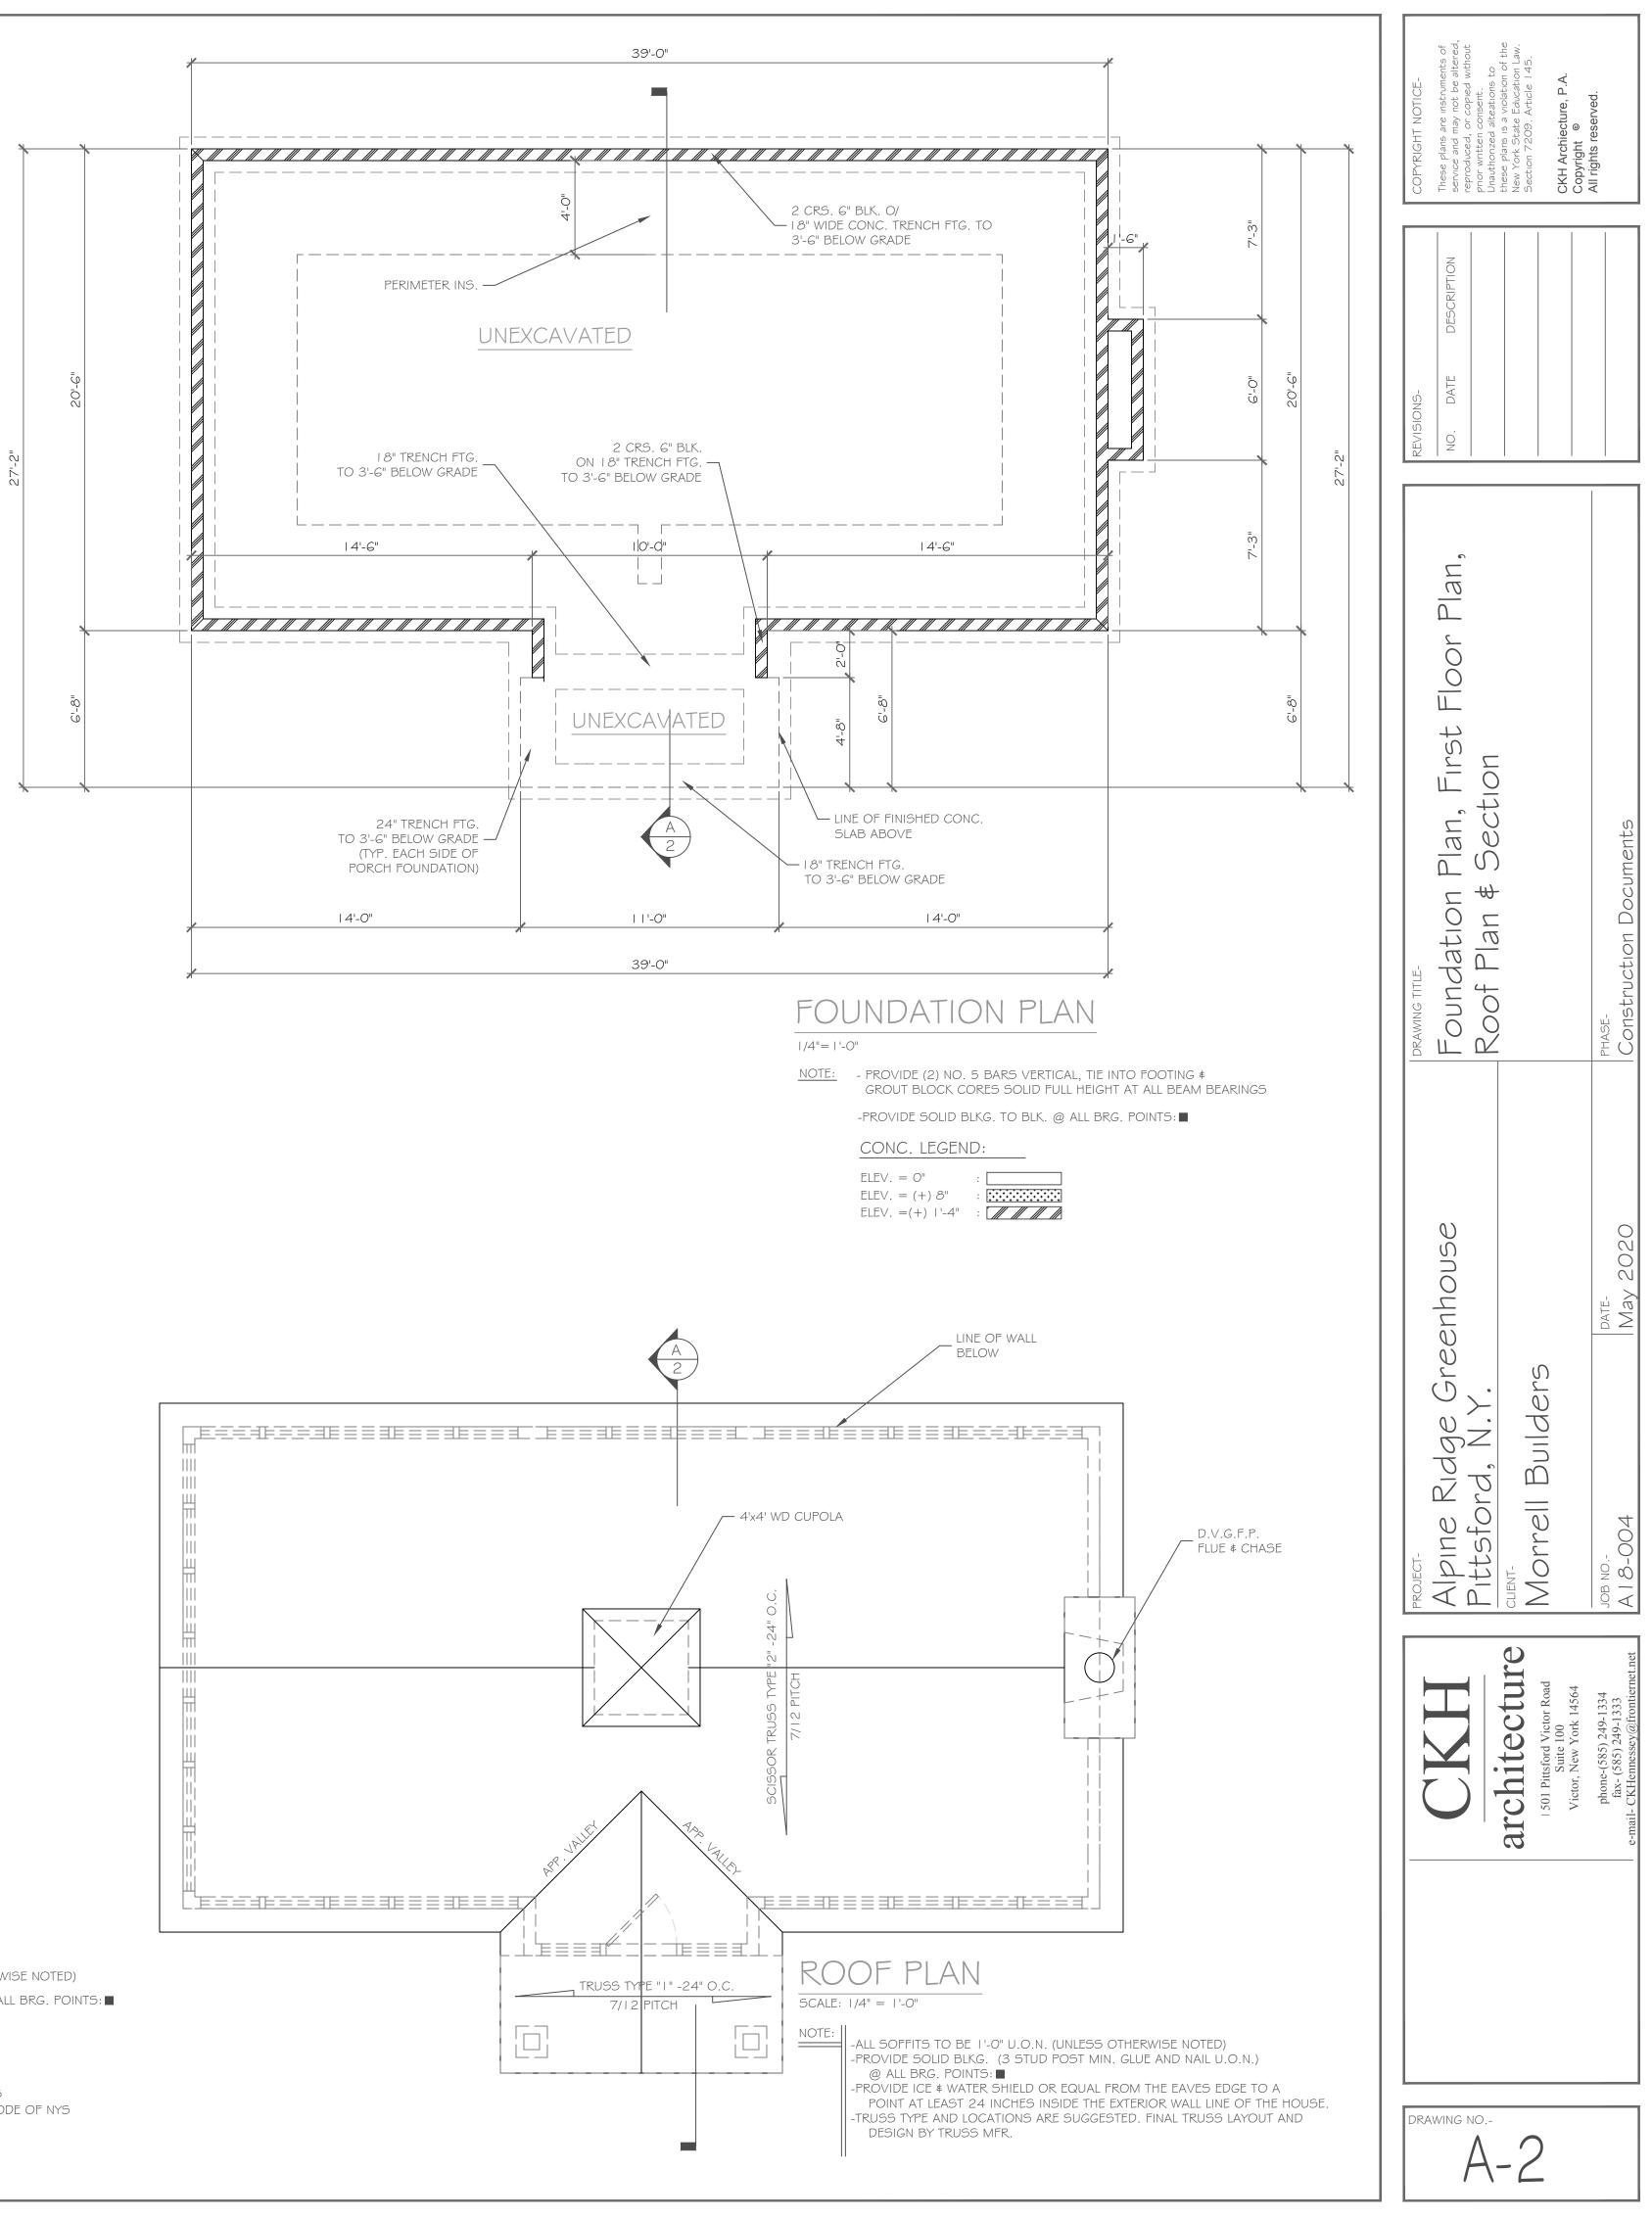


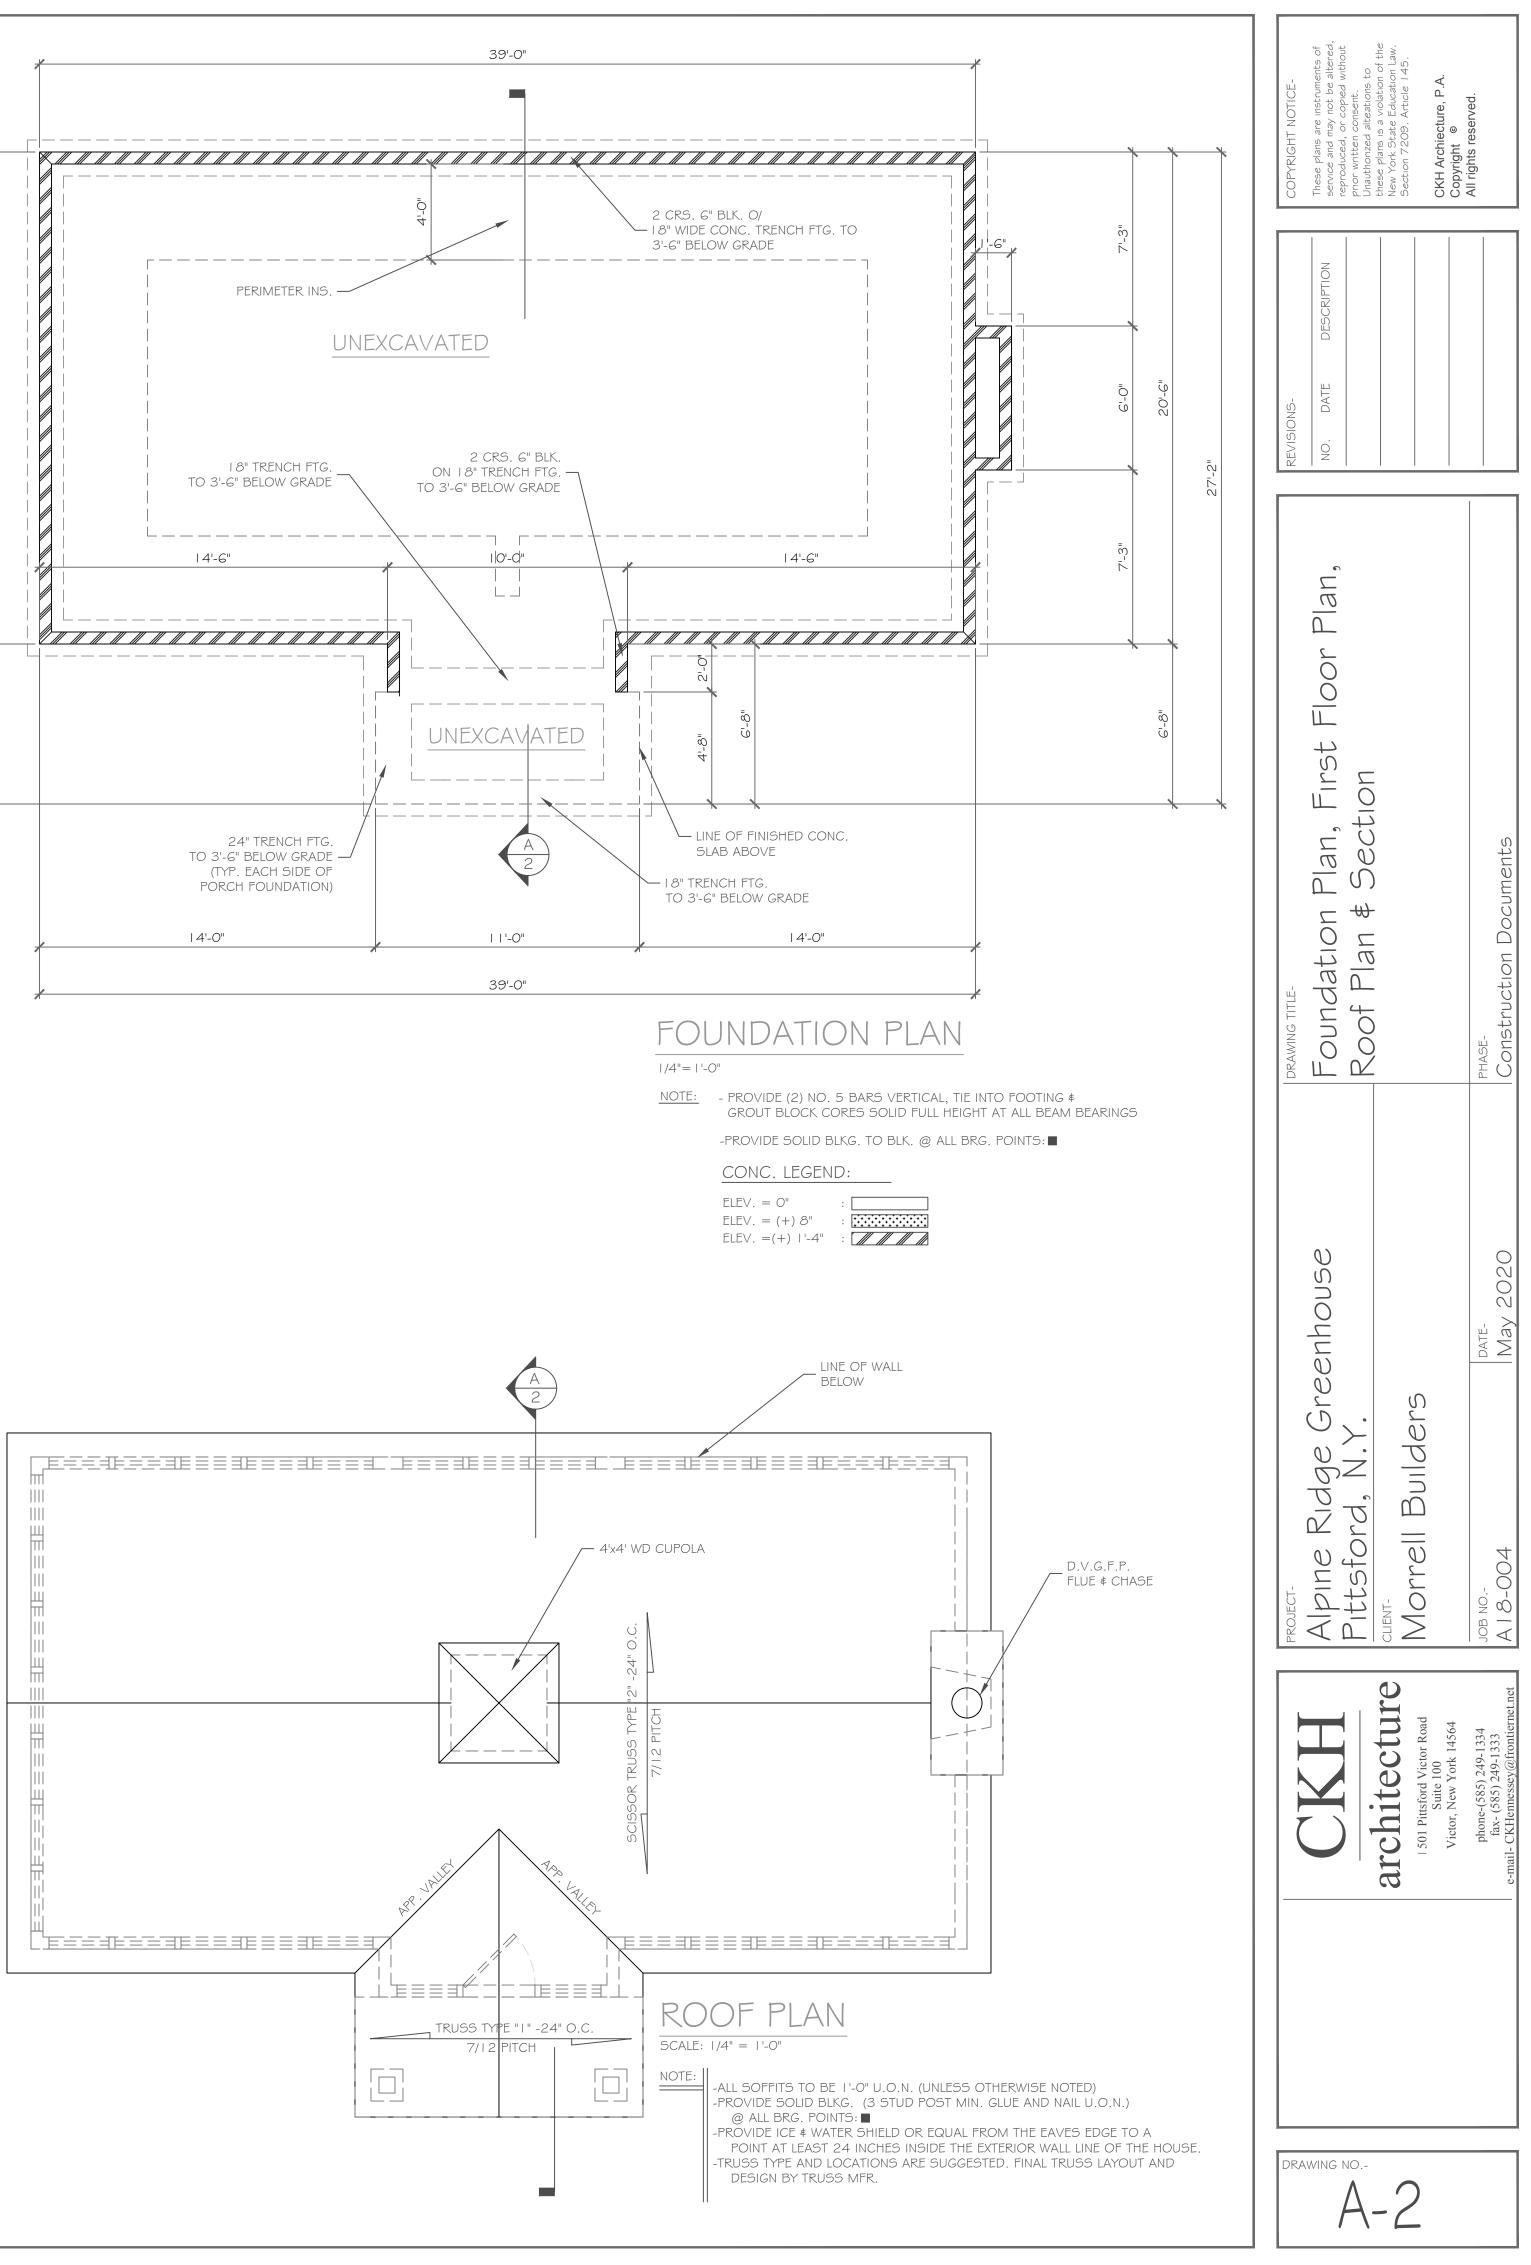












NOTES:

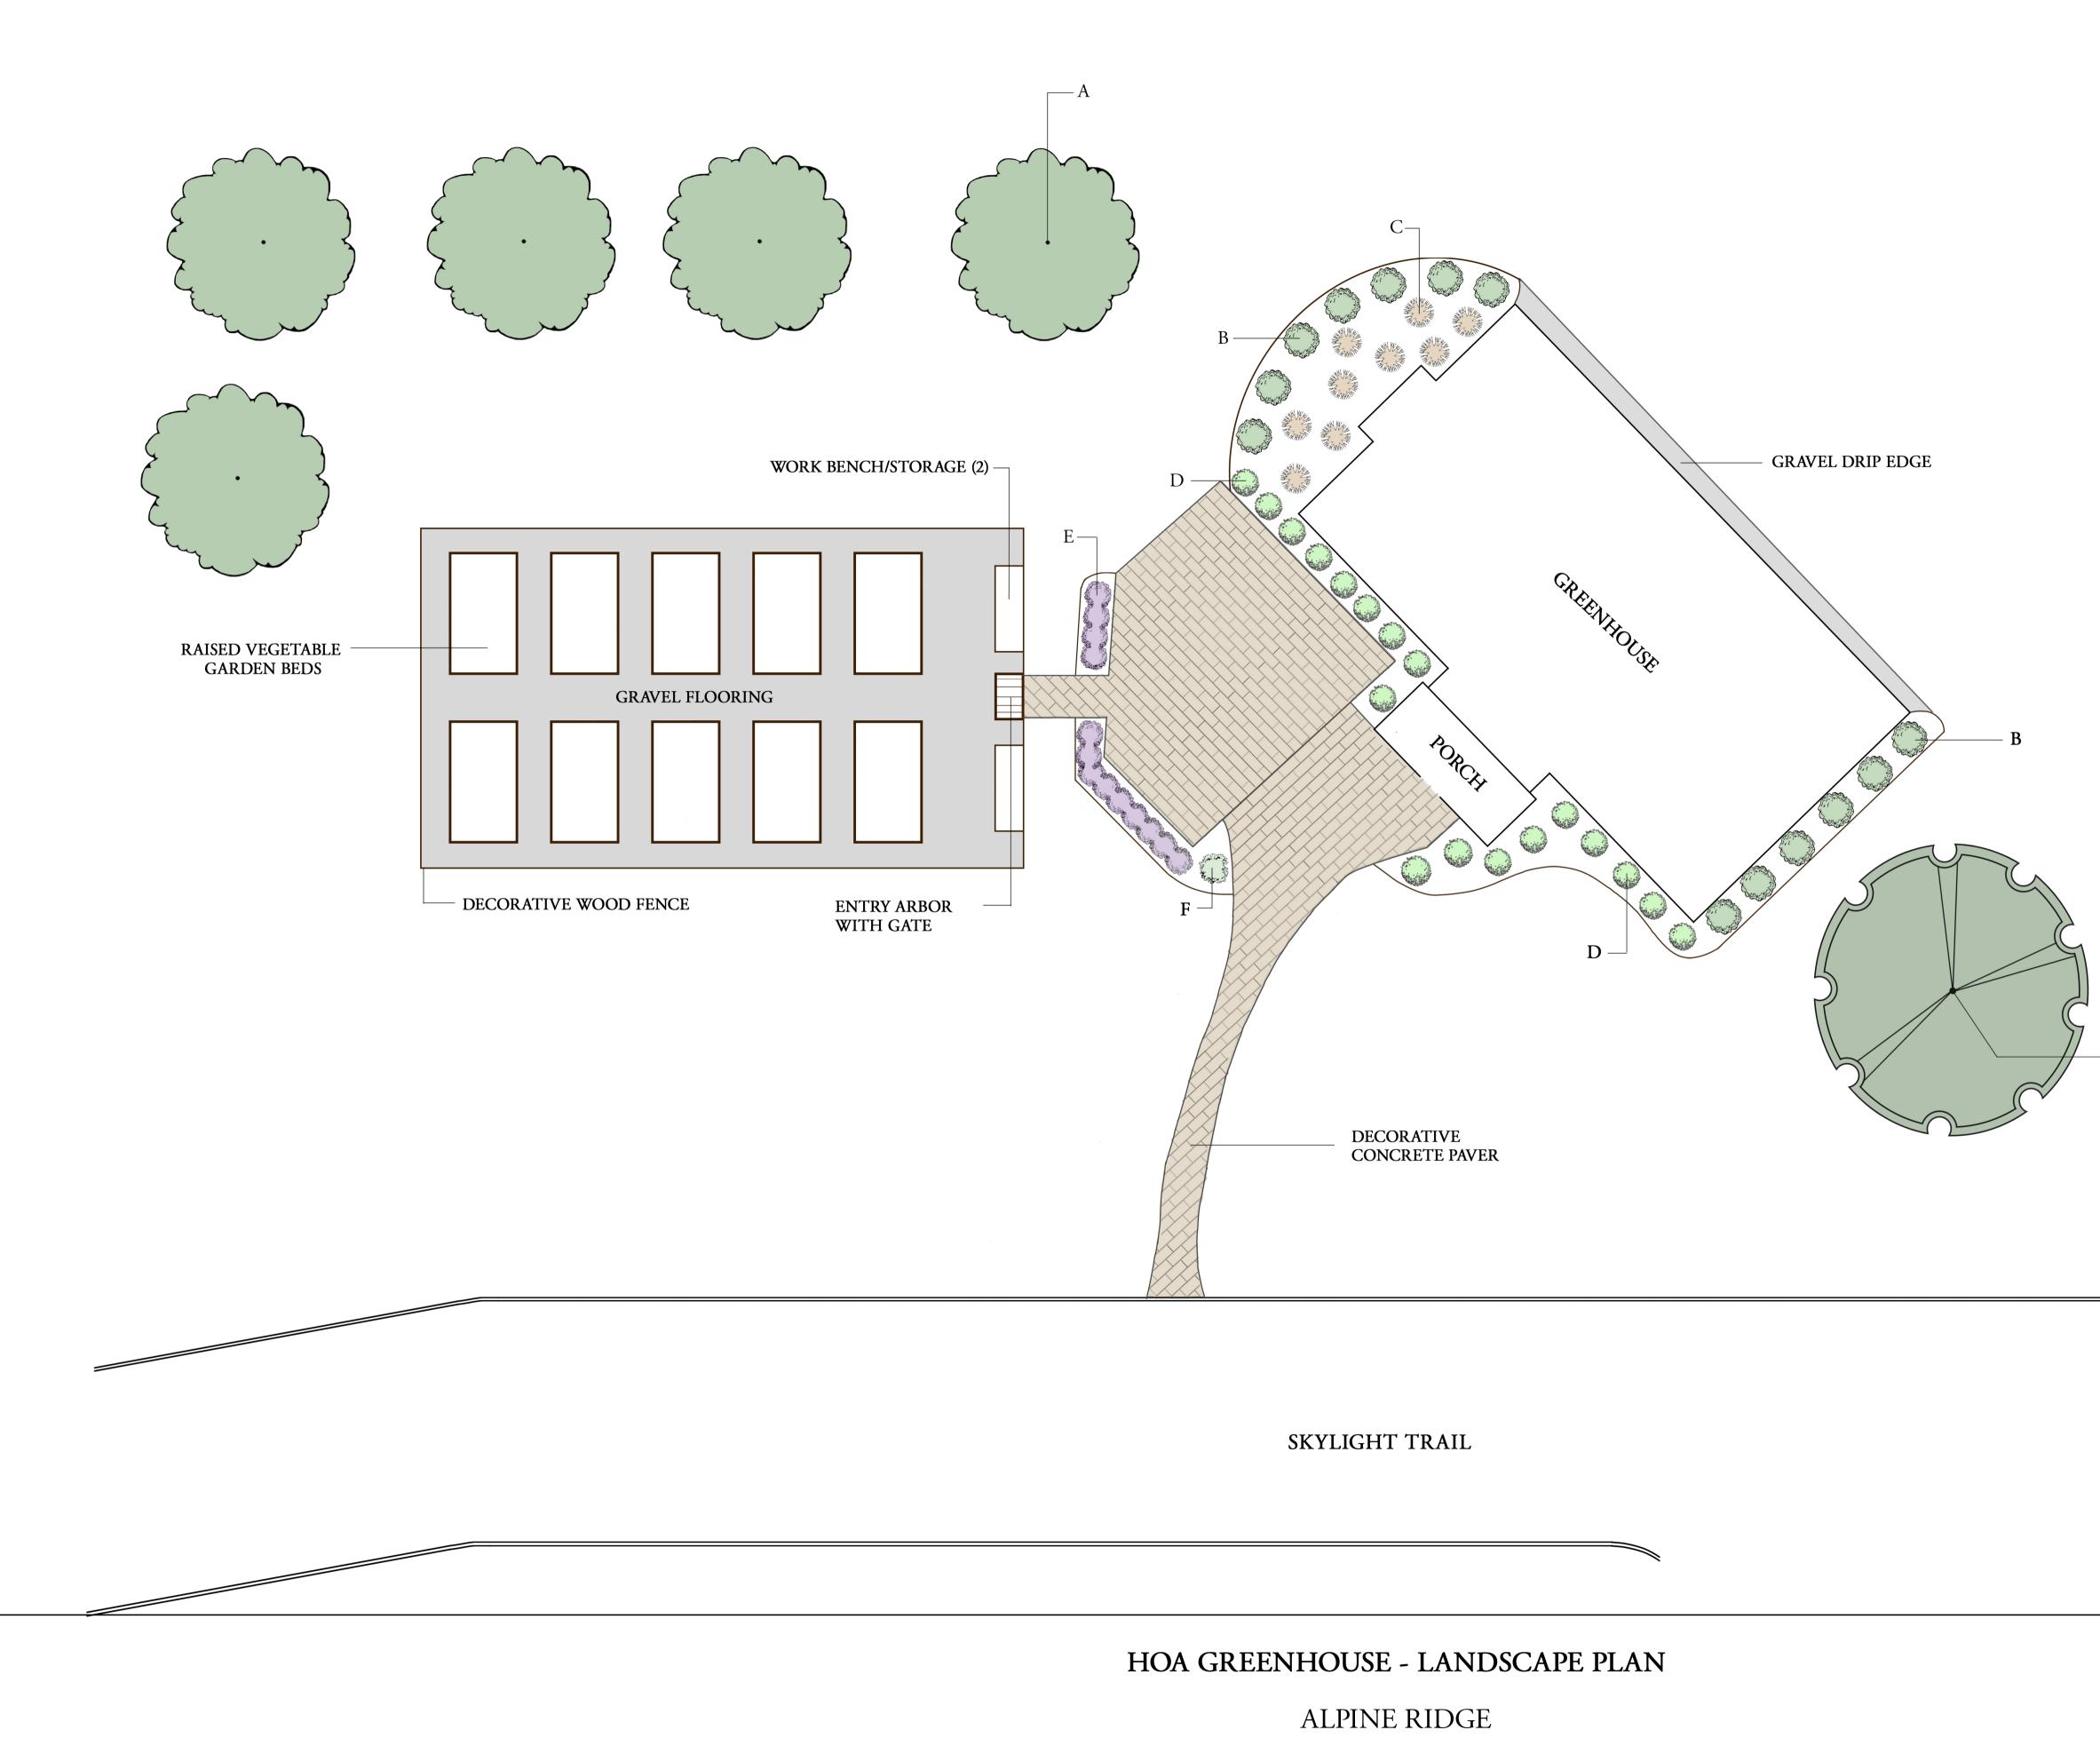
EXTERIOR WALLS TO BE 2 x 6 - I 6" O.C. U.O.N. (UNLESS OTHERWISE NOTED) PROVIDE SOLID BLKG. (3 STUD POST MIN. GLUE AND NAIL) @ ALL BRG. POINTS: WINDOW R.O. HTS. TO BE 7'-4 1/2" U.O.N. CEILING HTS. TO BE 9'-1 1/8" U.O.N.

UNSPECIFIED HDRS. TO BE 2-2x8 MIN.

(E):WINDOW MEETS OR EXCEEDS THE EGRESS REQUIREMENTS

PER SECTION R310 OF THE RES. CODE OF NYS


* : SAFETY GLASS REQ. PER SECTION R308.4 OF THE RES. CODE OF NYS DBL. JACK STUDS @ ALL LOAD BRG. LINTELS OVER 4' LONG



PLANT KEY

- A. (5) 1.5" APPLE TREES
- B. (13) 18-25" BOXWOOD 'WINTER GEM'
- C. (9) #3 KARL FOERSTER GRASS
- D. (18) 15-18" POTENTILLA 'MCKAY'S WHITE'
- E. (15) #1 LAVENDER
- F. (1) 15-18" OAKLEAF HYDRANGEA
- G (1) 3" SCARLET OAK

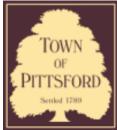G



Town of Pittsford

Department of Public Works 11 South Main Street Pittsford, New York 14534

Permit # RA20-000113

Phone: 585-248-6250 FAX: 585-248-6262

DESIGN REVIEW AND HISTORIC PRESERVATION BOARD REFERRAL OF APPLICATION

Property Address: 25 Parker Drive PITTSFORD, NY 14534 Tax ID Number: 164.10-2-67 Zoning District: RN Residential Neighborhood Owner: Hamilton, Justin K Applicant: Hamilton Stern

Application Type:

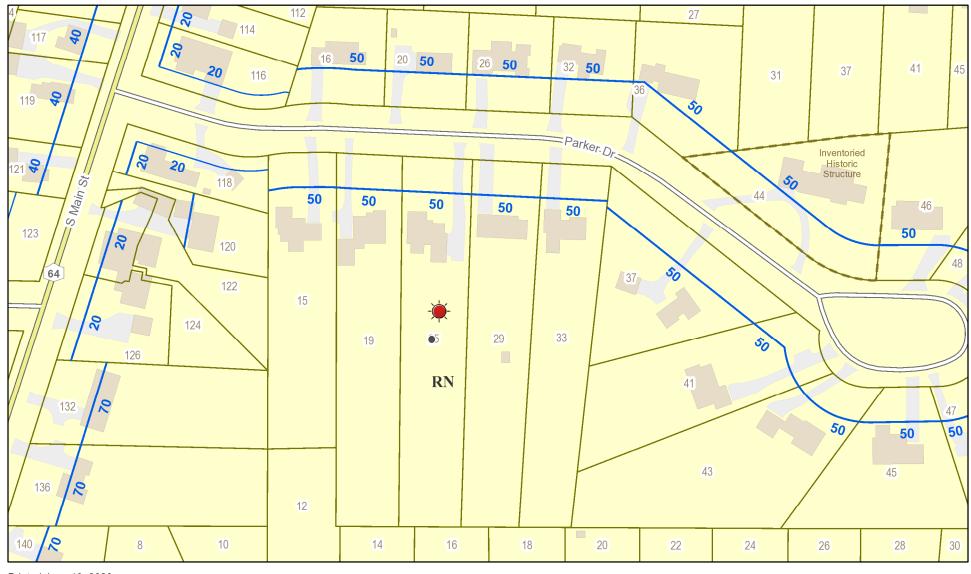
- Residential Design Review
- §185-205 (B) Commercial Design Review
- §185-205 (B)
- Signage
- └ §185-205 (C)
- Certificate of Appropriateness
- ^{__} §185-197
- Landmark Designation
- §185-195 (2)
- Informal Review

- Build to Line Adjustment
- ^{___} §185-17 (B) (2)
- Building Height Above 30 Feet §185-17 (M)
- Corner Lot Orientation
- §185-17 (K) (3)
- Flag Lot Building Line Location
- └└ §185-17 (L) (1) (c)
- Undeveloped Flag Lot Requirements §185-17 (L) (2)


Project Description: The applicant is requesting Design Review for the Proposed construction of an addition and an oversized accessory structure. The proposed construction is a 2 story 1,007 Sq. Ft. addition and a 468 Sq. Ft. workshop/Storage structure. The addition will create living space and a new garage. The Zoning Board of Appeals has heard these applications on July 20, 2020.

Meeting Date: July 23, 2020

RN Residential Neighborhood Zoning




Printed June 19, 2020

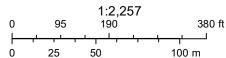


Town of Pittsford GIS
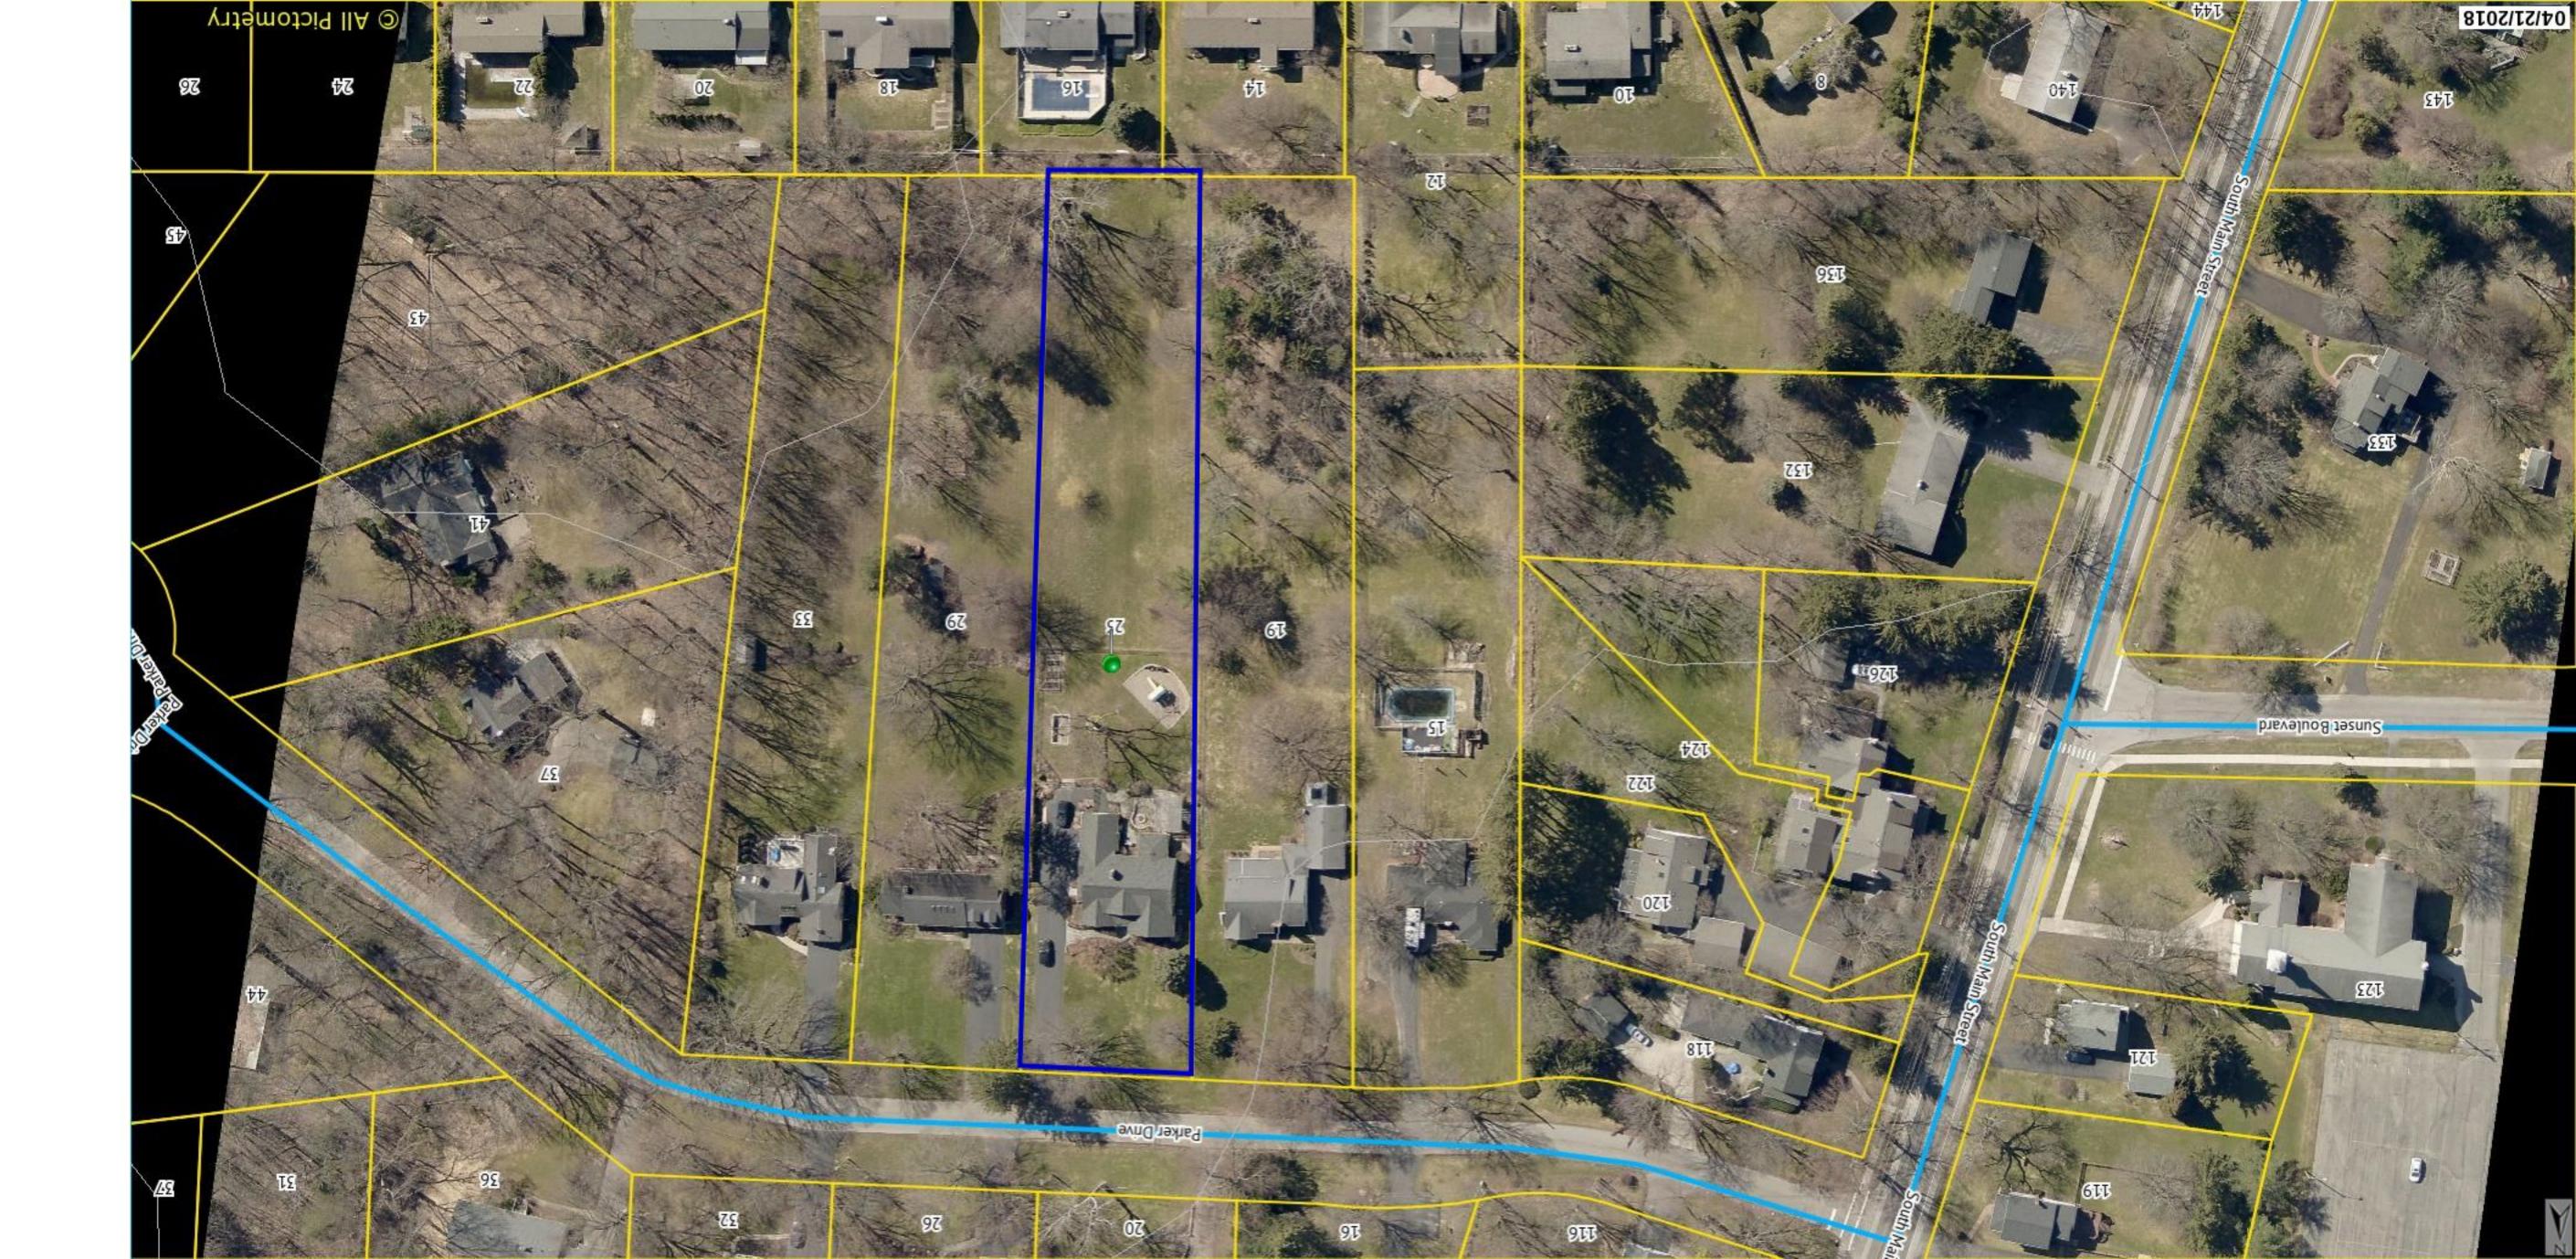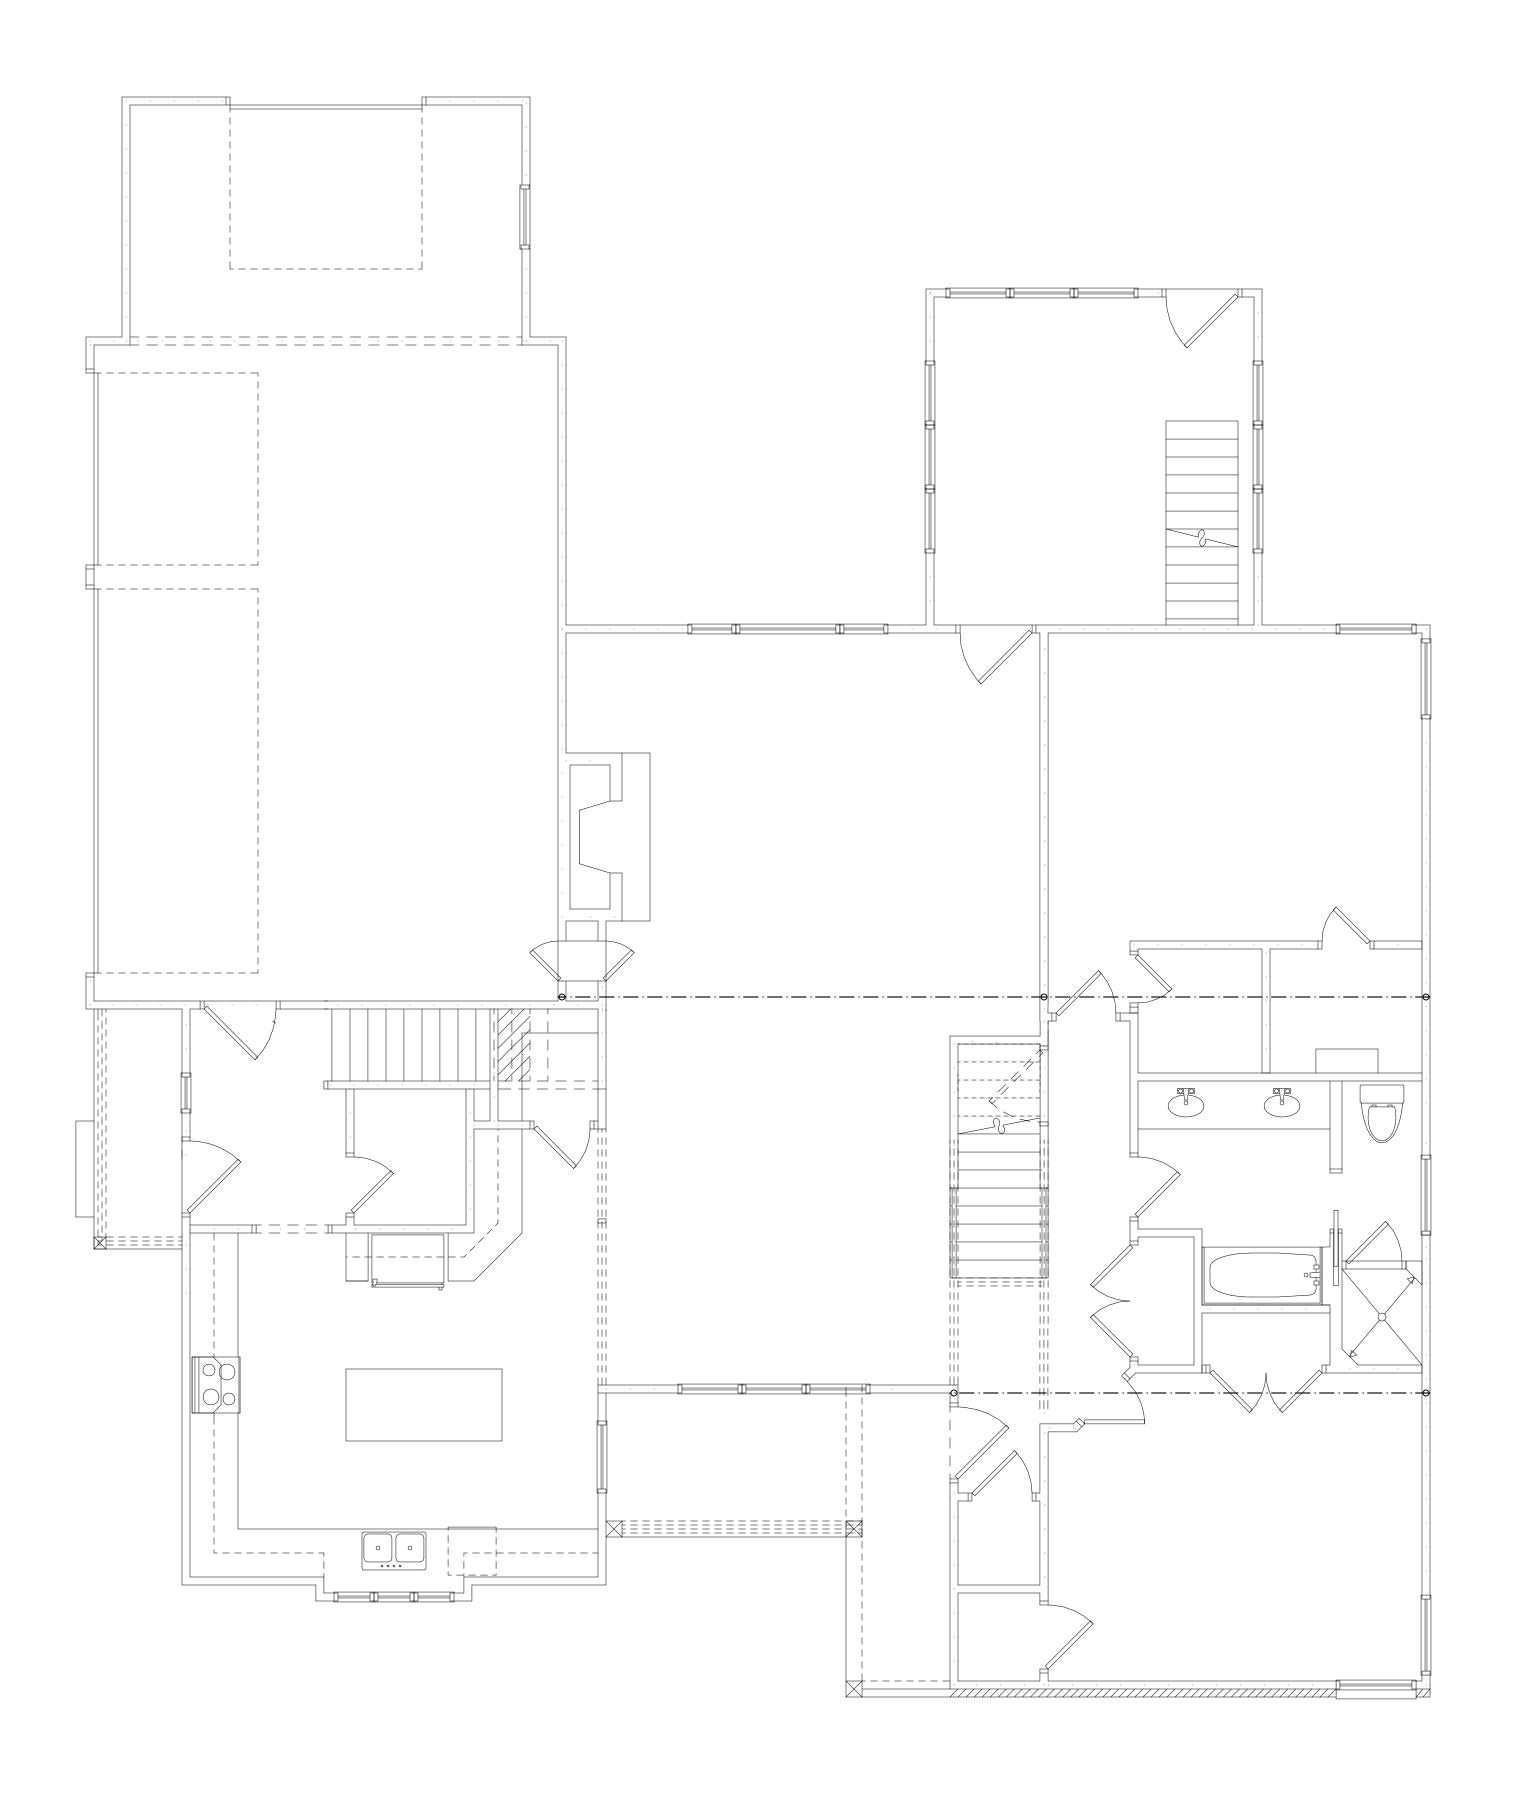
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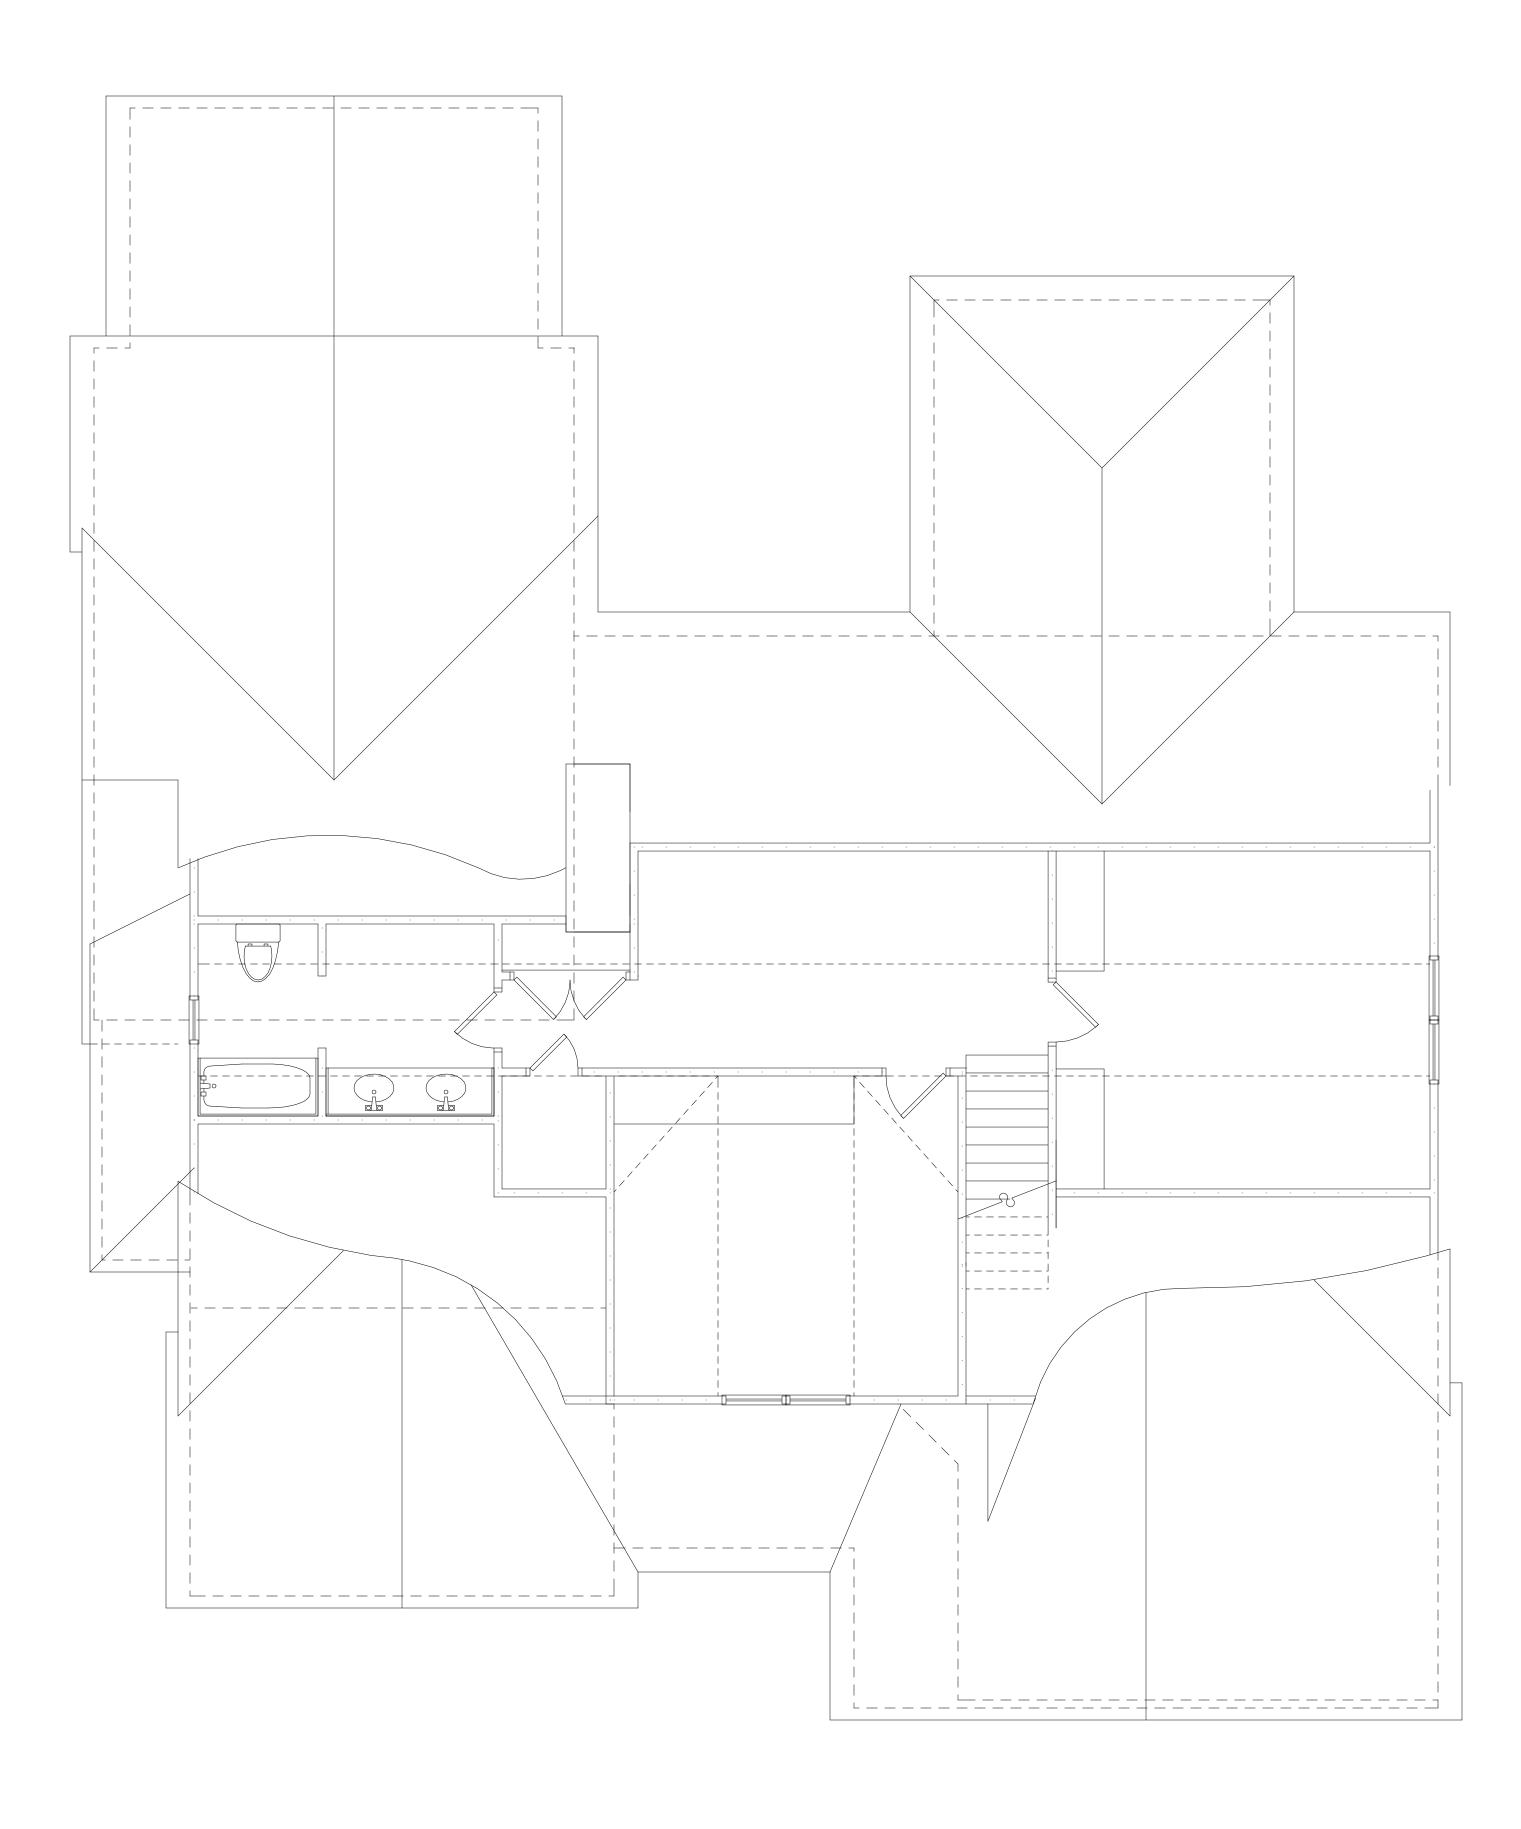
REMOVAL	LEGEND			
· · ·	EXISTING WALL TO REMAIN			
	EXISTING WALL TO BE REMOVED			
	EXISTING DOOR TO REMAIN			
	EXISTING DOOR TO BE REMOVED			
	EXISTING WINDOW TO REMAIN			
XXX [====== [XXX [*]	EXISTING WINDOW TO BE REMOVED			
*NOTE: SAVE ALL DOORS / WINDOWS FOR POSSIBLE REUSE				



FIRST FLOOR PLAN/ EXISTING

EXISTING AREA: 1596 SQ FT

PATRICK J. MORABITO **A.I.A.** ARCHITECT **P.C.** 55 Sully's Trail Pittsford, NY 14534 (585) 264-1330 (585) 264-1333 Fax www.pjmarchitect.com **NOTICE:** IT IS A VIOLATION OF LAW FOR ANY PERSON, UNLESS ACTING UNDER THE SUPERVISION OF A LICENSED ARCHITECT TO ALTER ANY ITEM ON THIS DOCUMENT IN ANY WAY. ANY LICENSEE WHO ALTERS THIS DOCUMENT IS AND THE NOTATION "ALTERS THIS DOCUMENT IS REQUIRED BY LAW TO FIX HIS OR HER SEAL AND THE NOTATION "ALTERED BY" FOLLOWED BY HIS OR HER SIGNATURE AND A SPECIFIC DESCRIPTION OF THE ALTERATIONS. THESE DRAWINGS ARE COPYRIGHTED AND ARE SUBJECT TO COPYRIGHT PROTECTION AS AN "ARCHITECTURAL WORK" UNDER SEC. 102 OF THE COPYRIGHT ACT, 17 U.S.O. AS AMENDED DECEMBER 1990 AND KNOWN AS ARCHITECTURAL WORKS COPYRIGHT PROTECTION ACT OF 1990. THE PROTECTION INCLUDES BUT IS NOT LIMITED TO THE OVERALL FORM AS WELL AS THE ARRANGEMENT AND COMPOSITION OF SPACES AND ELEMENTS OF THE DESIGN. UNDER SUCH PROTECTION, UNAUTHORIZED USE OF THESE DRAWINGS OR WORK REPRESENTED HEREIN, CAN LEGALLY RESULT IN THE CESSATION OF CONSTRUCTION OR BUILDINGS BEING SEIZED AND/OR MONETARY COMPENSATION TO PATRICK J. MORABITO, A.I.A. ARCHITECT P.C. NO FURTHER USE OR DISTRIBUTION IS ALLOWED WITHOUT THE WRITTEN PERMISSION AND CONSENT OF PATRICK J. MORABITO, A.I.A. ARCHITECT P.C. COPYRIGHT 2008 PATRICK J. MORABITO, A.I.A. ARCHITECT P.C. PROJECT: ADDITION TO HAMILTON RESIDENCE 25 PARKER DRIVE CLIENT: HAMILTON/ STERN BUILDERS **DRAWING:** FIRST FLOOR PLAN EXISTING **CHECKED: DRAWN:** PJM MGM DATE: MAY 2020 |/4"=|'-0" SCALE: JOB NO .: 2020HAMILTON SHEET: **E-3** of **10** sheets



SECOND FLOOR PLAN/ EXISTING PROPOSED AREA: 795 SQ FT



PATRICK J. MORABITO **A.I.A.** ARCHITECT **P.C.**

55 Sully's Trail Pittsford, NY 14534

(585) 264-1330 (585) 264-1333 Fax

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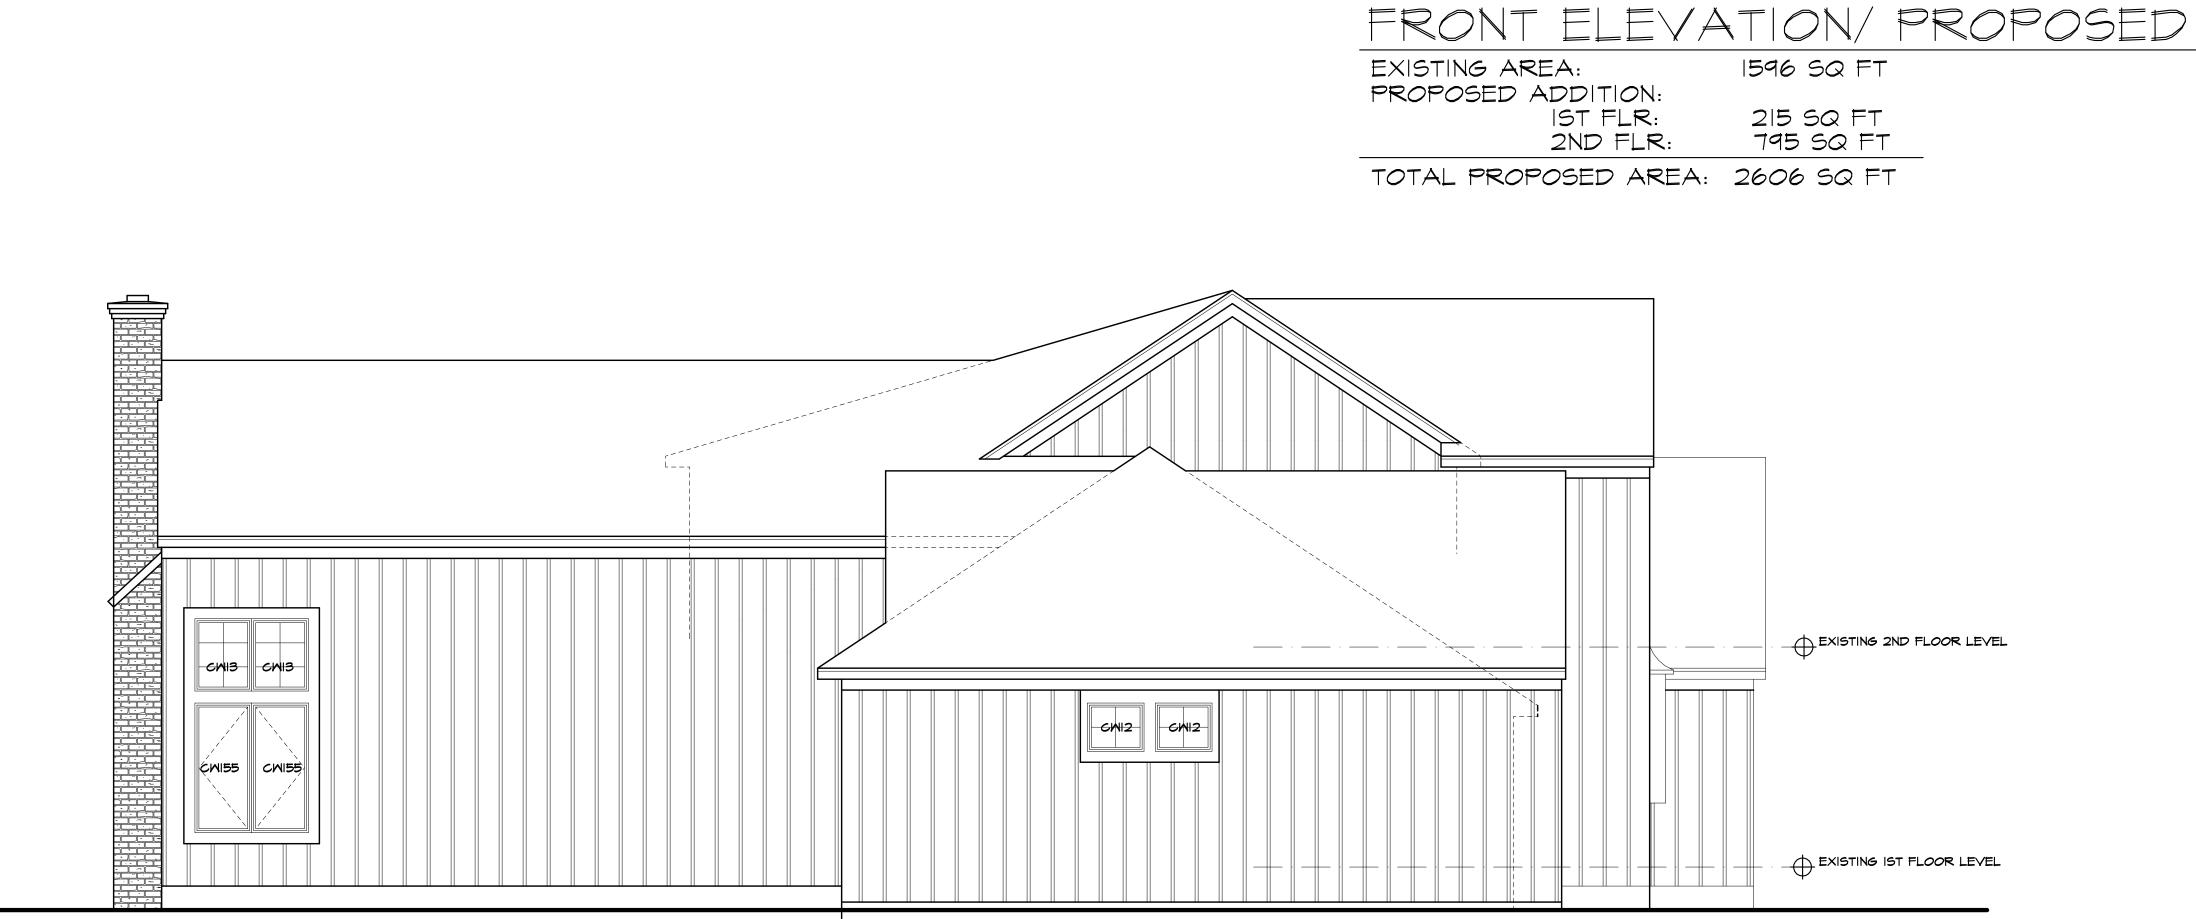
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PROJECT: Addition to Hamilton Reside 25 Parker Driv	
CLIENT: HAMILTON/ STERN BUILDERS	l
DRAWING: SECOND FLOOR EXISTING	PLAN
DRAWN:	CHECKED:
MGM	PJM
DATE: MA	Y 2020
SCALE: 1/4	-"= '-0"
JOB NO.: 20	20HAMILTON
SHEET:	
E	E-4
of 10	SHEETS







PATRICK J. MORABITO **A.I.A.** ARCHITECT

P.C.

55 Sully's Trail Pittsford, NY 14534

(585) 264-1330 (585) 264-1333 Fax

www.pjmarchitect.com

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UNDER SUCH PROTECTION, UNAUTHORIZED USE OF THESE DRAWINGS OR WORK REPRESENTED HEREIN, CAN LEGALLY RESULT IN THE CESSATION OF CONSTRUCTION OR BUILDINGS BEING SEIZED AND/OR MONETARY COMPENSATION TO PATRICK J. MORABITO, A.I.A. ARCHITECT P.C. NO FURTHER USE OR DISTRIBUTION IS ALLOWED WITHOUT THE WRITTEN PERMISSION AND CONSENT OF PATRICK J. MORABITO, A.I.A. ARCHITECT P.C.

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PROJECT: ADDITION TO HAMILTON RESIDENCE 25 PARKER DRIVE

CLIENT: HAMILTON/ STERN BUILDERS

DRAWING:


ELEVATIONS - PROPOSED

DRAWN: CHECKED: PJM MGM DATE: MAY 2020 |/4"=|'-0" SCALE: JOB NO.: 2020HAMILTON SHEET:
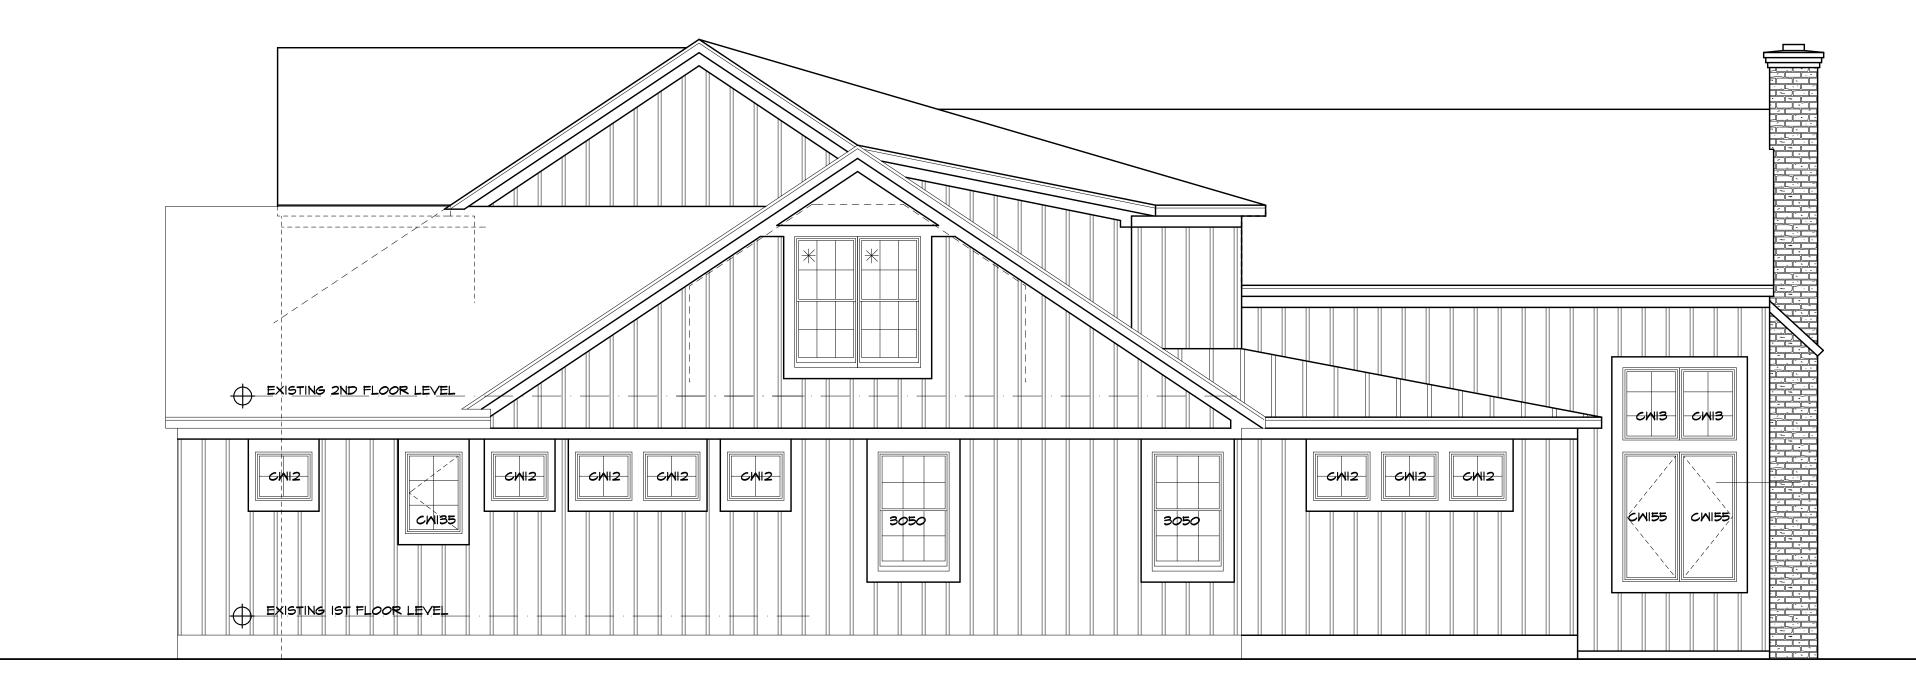
> **A-1** OF **10** SHEETS







REAR ELEVATION/ PROPOSED

RIGHT SIDE ELEVATION/ PROPOSED

PATRICK J. MORABITO A.I.A. ARCHITECT P.C.

55 Sully's Trail Pittsford, NY 14534

(585) 264-1330 (585) 264-1333 Fax

www.pjmarchitect.com

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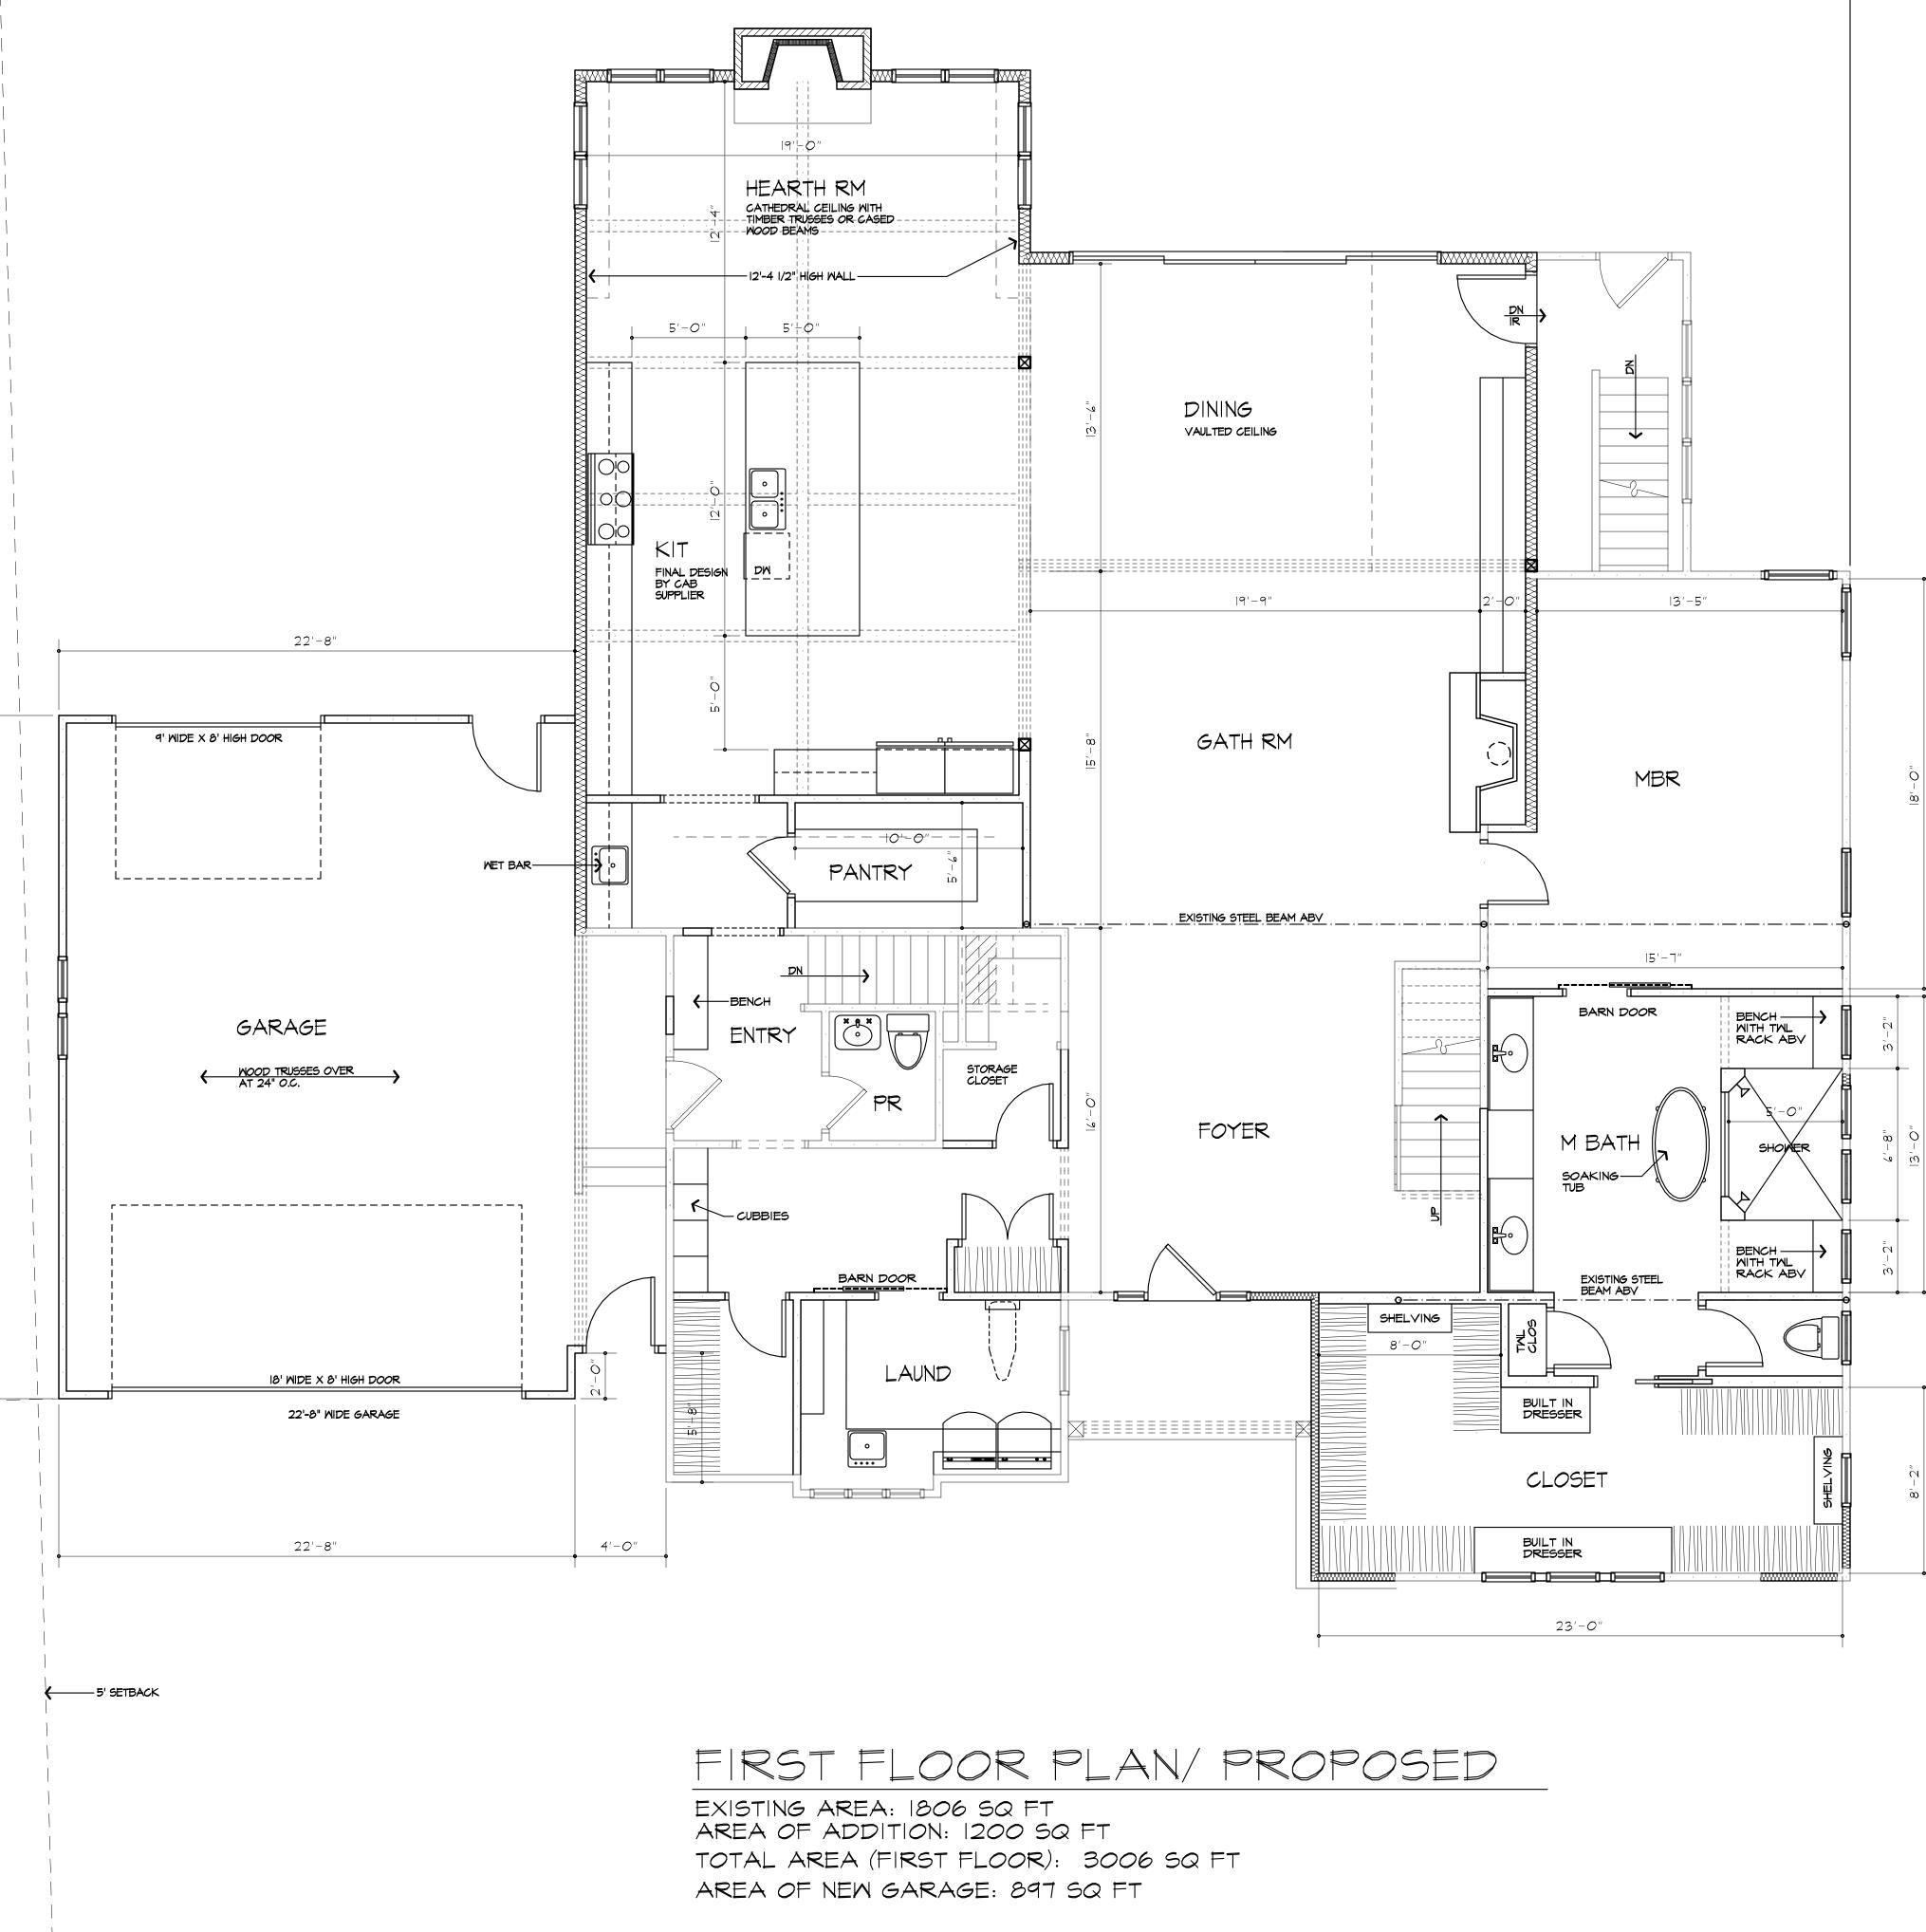
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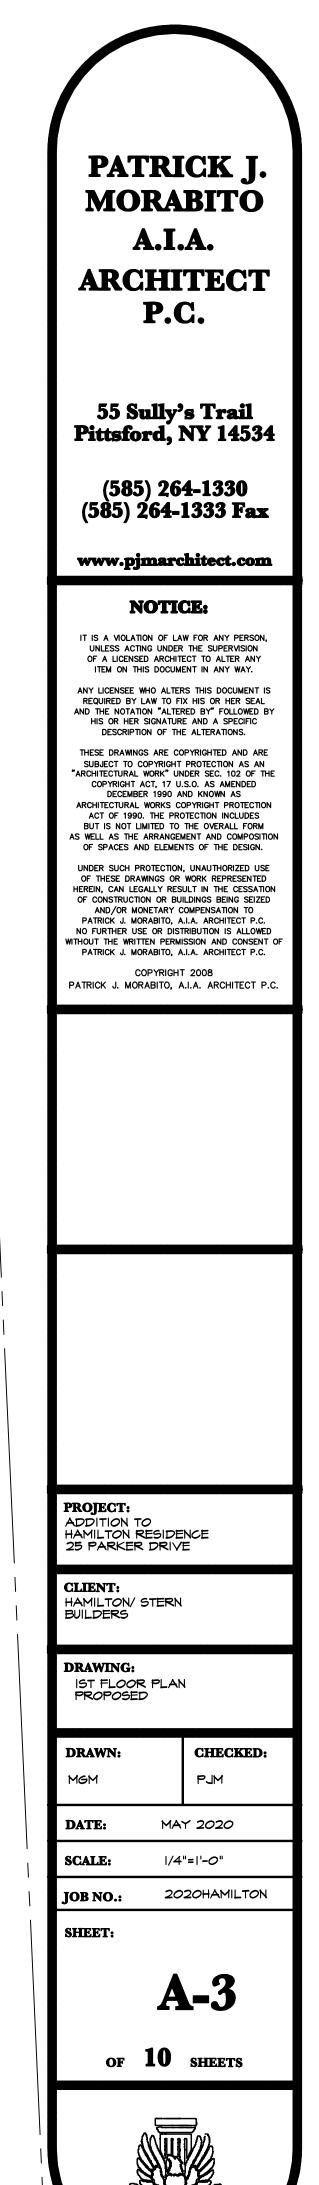
ARCHITECTURAL WORKS COPYRIGHT PROTECTION ACT OF 1990 AND KNOWN AS BUT IS NOT LIMITED TO THE OVERALL FORM AS WELL AS THE ARRANGEMENT AND COMPOSITION OF SPACES AND ELEMENTS OF THE DESIGN. UNDER SUCH PROTECTION, UNAUTHORIZED USE OF THESE DRAWINGS OR WORK REPRESENTED

UNDER SUCH PROTECTION, UNAUTHORIZED USE OF THESE DRAWINGS OR WORK REPRESENTED HEREIN, CAN LEGALLY RESULT IN THE CESSATION OF CONSTRUCTION OR BUILDINGS BEING SEIZED AND/OR MONETARY COMPENSATION TO PATRICK J. MORABITO, A.I.A. ARCHITECT P.C. NO FURTHER USE OR DISTRIBUTION IS ALLOWED WITHOUT THE WRITTEN PERMISSION AND CONSENT OF PATRICK J. MORABITO, A.I.A. ARCHITECT P.C.


PROJECT: ADDITION T HAMILTON F 25 PARKER	RESIDE	
CLIENT: HAMILTON/ BUILDERS	STERN	
DRAWING: ELEVATIO	NS - PF	ROPOSED
ELEVATION DRAWN:	NS - PF	CHECKED:
ELEVATION DRAWN: MGM		CHECKED: PJM
ELEVATION DRAWN: MGM DATE:	MA	CHECKED: PJM Y 2020
ELEVATION DRAWN: MGM DATE: SCALE:	MA` 1/4	CHECKED: PJM Y 2020 "=1'-0"
ELEVATION DRAWN: MGM DATE:	MA` 1/4	CHECKED: PJM Y 2020
ELEVATION DRAWN: MGM DATE: SCALE: JOB NO.:	MA` 1/4 20	CHECKED: PJM Y 2020 "=1'-0" 20HAMILTON
ELEVATION DRAWN: MGM DATE: SCALE: JOB NO.:	MA` 1/4 20	CHECKED: PJM Y 2020 "=1'-0"
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ELEVATION MGM DATE: SCALE: JOB NO.: SHEET:	MA 1/4 20	CHECKED: PJM Y 2020 "=1'-0" 20HAMILTON



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SECOND FLOOR PLAN/ PROPOSED

EXISTING AREA: 787 SQ FT AREA OF NEW ADDITION: 583 SQ FT TOTAL AREA: 1370 SQ FT

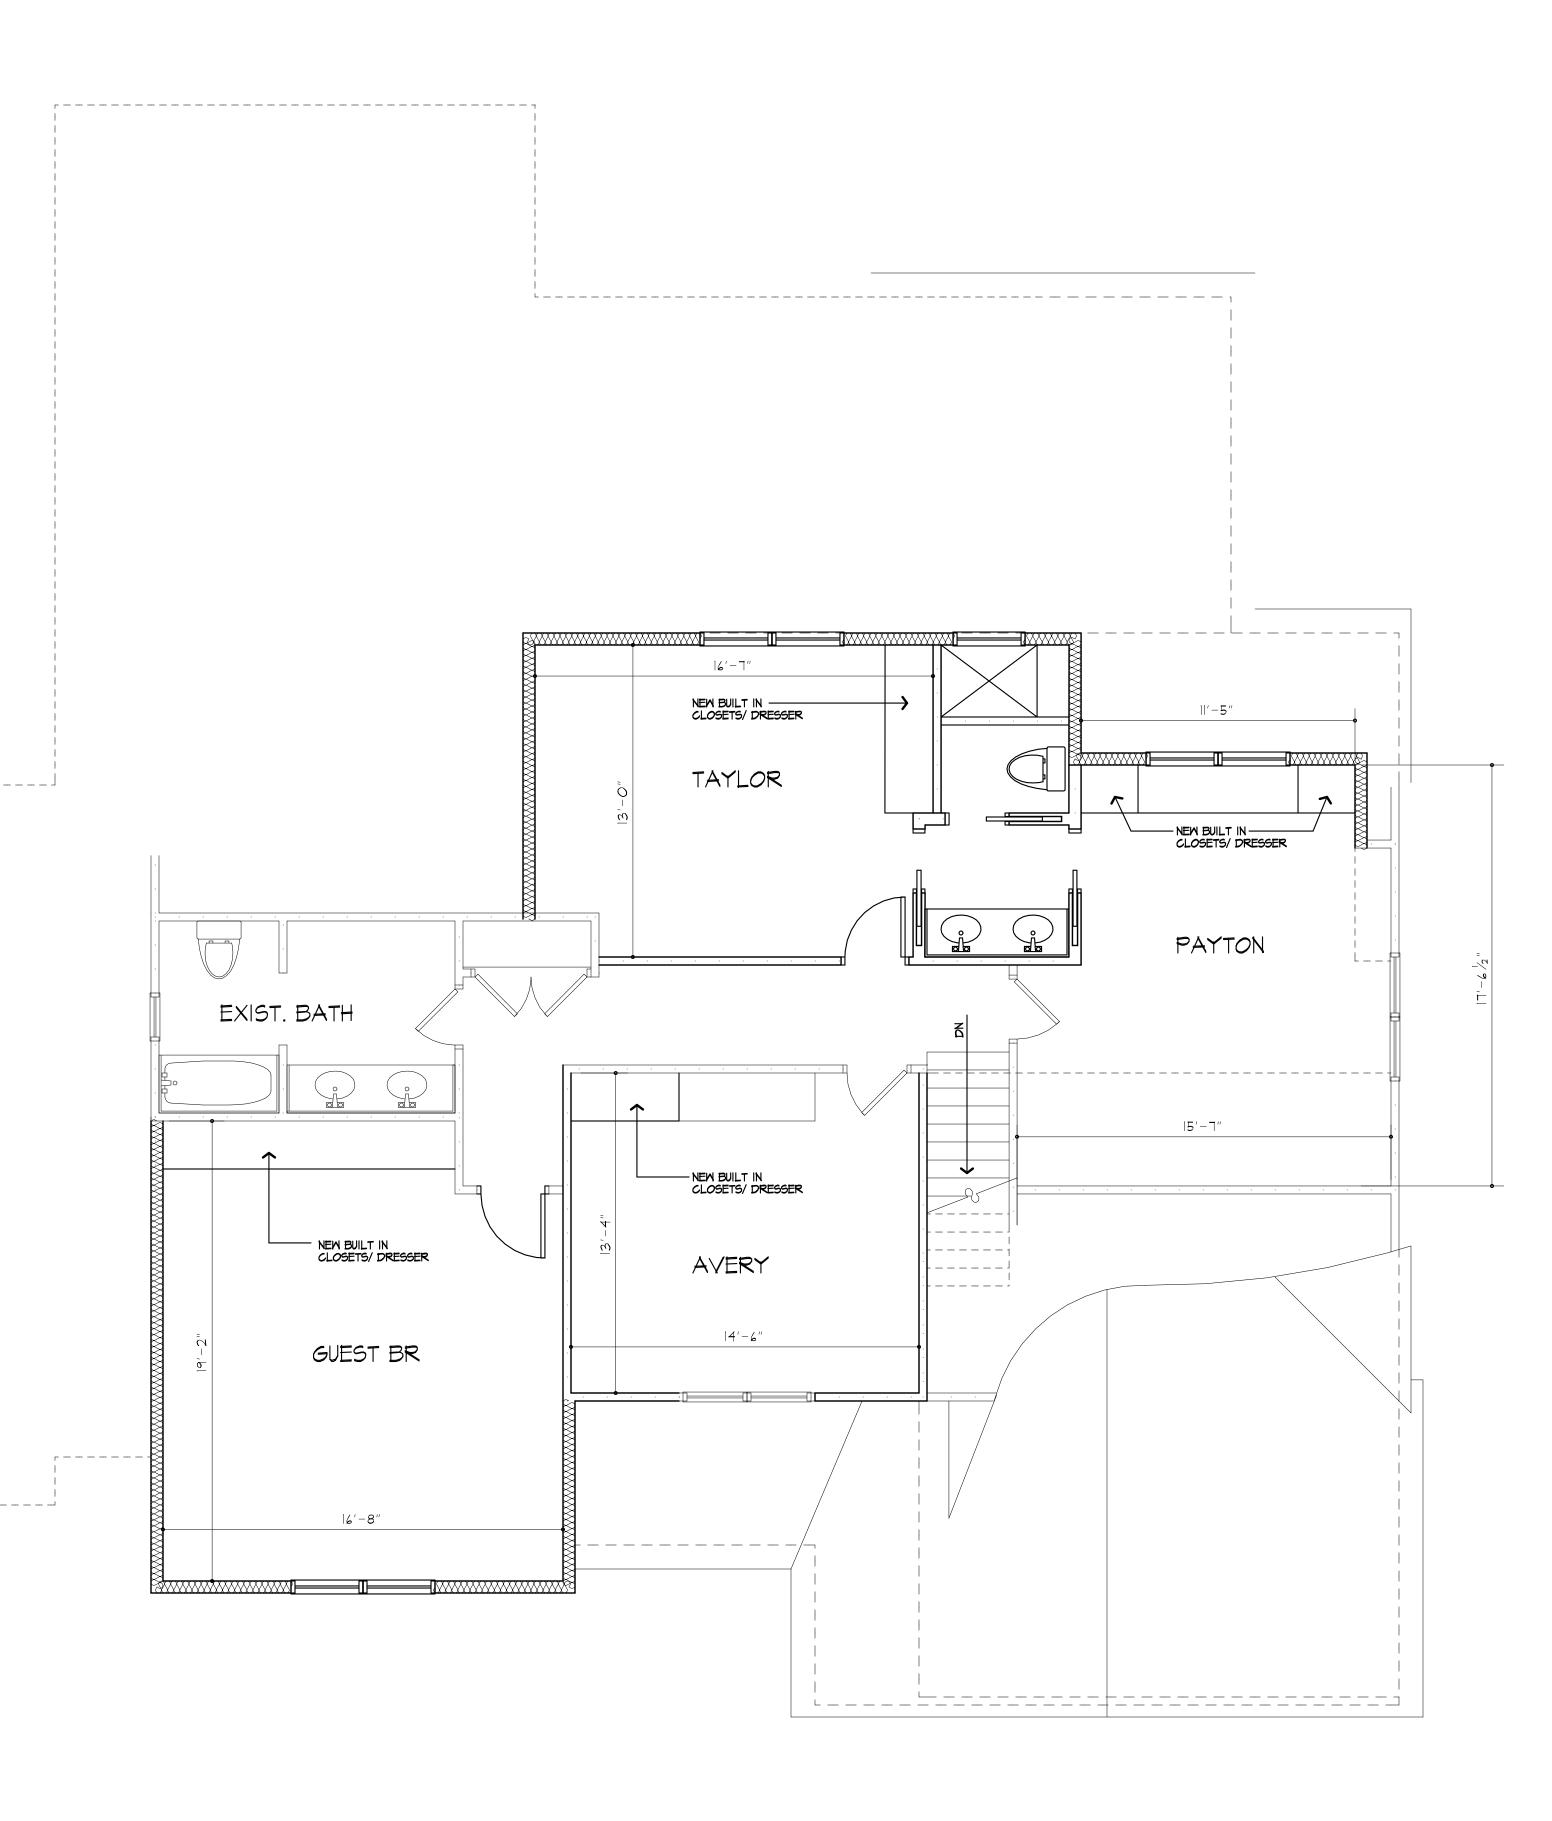PATRICK J. MORABITO **A.I.A.** ARCHITECT **P.C.**

55 Sully's Trail Pittsford, NY 14534

(585) 264-1330 (585) 264-1333 Fax

www.pjmarchitect.com

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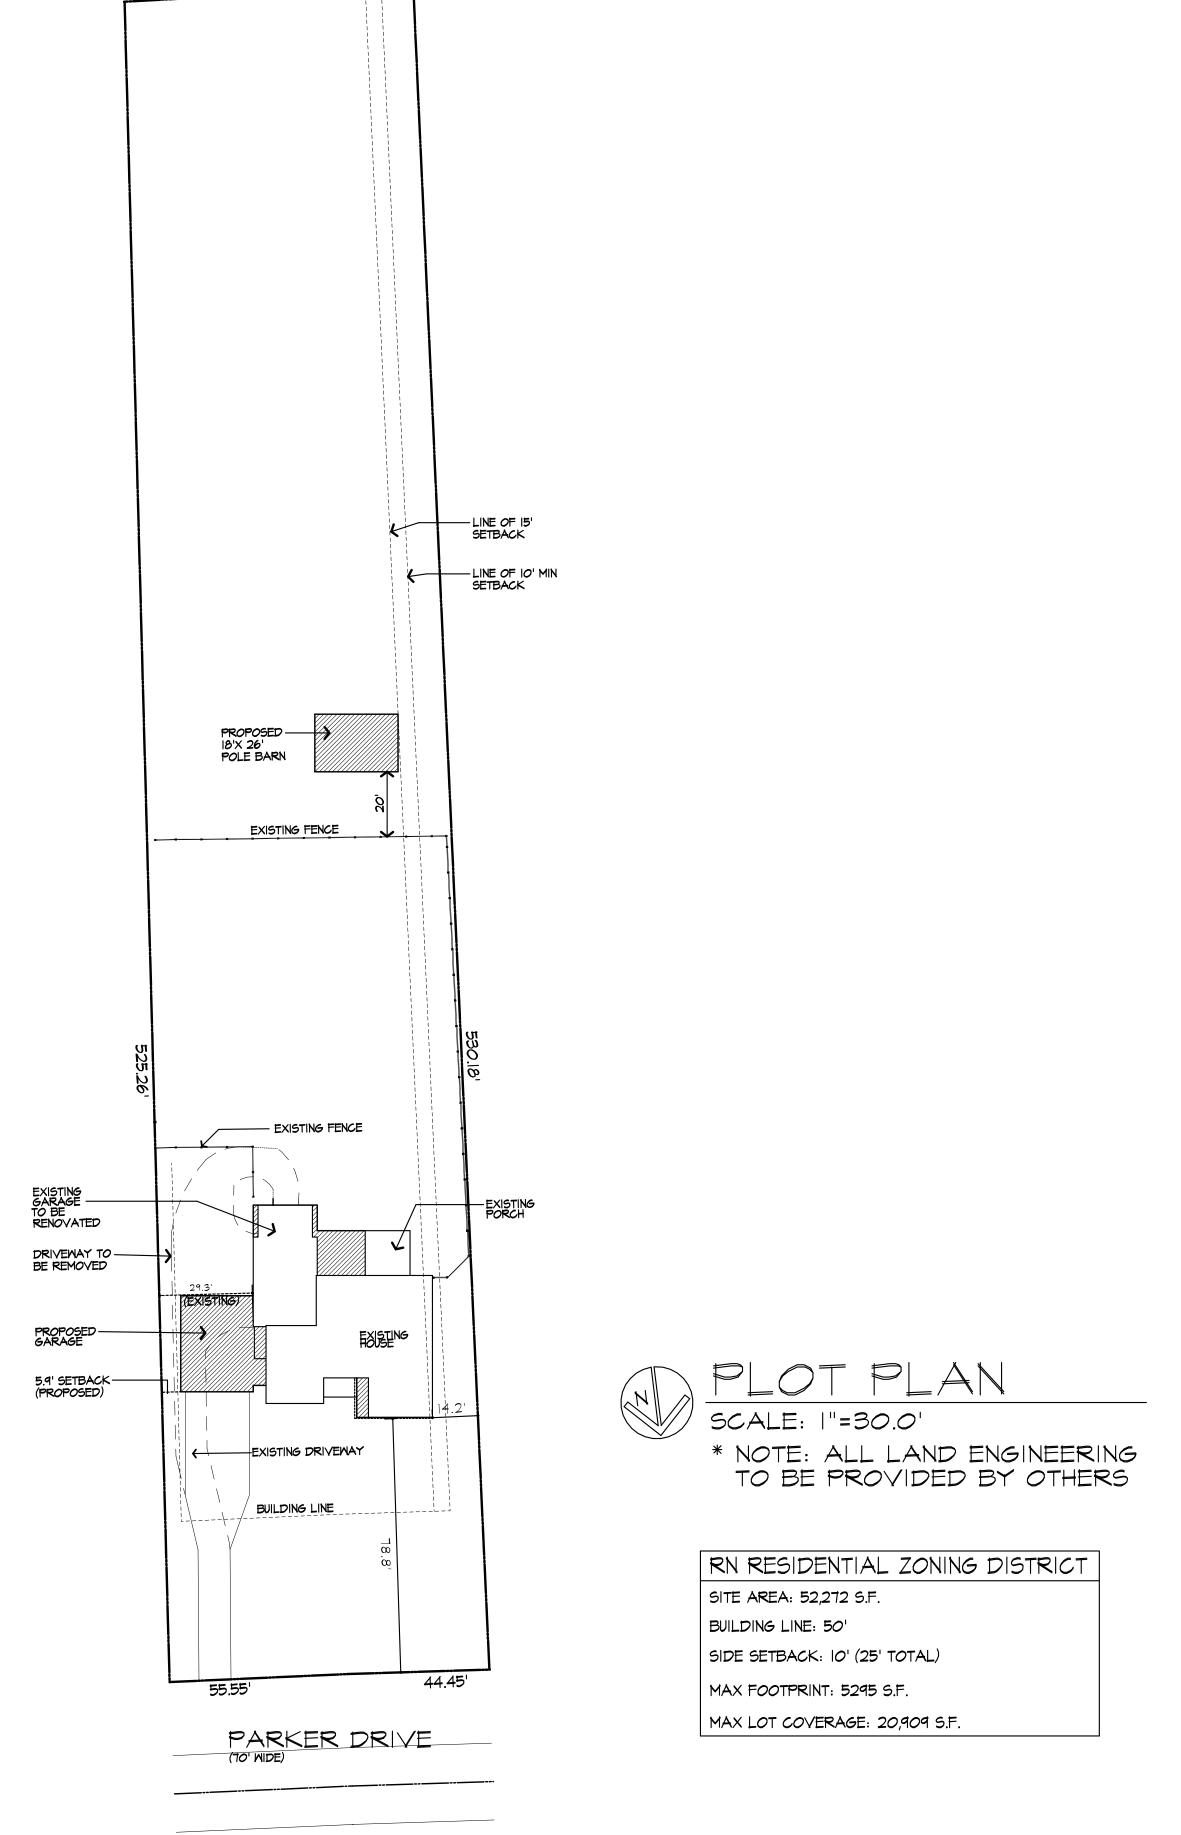
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PROJECT: ADDITION TO HAMILTON RESIDE 25 PARKER DRIV CLIENT: HAMILTON/ STERN BUILDERS	É				
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DDITION TO HAMILTON RESIDENCE 25 PARKER DR - PITTSFORD, NY HAMILTON/ STERN/ BUILDER



90.33'

DRAWING INDEX

1	TITLE PAGE
2	ELEVATIONS - EXISTING
3	1ST FLR PLAN - EXISTING
4	ROOF PLAN - EXISTING
5	F/L ELEVATIONS - PROPOSED
6	BSMT/FOUND PLAN - PROPOSED
7	1ST FLOOR PLAN - PROPOSED
8	2ND FLOOR PLAN - PROPOSED
9	ROOF PLAN - PROPOSED
10	BUILDING SECTIONS

DRAWING REFERENCE

THE FOLLOWING RESOURCES WERE USED BY THE ARCHITECT IN THE PREPARATION OF THESE DOCUMENTS :

- ARCHITECTURAL DRAWINGS FOR THE RESIDENCE, LABELED "EASTMAN KODAK CO. DEVELOPMENT DEPARTMENT" - UNKNOWN DATE
- 2. FIELD MEASUREMENTS, OBSERVATION, AND DIGITAL PHOTOGRAPHY PROVIDED BY THE OWNER

3. SEVERAL ASSUMPTIONS WERE MADE BY THE ARCHITECT WITH REGARD TO THE CONSTRUCTION OF THE EXISTING STRUCTURE AND THE SIZE OF STRUCTURAL MEMBERS NOT EXPOSED TO VIEW. THEREFORE, THE CONTRACTOR IS REQUIRED TO VERIFY ALL EXISTING CONDITIONS AND REPORT ANY DISCREPENCIES TO THE ARCHITECT FOR CLARIFICATION/ ADJUSTMENTS NEEDED

BASIC DESIGN CRITERIA

- CROUND SNOW LOAD 40 PSF R301.2 (5)
- 2. WIND SPEED 90 MPH, EXPOSURE B R301.2 (4)
- 3 SEISMIC DESIGN CATEGORY A R301.2 (2)
- 4. WEATHERING SEVERE R301.2 (3)
- 5. FROST LINE DEPTH 48"
- 6. TERMITE DAMAGE NONE TO SLIGHT R301.2 (6)
- DECAY DAMAGE NONE TO SLIGHT R301.2 (7)
- 8. WINTER DESIGN TEMPERATURE I
- 9. ICE SHIELD UNDERLAYMENT REQUIRED YES
- O. FLOOD HAZARD FIRM 1992
- II. ROOF TIE DOWN REQUIREMENTS ROO2.II.I
- 12. ENERGY COMPLIANCE PATH RESCHEK

PATRICK J. MORABITO A.I.A. ARCHITECT P.C.

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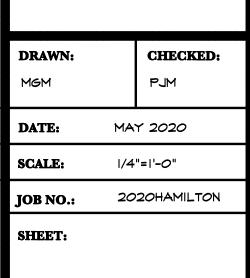
PATRICK J. MORABITO, A.I.A. ARCHITECT P.C


PROJECT: ADDITION TO HAMILTON RESIDENCE 25 PARKER DRIVE


CLIENT: HAMILTON/ STERN BUILDERS

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TITLE PAGE





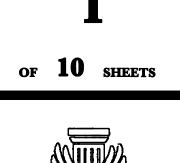

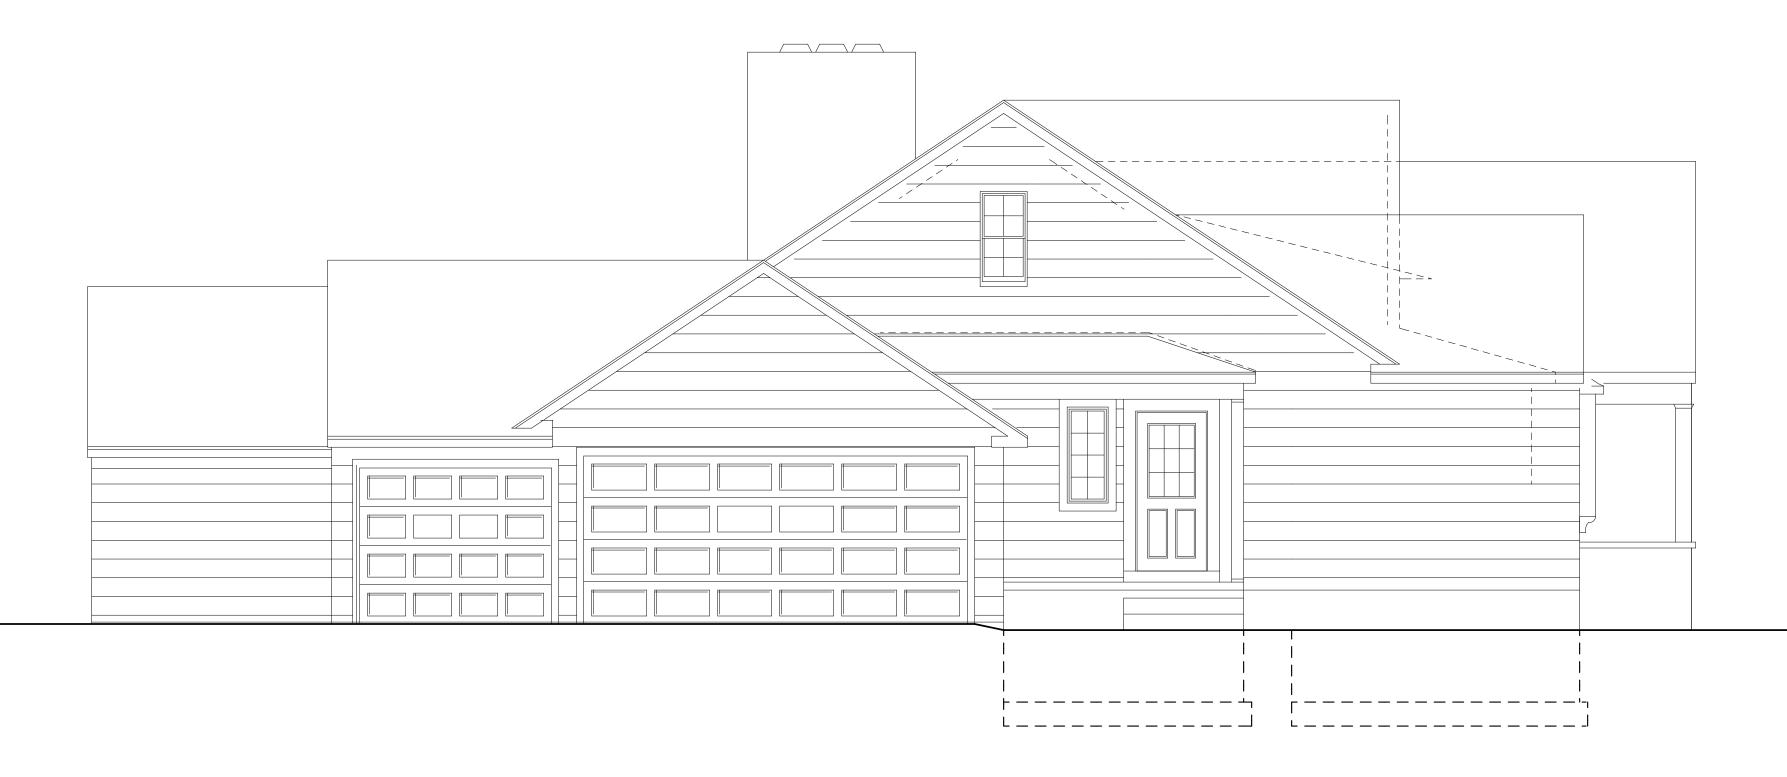







WITH REMOVALS SHOWN

PATRICK J. MORABITO **A.I.A.** ARCHITECT

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PROJECT: ADDITION HAMILTON 25 PARKE	RESIDENCE	
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REAR ELEVATION/ EXISTING



WITH REMOVALS SHOWN



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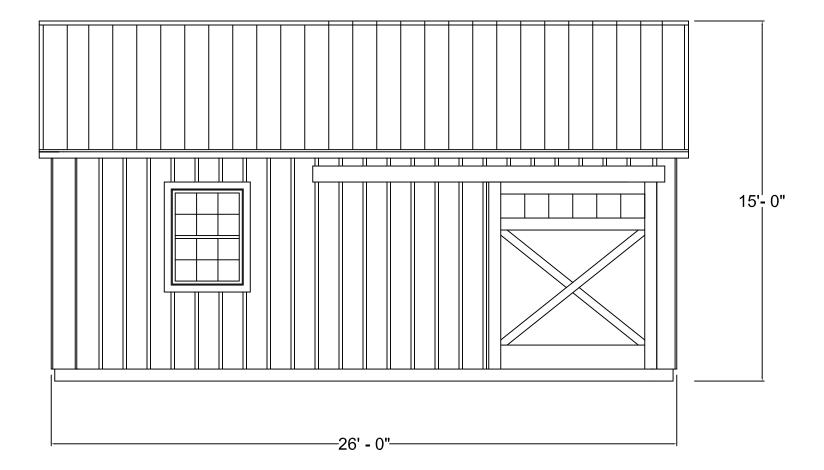
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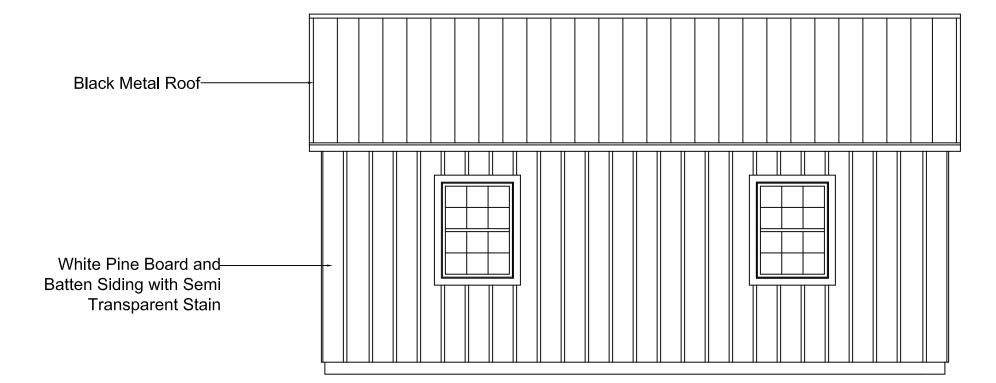
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NORTH Elevation

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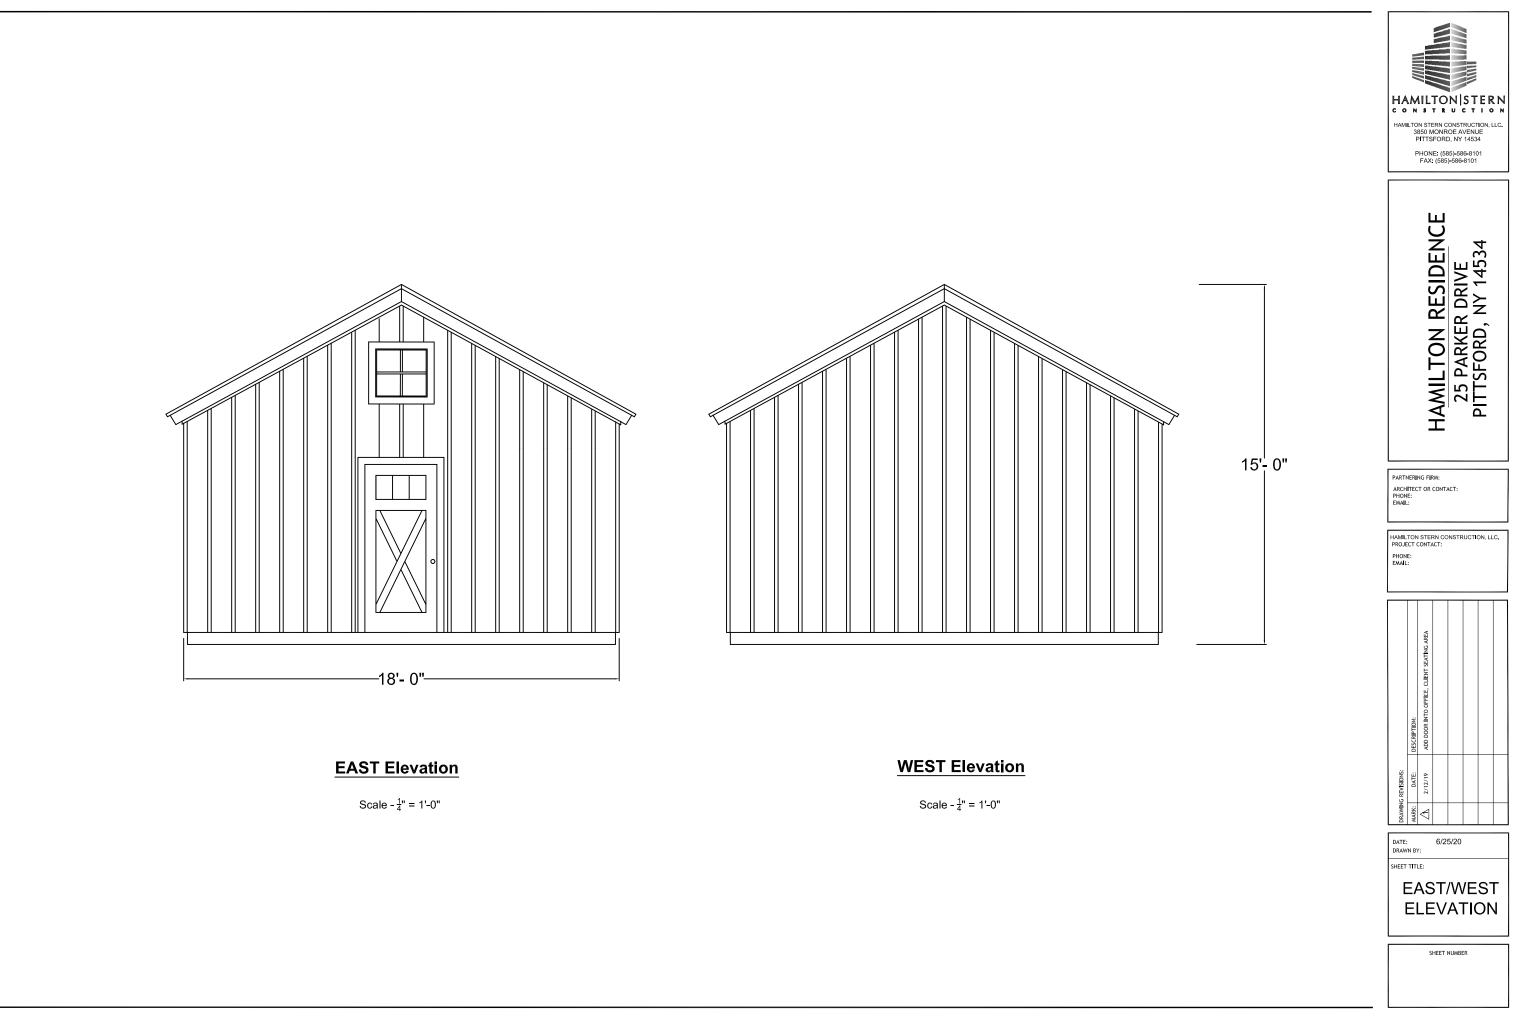
HAMILTON STERN CONSTRUCTION, LLC. 3850 MONROE AVENUE PITTSFORD, NY 14534 PHONE: (825):586-8101 FAX: (585):586-8101							
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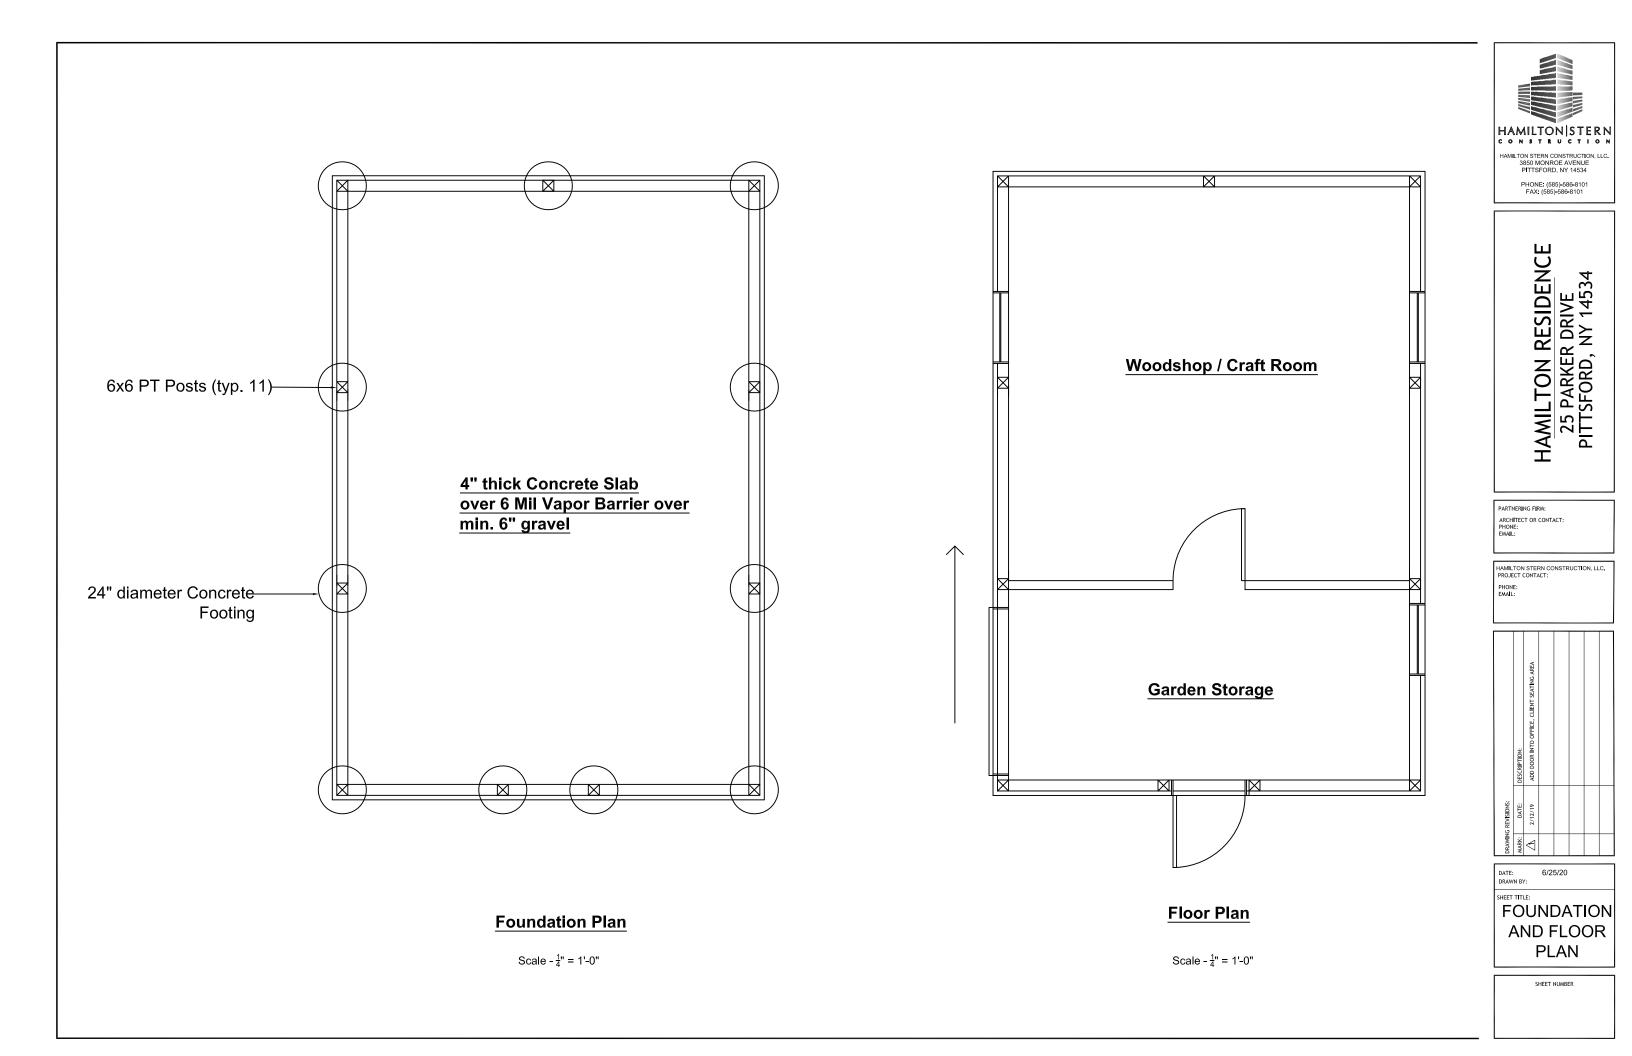


SOUTH Elevation

Scale - ¹/₄" = 1'-0"

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Town of Pittsford

Department of Public Works 11 South Main Street Pittsford, New York 14534

Permit # S20-000012

Phone: 585-248-6250 FAX: 585-248-6262

DESIGN REVIEW AND HISTORIC PRESERVATION BOARD REFERRAL OF APPLICATION

Property Address: 3001 Monroe Avenue ROCHESTER, NY 14618 Tax ID Number: 150.08-1-71.1 Zoning District: C Commercial **Owner:** Monroe Clover Plaza LLC (Blonsky Family Chiropractic) Applicant: Mcallister Signs LLC

Application Type:

- **Residential Design Review** §185-205 (B)
- **Commercial Design Review** \square
- §185-205 (B) Signage
- \checkmark §185-205 (C)
- Certificate of Appropriateness \square §185-197
- Landmark Designation
- \square §185-195 (2)

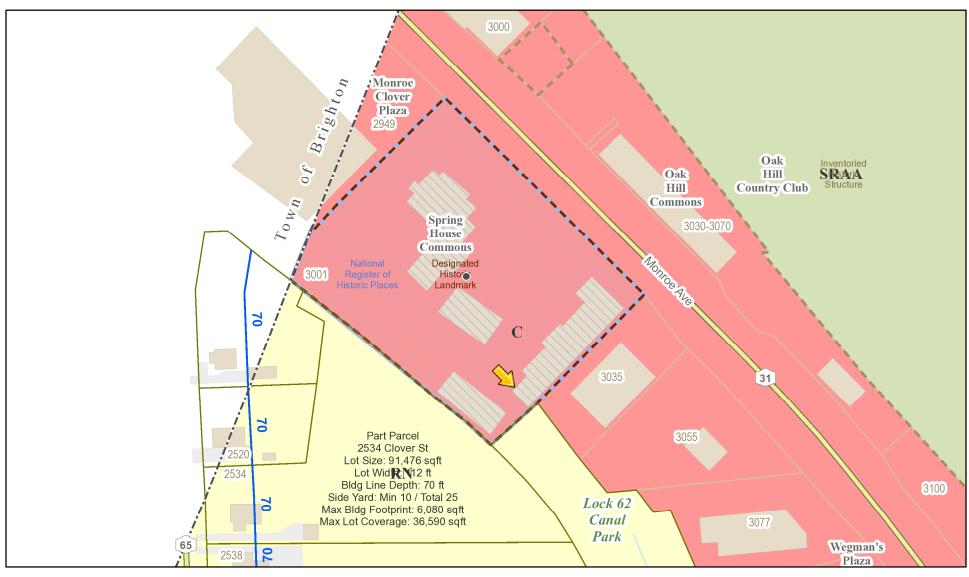
- Build to Line Adjustment
- §185-17 (B) (2)
- **Building Height Above 30 Feet** §185-17 (M)
- **Corner Lot Orientation**
- §185-17 (K) (3)
- Flag Lot Building Line Location §185-17 (L) (1) (c)
- **Undeveloped Flag Lot Requirements** \square
 - §185-17 (L) (2)

Informal Review \square

Project Description: Applicant is requesting design review for the addition of a business identification sign. The sign will be approximately 10.5 sq. ft. and will identify "Blonsky Family Chiropractic".

Meeting Date: July 23, 2020


RN Residential Neighborhood Zoning



Printed July 16, 2020

Town of Pittsford GIS

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Dimensional Exterior

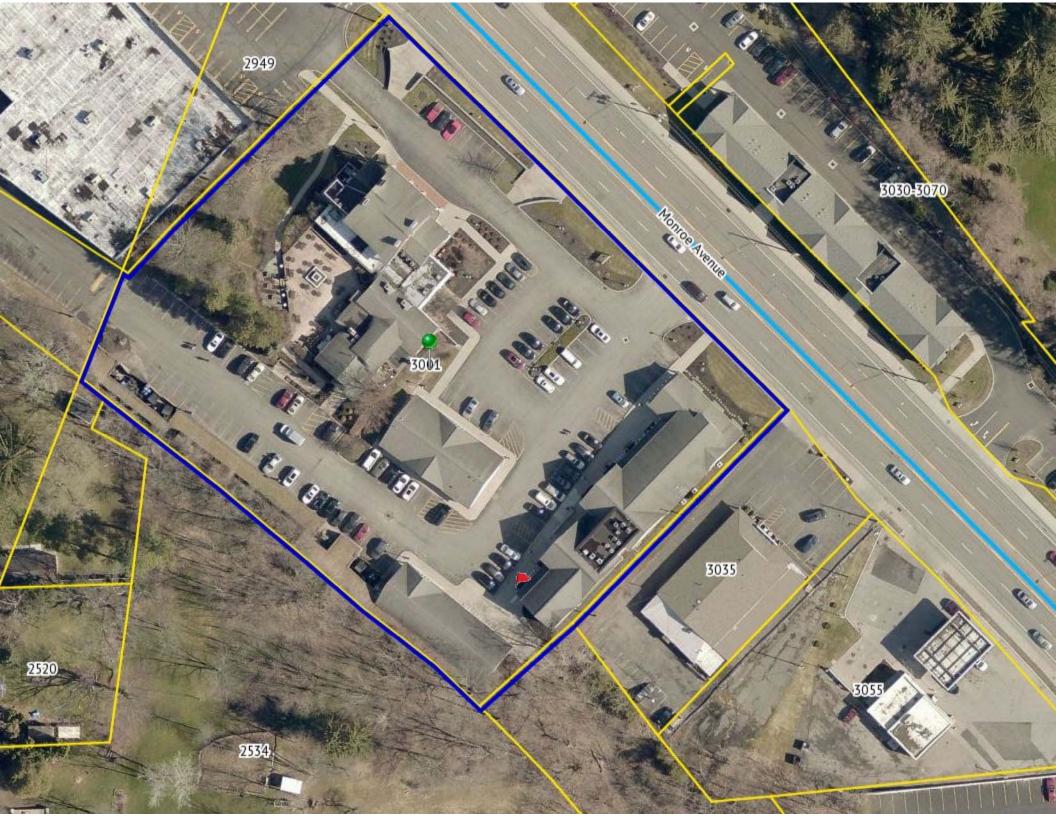